NORTHSHORE UTILITY DISTRICT

King County, Washington

CONTRACT 2023-02

WOODLAND COVE WATER SERVICE REPLACEMENT AND 130/66 WATER MAIN REPLACEMENT MARCH, 2023 - BID SET



11255 Kirkland Way, Suite 300 Kirkland, WA 98033 p. 425.827.2014 | f. 425.827.5043

Civil | Structural | Planning | Survey www. paceengrs.com



PACE QA/QC REVIEW
THESE DOCUMENTS HAVE BEEN REVIEWED BY:


NAME: H P PAULSEN DATE: 2/21/2023

SUZANNE GREATHOUSE President of the Board TRUDY C. ROLLA Secretary of the Board MATT BREYSSE Commissioner

D. BRUCE GARDINER Commissioner
THOMAS D. MORTIMER Commissioner

AMANDA CAMPBELL Acting General Manager

	SHEET INDEX	
SHEET NO.	TITLE	
1	COVER	
2	GENERAL NOTES	
3	SCHEDULE A PHASING PLAN	
4	SCHEDULE A PHASE 1	
5	SCHEDULE A PHASE 1	
6	SCHEDULE A PHASE 1	
7	SCHEDULE A PHASE 1	
8	SCHEDULE A PHASE 2	
9	SCHEDULE A PHASE 2	
10	SCHEDULE A PHASE 2	
11	SCHEDULE A PHASE 2	
12	TEMPORARY WATER SERVICE PLAN	
13	SCHEDULE B PLAN 1	
14	SCHEDULE B PROFILE 1	
15	SCHEDULE B PLAN 2	
16	SCHEDULE B PROFILE 2	
17	SCHEDULE B PROFILE 2	
18	SCHEDULE B PLAN 3	
19	SCHEDULE B PROFILE 3	
20	SCHEDULE B RESTORATION PLAN 1	
21	SCHEDULE B RESTORATION PLAN 2	
22	SCHEDULE B RESTORATION PLAN 3	
23	DETAILS	
24	DETAILS	

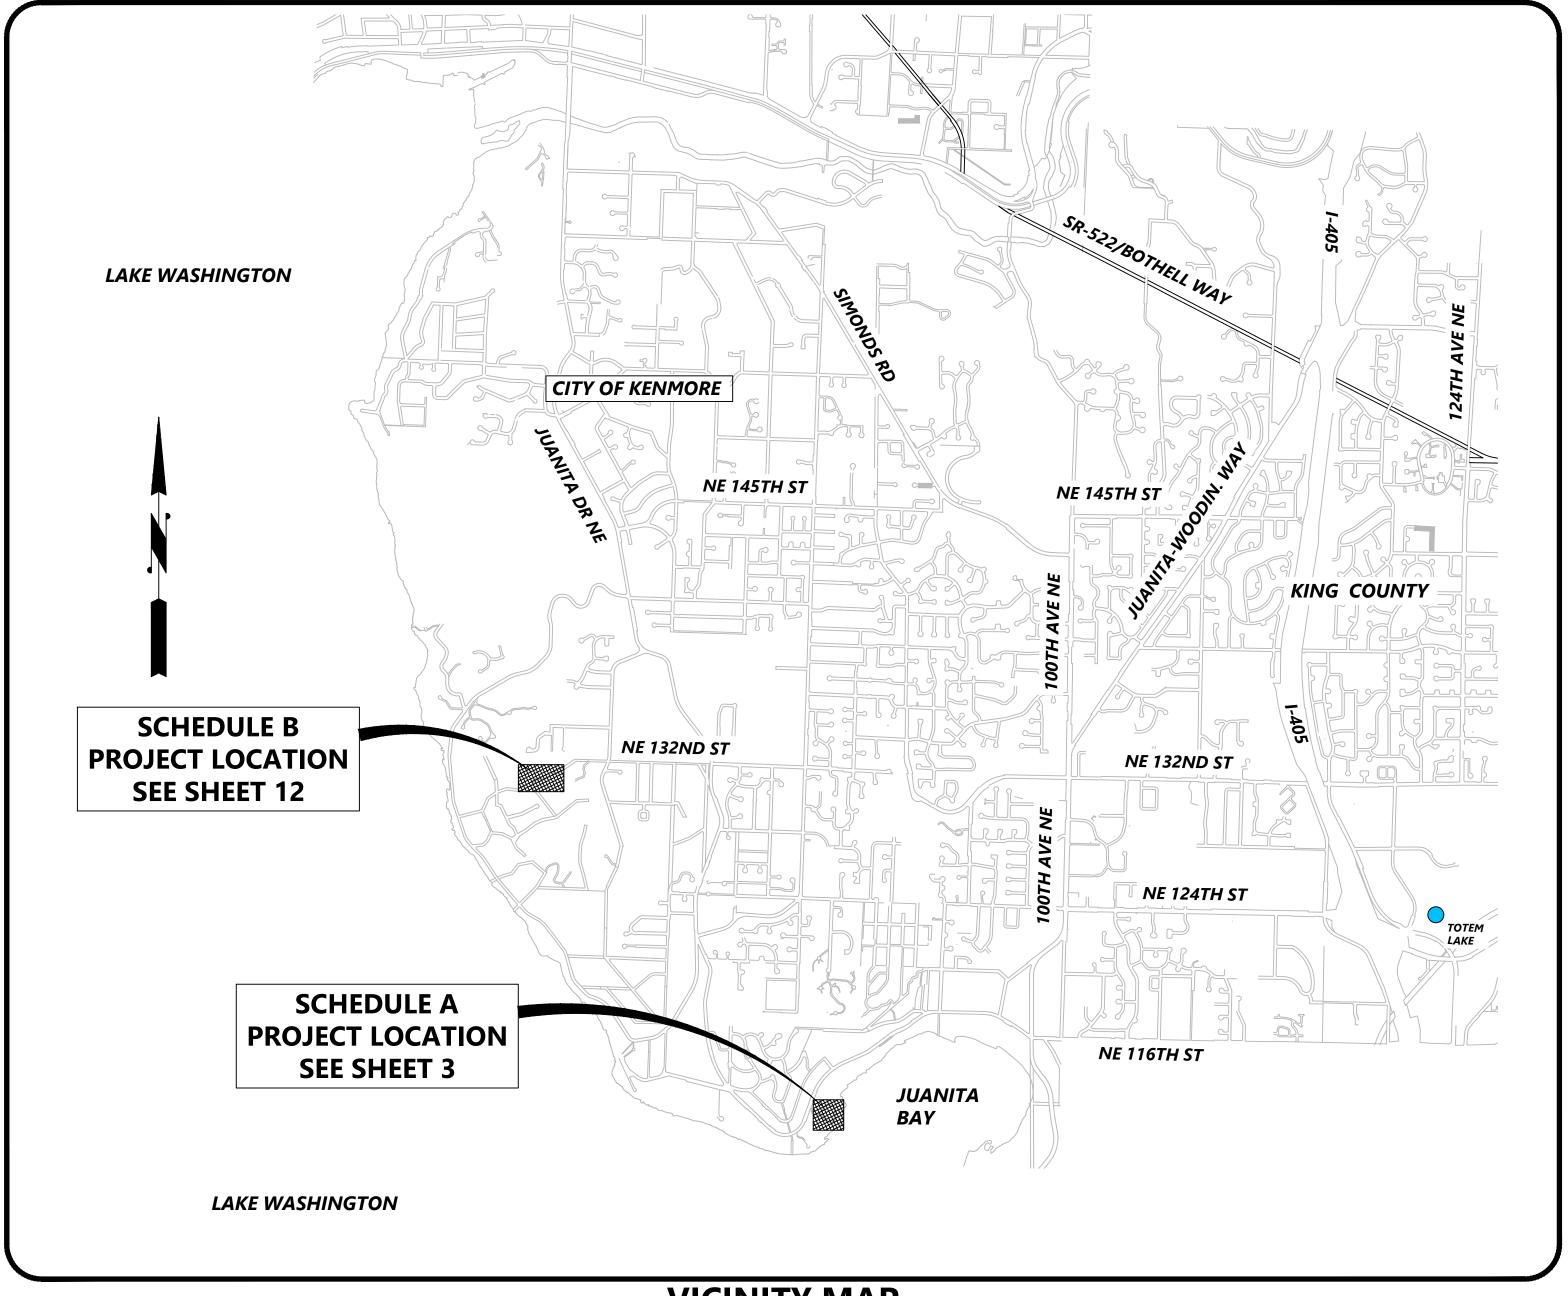

C1817

SHEET 1_ OF <u>24</u>

VICINITY MAP

NOT TO SCALE

LEGEND

	1	
EXISTING	PROPOSED	DESCRIPTION PROPERTY LINE
		RIGHT OF WAY LINE
		DITCH CENTERLINE
		SIDE SLOPE
<u> </u>		FIRE DEPARTMENT CONNECTION
		DOUBLE CHECK VALVE
—— F —— F ——		FIRE PROTECTION LINE
8" DI W		WATER LINE
8" PVC SS		SANITARY SEWER LINE
— - SD — - SD —		STORM DRAIN LINE
> 12" CONCRETE — SD — <		STORM DRAIN CULVERT
FL		SWALE OR DITCH
G		GAS LINE
——————————————————————————————————————		UNDERGROUND POWER LINE
OHP		OVERHEAD POWER LINE
		TELEPHONE LINE
c		CABLE LINE
——————————————————————————————————————		FIBER OPTIC LINE
		WIRE FENCE
xxxxx		
		WOOD FENCE
		CHAIN LINK FENCE
=		WATER METER
- ()-	φ	FIRE HYDRANT
	;101; 10E 10E	WATER VALVE
\$	₽	BLOW OFF ASSEMBLY
0		CLEAN OUT
<u> </u>	•	SANITARY MANHOLE
		STORM DRAIN MANHOLE
		STORM DRAIN CATCH BASIN
D		GAS VALVE
-0-		POWER POLE
\leftarrow		GUY ANCHOR
♦ ——XX		LIGHT POLE
(C = >		SIGNAL POLE
Р		ELECTRICAL VAULT
<u> </u>		ELECTRICAL HANDHOLE
•		COMMUNICATIONS VAULT
		TELEPHONE HANDHOLE
<u>-</u> _ <u>_</u>		SIGN
<u> </u>		MONUMENT
		ROCKERY
~~~		
		ROCK WALL
		MAIL BOX(ES)
o de la companya de l		CONIFER TREE
~~~		DECORATIVE TREE
(·)		DECIDUOUS TREE
⊖		SHRUB
		RETAINING WALL
1. 1. 1. 1. 1. 1. 1. 1. 1. 1. 1. 1. 1. 1		CEMENT CONCRETE PAVEMENT
		CEMENT CONCRETE CURB, GUTTER
7//////////////////////////////////////		ASPHALT CONCRETE PAVEMENT
		GRAVEL
		GRASS
<u>Lade de de de</u>		FILTER FABRIC FENCE
	_	CATCHBASIN INLET PROTECTION
	_	PROPERTY ADDRESS
NAME		THOLENTI ADDINESS

GENERAL NOTES:

- 1. ALL CONSTRUCTION AND MATERIALS SHALL BE IN ACCORDANCE WITH THE REQUIREMENTS SPECIFIED IN THE CURRENT NORTHSHORE UTILITY DISTRICT STANDARD SPECIFICATIONS AND STANDARD DETAILS.
- 2. THE APPROXIMATE LOCATIONS OF EXISTING UTILITIES ARE SHOWN ON THE PLANS FOR CONVENIENCE. THE CONTRACTOR SHALL BE RESPONSIBLE FOR VERIFICATION OF UTILITY LOCATIONS SHOWN, FOR THE PROTECTION AND REPAIR OF DAMAGED UTILITIES AND FOR THE DISCOVERY OF POSSIBLE ADDITIONAL UTILITIES NOT SHOWN ON THE PLANS. IT SHALL BE THE RESPONSIBILITY OF THE CONTRACTOR TO HAVE LOCATED, BY THE APPROPRIATE UTILITY DISTRICTS OR COMPANIES, ALL UNDERGROUND UTILITIES PRIOR TO BEGINNING CONSTRUCTION. FOR UTILITY LOCATES IN KING COUNTY, CALL 1-800-424-5555 PRIOR TO DIGGING.
- 3. A PRE-CONSTRUCTION CONFERENCE WILL BE HELD AT THE DISTRICT OFFICE PRIOR TO START OF CONSTRUCTION.
- 4. THE CONTRACTOR SHALL NOTIFY NORTHSHORE UTILITY DISTRICT A MINIMUM OF FIVE (5) DAYS IN ADVANCE OF BEGINNING CONSTRUCTION. CONSTRUCTION SHALL NOT BEGIN WITHOUT PRIOR WRITTEN NOTICE TO PROCEED BY THE DISTRICT.
- 5. THE CONTRACTOR SHALL NOT OPERATE ANY VALVES OR MAKE ANY CONNECTIONS TO THE EXISTING WATER SYSTEM WITHOUT PRIOR APPROVAL FROM THE DISTRICT.

SURVEY CONTROL DATA

<u>HORIZONTAL DATUM:</u>

WASHINGTON STATE COORDINATE SYSTEM, NORTH ZONE NAD83(91), US FEET UTILIZING RTK GPS FIELD PROCEDURES

CONTOUR INTERVAL: (2') TWO FOOT CONTOURS

VERTICAL DATUM: NAVD88, US FEET AS PRESCRIBED BY NORTHSHORE UTILITY DISTRICT.


UTILITIES MAPPING:

ALL EXISTING UTILITIES SHOWN HEREIN ARE TO BE VERIFIED HORIZONTALLY AND VERTICALLY PRIOR TO ANY CONSTRUCTION. ALL EXISTING FEATURES INCLUDING BURIED UTILITIES ARE SHOWN AS INDICATED BY RECORD LOCATION OR FIELD TIED AS A RESULT OF A UTILITY PAINT—OUT DURING THE COURSE OF THE FIELD SURVEY. DUANE HARTMAN & ASSOCIATES, INC. (DHA) ASSUMES NO LIABILITY FOR THE ACCURACY OF THE RECORD INFORMATION. FOR THE FINAL LOCATION OF THE EXISTING UTILITIES IN AREAS CRITICAL TO CONSTRUCTION, CONTACT THE UTILITY OWNER/AGENCY AND UTILITIES UNDERGROUND CENTER (800/424—5555).

<u>TOPOGRAPHIC MAPPING:</u>


THE MAP SHOWN HEREON IS THE RESULT OF A TOPOGRAPHIC SURVEY BY DUANE HARTMAN & ASSOCIATES, INC. (DHA) COMPLETED ON OCTOBER 2018. DHA ASSUMES NO LIABILITY, BEYOND SAID DATE, FOR ANY FUTURE SURFACE FEATURE MODIFICATIONS OR CONSTRUCTION ACTIVITIES THAT MAY OCCUR WITHIN OR ADJOINING THE PERIMETER OF THIS SURVEY. CONTACT DHA (425) 483–5355 FOR SITE UPDATES AND VERIFICATIONS.


BENCHMARKS:

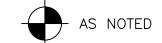

TEMPORARY EROSION AND SEDIMENTATION CONTROL NOTES

- 1. THE TEMPORARY EROSION AND SEDIMENTATION CONTROL (TESC) FACILITIES SHALL BE IMPLEMENTED PRIOR TO THE START OF ANY CONSTRUCTION ACTIVITIES, AND IN SUCH A MANNER AS TO ENSURE THAT SEDIMENT WATER DOES NOT ENTER THE DRAINAGE SYSTEM OR VIOLATE APPLICABLE WATER STANDARDS. MAINTENANCE, REPLACEMENT, AND UPGRADING OF THESE TESC FACILITIES IS THE RESPONSIBILITY OF THE CONTRACTOR UNTIL ALL CONSTRUCTION IS APPROVED.
- 2. THE STORM DRAIN INLET PROTECTION DEVICE SHALL BE SILT SACK OR EQUAL. ALL CATCH BASINS WITHIN THE VICINITY OF THE CONSTRUCTION SHALL HAVE INLET PROTECTION MEASURES.
- 3. CONTRACTOR SHALL MAINTAIN ALL EXISTING DRAINAGE CHANNELS, CULVERTS, SWALES AND STRUCTURES. WHENEVER EXISTING DRAINAGE FACILITIES ARE DISTURBED, THE CONTRACTOR SHALL PROVIDE SUITABLE MEANS FOR DIVERTING AND MAINTAINING ALL FLOWS DURING CONSTRUCTION IN THAT AREA AT ITS EXPENSE. AFTER CONSTRUCTION HAS BEEN COMPLETED, ALL DRAINAGE CHANNELS, CULVERTS, SWALES AND STRUCTURES DISTURBED SHALL BE RETURNED TO THEIR ORIGINAL CONDITIONS.
- 4. THE TESC FACILITIES SHOWN ON THIS PLAN ARE THE MINIMUM REQUIREMENTS FOR ANTICIPATED SITE CONDITIONS. DURING THE CONSTRUCTION PERIOD, TESC FACILITIES SHALL BE MAINTAINED AND UPGRADED AS NECESSARY BY THE CONTRACTOR.
- 5. CONTRACTOR SHALL INSPECT THE TESC FACILITIES AT THE END OF EACH WORKING DAY TO ASSURE ITSELF THAT THEY ARE IN GOOD CONDITIONS. IF TESC FACILITIES REQUIRE REPAIR/MAINTENANCE, IT SHALL BE PERFORMED PRIOR TO THE END OF THE WORKING DAY. ALL DISTURBED AREAS SHALL BE PROMPTLY AND THOROUGHLY STABILIZED AGAINST EROSION DURING PERIODS OF WET WEATHER WHEN WORK IS NOT BEING PERFORMED AT THE SITE.
- 6. ALL UNSUITABLE OR SURPLUS EXCAVATED OR CLEARED MATERIAL SHALL BE REMOVED FROM THE SITE AND DISPOSED OF IN AN APPROVED, LEGAL FILL SITE. IT SHALL BE THE CONTRACTOR'S RESPONSIBILITY TO LOCATE ACCEPTABLE DISPOSAL SITES AND ASSURE THAT ALL SURPLUS MATERIAL IS DISPOSED OF IN SAME.
- 7. CONTRACTOR SHALL BE RESPONSIBLE FOR IMPLEMENTING ALL APPROPRIATE MEASURES NEEDED (STREET SWEEPERS, WATER TRUCKS, ETC.) TO KEEP STREETS AND ROADS USED AS HAUL ROUTES FOR EXPORT OR IMPORT OF MATERIAL CLEAN AND FREE FROM DEBRIS, MUD, ETC.. ADDITIONAL MEASURES MAY BE REQUIRED TO ENSURE THAT ALL PAVED AREAS ARE KEPT CLEAN FOR THE DURATION OF THE PROJECT.

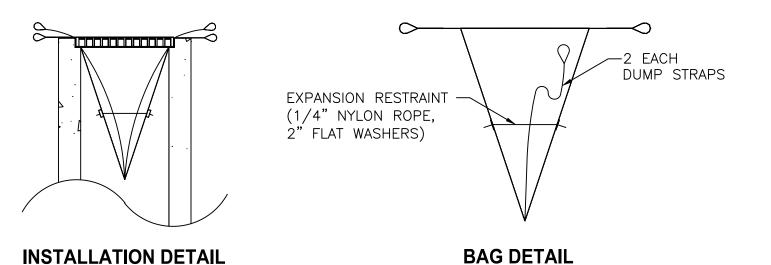


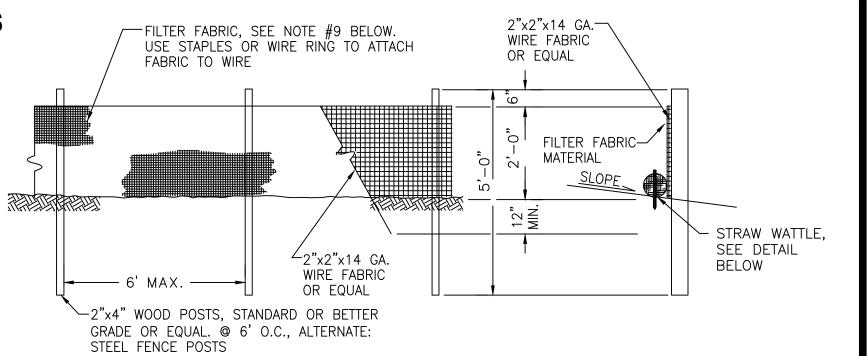

NOTES

- 1. THE FILTER FABRIC SHALL BE PURCHASED IN A CONTINUOUS ROLL CUT TO THE LENGTH OF THE BARRIER TO AVOID USE OF JOINTS. WHEN JOINTS ARE NECESSARY, FILTER CLOTH SHALL BE SPLICED TOGETHER ONLY AT A SUPPORT POST, WITH A MINIMUM 6—INCH OVERLAP AND BOTH ENDS SECURELY FASTENED TO THE POST.
- 2. THE FILTER FABRIC FENCE SHALL BE INSTALLED TO FOLLOW THE CONTOURS (WHERE FEASIBLE). THE FENCE POSTS SHALL BE SPACED A MAXIMUM OF 6 FEET APART AND DRIVEN SECURELY INTO THE GROUND (MINIMUM OF 30 INCHES).
- 3. WHEN STANDARD STRENGTH FILTER FABRIC IS USED, A WIRE MESH SUPPORT FENCE SHALL BE FASTENED SECURELY TO THE UPSLOPE SIDE OF THE POSTS USING HEAVY—DUTY WIRE STAPLES AT LEAST 1 INCH LONG. TIE WIRE OR HOG RINGS.
- 4. THE STANDARD STRENGTH FILTER FABRIC SHALL BE STAPLED OR WIRED TO THE FENCE, AND 20 INCHES OF THE FABRIC SHALL BE EXTENDED ACROSS THE GROUND, UPSLOPE AND ADJACENT TO THE WOOD POST. THE FABRIC SHALL NOT EXTEND MORE THAN 30 INCHES ABOVE THE ORIGINAL GROUND SURFACE. FILTER FABRIC SHALL NOT BE STAPLED TO EXISTING TREES.
- 5. WHEN EXTRA FILTER FABRIC AND CLOSER POST SPACING ARE USED, THE WIRE MESH SUPPORT FENCE MAY BE ELIMINATED. IN SUCH A CASE, THE FILTER FABRIC IS STAPLED OR WIRED DIRECTLY TO THE POSTS WITH ALL OTHER PROVISIONS OF STANDARD NOTE 3 APPLYING.
- 6. FABRIC SHALL BE SECURED AT THE BASE BY PEA-ROCK FILLED SANDBAGS OR STRAW WATTLES PLACED END TO END.
- 7. FILTER FABRIC FENCES SHALL BE REMOVED WHEN THEY HAVE SERVED THEIR USEFUL PURPOSE, BUT NOT BEFORE THE UPSLOPE AREA HAS BEEN PERMANENTLY STABILIZED.
- 8. FILTER FABRIC FENCES SHALL BE INSPECTED IMMEDIATELY AFTER EACH RAINFALL AND AT LEAST DAILY DURING PROLONGED RAINFALL. ANY REQUIRED REPAIRS SHALL BE MADE IMMEDIATELY.
- 9. FILTER FABRIC SHALL BE PER CURRENT GEOTEXTILE FABRIC STANDARDS FOR SILT FENCE IN THE DEPARTMENT OF ECOLOGY STORMWATER MANAGEMENT MANUAL FOR WESTERN WASHINGTON.

HIGH VISIBILITY FILTER FABRIC FENCE

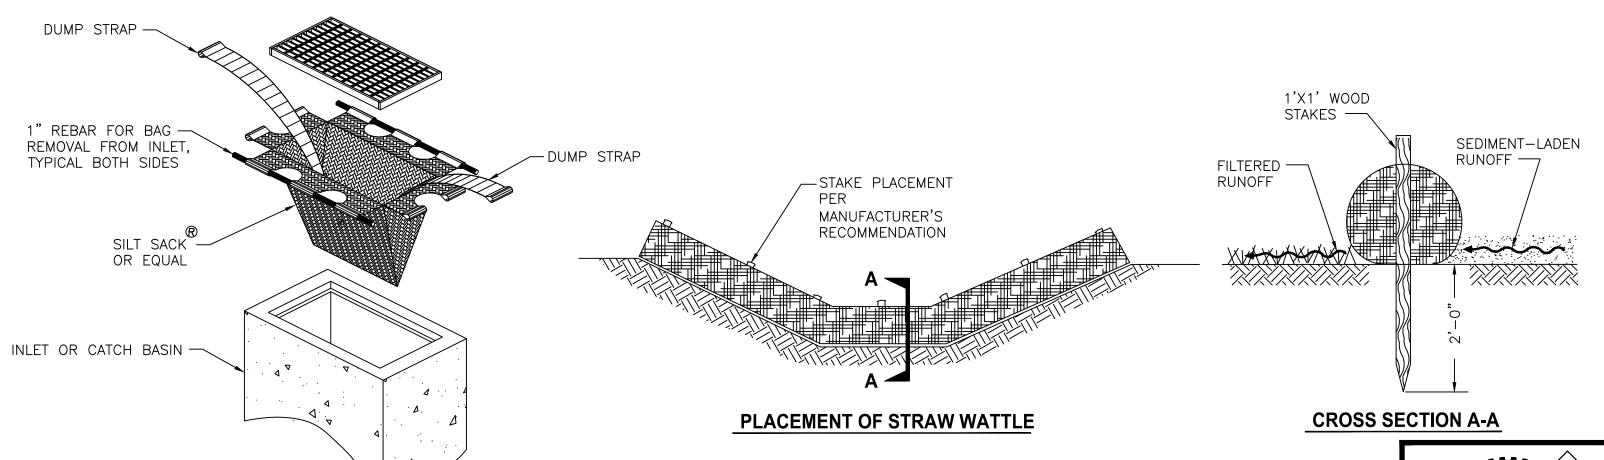

STORM DRAIN INLET PROTECTION

STRAW WATTLE DAM

NOT TO SCALE

NO	ВҮ	APPD	REVISION	DATE	И
					0

BID SET DRAWING - NOT FOR CONSTRUCTION

IF THIS BAR DOES
NOT MEASURE 1"
THEN DRAWING
IS NOT TO SCALE

 DESIGNED MB

DRAWN AMJ

CHECKED HPP

APPROVAL HPP

DATE MAR 2023



NORTHSHORE UTILITY DISTRICT

6830 NE 185th St. P.O. Box 82489 Kenmore, WA 98028-2684 Kenmore, WA 98028-2684

Ph: (425) 398-4400 | **Fax:** (425) 398-4430 | **www.nud.net**

CONTRACT 2023-02
WOODLAND COVE WATER SERVICE REPLACEMENT

GENERAL NOTES

BASE MAP L7 C1817

SHEET

2 of 24

MA YNARD PHASE 1 10945 LUDICK ty Co PHASE 2 O_{FLID}O Physics (Physics) HNTERMEDIARY WATER VALVE **OVERALL SITE PLAN** SCALE: 1"=40'

WOODLAND COVE PHASING

- 1. THE WOODLAND COVE PROJECT SHALL BE DIVIDED INTO TWO PHASES. A NORTHERN AND SOUTHERN PHASE.
- 2. PHASE 1 INCLUDES ALL WATER SERVICES BETWEEN THE NORTHEAST WATER VALVE IN JUANITA BLVD AND THE INTERMEDIARY GATE VALVE NEAR THE SOUTHWEST CORNER OF NE WOODLAND COVE DRIVE. SERVICES TO BE REPLACED INCLUDE 8422, 8437, 8442, 8443, 8449, 8455, 8461, 8473, 8486, 8493, 8479, 8483, AND 8487 NE WOODLAND COVE DRIVE.
- 3. PHASE 2 INCLUDES ALL WATER SERVICES BETWEEN THE SOUTHWEST WATER VALVE IN JUANITA BLVD AND THE INTERMEDIARY GATE VALVE NEAR THE SOUTHWEST CORNER OF NE WOODLAND COVE DRIVE. SERVICES TO BE REPLACED INCLUDE 10946, 10945, 10939, 10938, AND 10933 84TH PLACE NE AND 8496, 8407, 8413, 8419, 8425 AND 8431 NE WOODLAND COVE DRIVE.


PROPOSED CONSTRUCTION SEQUENCE

PHASE 1

- 1. CONTRACTOR SHALL REMOVE AND SAVE EXISTING PAVERS LOCATED WITHIN THE DETERMINED EXCAVATION AREA. CONTRACTOR SHALL THEN EXCAVATE AT THE EXISTING WATER MAIN TO EXPOSE THE NEW CORP WET TAP LOCATIONS AND EXISTING SADDLES. IF THE CONTRACTOR PREFERS TO OPEN TRENCH THE NEW WATER SERVICE, AMEND THIS STEP TO ALSO INCLUDE THE LIMITS OF THE NEW WATER SERVICE TRENCH.
- . AFTER THE EXISTING WATER MAIN IS EXPOSED, CONTRACTOR SHALL COVER EXCAVATION WITH STEEL SHEETS AND PROTECT WITH TRAFFIC CONES. STEEL SHEET PINS ARE NOT ALLOWED FOR SHEET ANCHORING, THEREFORE, TRAFFIC SHALL NOT BE ALLOWED ON STEEL SHEETS. ENSURE EMERGENCY VEHICLE ACCESS IS MAINTAINED THROUGHOUT CONSTRUCTION.
- 3. CONTRACTOR SHALL COORDINATE WITH INSPECTOR TO ENSURE EXCAVATION AND SHORING ARE IN PLACE FOR NUD OPS TO INSTALL THE 1" WATER SERVICE WET TAPS, INCLUDING NEW CORP. EXISTING WATER VALVES SHALL ONLY BE OPERATED BY NUD OPS. CONTRACTOR IS PROHIBITED FROM OPERATING EXISTING VALVES.
- 4. CONTRACTOR SHALL INSTALL NEW WATER SERVICE LINES, SETTERS, METER BOXES, AND APPURTENANCES. EXISTING METERS SHALL BE REUSED. SERVICE TRENCHES SHALL BE BACKFILLED FULL DEPTH WITH CRUSHED ROCK AND COMPACTED PER THE SPECIFICATIONS. EXCAVATIONS AT THE EXISTING WATER MAIN, INCLUDING NEW TAP AND EXISTING SADDLE, SHALL REMAIN UNBACKFILLED, COVERED WITH STEEL SHEETS, AND PROTECTED WITH TRAFFIC CONES.
- 5. CONTRACTOR TO POTHOLE PRIVATE SIDE WATER SERVICES IN ORDER TO DETERMINE PARTS AND FITTINGS REQUIRED FOR SERVICE TRANSFERS. CONTRACTOR SHALL COORDINATE WITH INDIVIDUAL PROPERTY OWNERS FOR SERVICE DISRUPTION IN ORDER TO INSTALL THE BACKSIDE SERVICE TRANSFERS TO THE NEW SETTERS. DISRUPTION OF SERVICE SHALL BE LIMITED AS MUCH AS POSSIBLE.
- 6. CONTRACTOR SHALL CONTACT NUD INSPECTOR AT LEAST 72 HOURS AHEAD OF ANTICIPATED WATER MAIN SHUTDOWN. ALL WATER SERVICES WITHIN PHASE 1 SHALL BE FULLY TRANSFERRED PRIOR TO WATER MAIN SHUTDOWN. CUSTOMERS WILL BE NOTIFIED BY NUD OF ANTICIPATED SHUTDOWN AT LEAST 24 HOURS IN ADVANCE. WATER MAIN SHUTDOWN TIME SHALL BE LIMITED BETWEEN THE HOURS OF 8:00AM AND 3:30PM. DURING WATER MAIN SHUTDOWN, CONTRACTOR SHALL REMOVE ALL EXISTING PHASE 1 SADDLES AT THE WATER MAIN AND INSTALL ROMAC SS1, 6" LONG REPAIR BANDS.
- 7. REMOVE SHEETS AND BACKFILL FULL DEPTH CRUSHED ROCK AT EACH SADDLE LOCATION.

PHASE 2

- 8. REPEAT STEPS ABOVE FOR PHASE 2.
- 9. ONCE BOTH WATER PHASES ARE COMPLETE, SCHEDULE BRICK PAVER ROADWAY RESTORATION FOR BOTH PHASES. SEE SPECIFICATIONS AND DETAIL ON SHEET 24 FOR MORE INFORMATION.

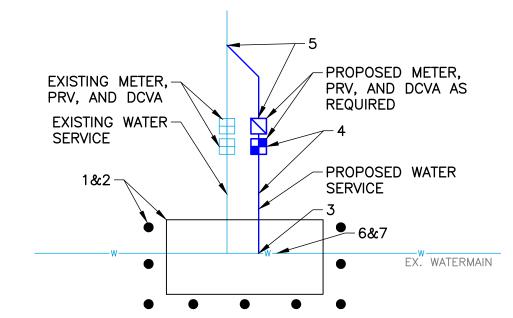

PROPOSED CONSTRUCTION SEQUENCE FIGURE

SCALE: NTS

CHESTONAL ENGINEE

NO	BY	APPD	REVISION	DATE	W/	
					0	
					IF TH	
					NOT THE	
	BID SET DRAWING - NOT FOR CONSTRUCTION					

WARNING

0 1/2 1

IF THIS BAR DOES
NOT MEASURE 1"
THEN DRAWING
IS NOT TO SCALE

An Engineering Services Company

11255 Kirkland Way, Suite 300
Kirkland, WA 98033
p. 425.827.2014 | f. 425.827.5043

Civil | Structural | Planning | Survey paceengrs.com

PACE JOB # 21061.00

DESIGNED MB

DRAWN AMJ

CHECKED HPP

APPROVAL HPP

DATE MAR 2023



NORTHSHORE UTILITY DISTRICT

6830 NE 185th St. Kenmore, WA 98028-2684 P.O. Box 82489 Kenmore, WA 98028-2684

Ph: (425) 398-4400 | **Fax:** (425) 398-4430 | **www.nud.net**

CONTRACT 2023-02
WOODLAND COVE WATER SERVICE REPLACEMENT


SCHEDULE A PHASING PLAN

BASE MAP L7 C1817


SHEET

3 OF 24


GENERAL NOTES NW 1/4, SEC 31, T26N, R5E 1. SEE SHEET 2 FOR GENERAL NOTES, LEGEND, AND SURVEY CONTROL INFORMATION. 2. PRIOR TO EXCAVATION, INSTALL TESC FACILITIES PER SHEET 2. 3. COORDINATE AND CONFIRM FITTING REQUIREMENTS IN THE FIELD WITH THE DISTRICT PRIOR TO CONSTRUCTION. 4. ALL BURIED WATER MAIN SHALL BE RESTRAINED JOINT (R.J.) PIPE WITH FIELD 2369 LOK GASKETS (OR APPROVED EQUAL) AND POLYETHYLENE ENCASEMENT PER NUD STANDARD SPECIFICATIONS. (8473) RIM 35.89 5. LOCATION AND DEPTH OF EXISTING 8" DUCTILE IRON WATER MAINS SHALL BE IE SE 33.49 2369 VERIFIED PRIOR TO WET-TAPPING (TYP.). IE SW 33.54 TARAGHI BOT 33.14 6. CONTRACTOR SHALL USE APPROPRIATE EQUIPMENT TO MINIMIZE DAMAGE TO DHA 2862—315 MAG NAIL N 258587.632' PAVERS IN THE ROADWAY, SUCH AS RUBBER TIRES AND TREADS. PAVERS E 1296985.399' RIM 39.37 - DCVA & SHUTOFF DAMAGED DURING CONSTRUCTION WILL BE REPLACED BY THE CONTRACTOR AT N 258540.691' IE SW 30.57 IE SE 30.47 CHANNELED BOTTOM EL 83.71° VALVE 2369 E 1297070.909' NO ADDITIONAL COST TO THE DISTRICT. __ WM EL 65.35' 7. ALL SERVICE CONNECTIONS ARE ASSUMED TO HAVE A PRIVATE PRV DEVICE ON THE BACKSIDE OF THE METER. UNLESS OTHERWISE NOTED, A REPLACEMENT PRV DEVICE SHALL BE INSTALLED AT THE TIME OF RECONNECTION. SEE DHA 2862—314 MAG NAIL IE 89.27 — SPECIFICATIONS FOR PRESSURE TESTING REQUIREMENTS. SEE SHEET 20 FOR STANDARD DETAIL. N 258476.462' E 1297194.113' EL 46.16' 8. WATER SERVICE INSTALLATION MAY BE COMPLETED BY EITHER OPEN TRENCH OR TRENCHLESS CONSTRUCTION. MEANS AND METHODS FOR WATER SERVICE INSTALLATION SHALL BE DETERMINED BY THE CONTRACTOR. 2369 OP CASE 91.68 TOP NUT 90.12 9. FINAL METER BOX LOCATION SHALL BE COORDINATED WITH AND APPROVED BY **EXISTING PAVERS-**THE NUD INSPECTOR. TO BE RESTORED TRENCH -NO WATER PAINT-OUT IN KIND. COORDINATE VALVE -10. REFER TO SHEET 3 FOR CONSTRUCTION SEQUENCING (PER RECORD) OPENING AND CLOSING 2369 WESTERLY END OF RIM 43.59 WITH NUD OPS. VALVE WATER PAINT-OUT TOP CASE 49.65 5 IE N 34.39 **CONSTRUCTION NOTES** OPERATION BY NUD IE NW 34.39 SECORD - DCVA & SHUTOFF IE W 34.49 IE E 34.29 (1) CATCH BASIN AND INLET SEDIMENTATION PROTECTION REQUIRED, SEE SHEET 2 8486 CHANNELED BOTTOM FOR ADDITIONAL INFORMATION. (2) INSTALL NEW 1" WATER SERVICE PER THE STANDARD DETAIL, SEE SHEET 20. 1 RIM 44.34 IE W 40.49 IE W 40.49 (3) EXISTING WATER SERVICE SADDLE, METER BOX, AND SETTER TO BE REMOVED IE SW 40.49 RIM 45.63 IE NE 40.49 AND DISPOSED. EXISTING METER TO BE REUSED AND TRANSFERRED TO THE IE NW 43.83 BOT 40.19 NEW SETTER BY THE CONTRACTOR UNDER DISTRICT INSPECTION. ABANDON IE W 41.33 BOT 40.98 EXISTING WATER SERVICE PIPE IN PLACE. WATER MAIN SHALL BE REPAIRED WITH ROMAC SS1, 6" LONG REPAIR BANDS. (8493) (4) EXISTING WATER SERVICE SADDLE, METER BOX, AND SETTER TO BE REMOVED MAYNARD AND DISPOSED. ABANDON EXISTING WATER SERVICE PIPE IN PLACE. WATER MAIN SHALL BE REPAIRED WITH ROMAC SS1, 6" LONG REPAIR BANDS. **CONTINUATION LINE SEE SHEET 8** (5) REMOVE AND SAVE EXISTING ROADWAY AND DRIVEWAY BRICK PAVERS. REPLACE ONCE BACKFILL IS COMPLETE. SEE SPECIFICATIONS AND DETAIL ON SHEET 24 FOR MORE INFORMATION. (6) REMOVE AND REPLACE EXISTING PRV, IF PRESENT. (7) REMOVE, DISPOSE AND REPLACE EX. SIDEWALK TO NEAREST EXPANSION JOINT. (8) REMOVE, DISPOSE AND REPLACE EX. ROLLED CURB TO NEAREST EXPANSION JOINT. 9 LANDSCAPE RESTORATION. DESIGNED BY NO BY APPD **REVISION** DATE BASE MAP L7 **CONTRACT 2023-02 NORTHSHORE UTILITY DISTRICT** PACE WOODLAND COVE WATER SERVICE REPLACEMENT **DRAWN** C1817 6830 NE 185th St. P.O. Box 82489 **CHECKED** SHEET Kenmore, WA 98028-2684 Kenmore, WA 98028-2684 p. 425.827.2014 | f. 425.827.5043 **SCHEDULE A PHASE 1** NOT MEASURE Civil | Structural | Planning | Survey THEN DRAWING **Ph:** (425) 398-4400 | **Fax:** (425) 398-4430 | **www.nud.net** <u>4</u> of <u>24</u> S NOT TO SCALE DATE MAR 2023 **BID SET DRAWING - NOT FOR CONSTRUCTION**

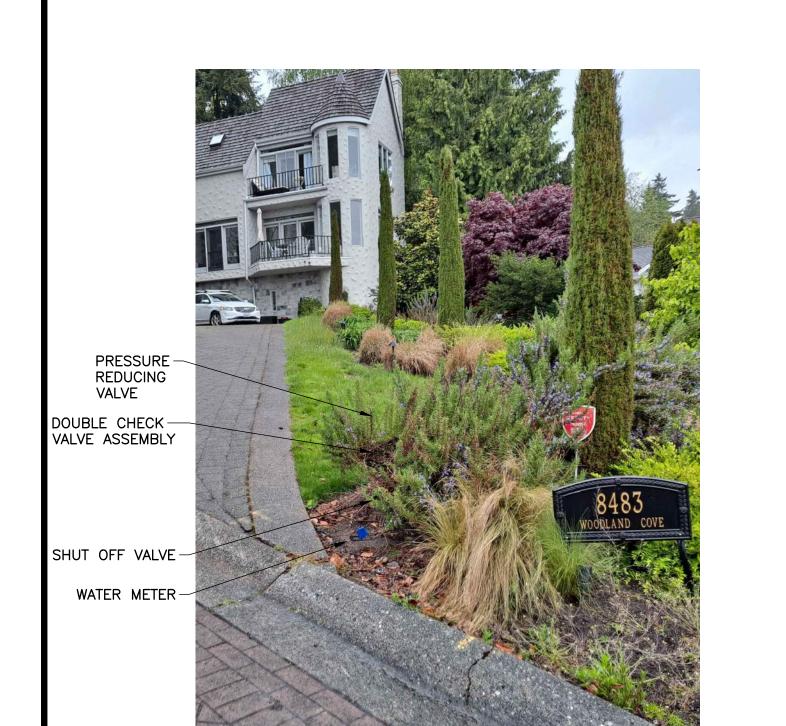




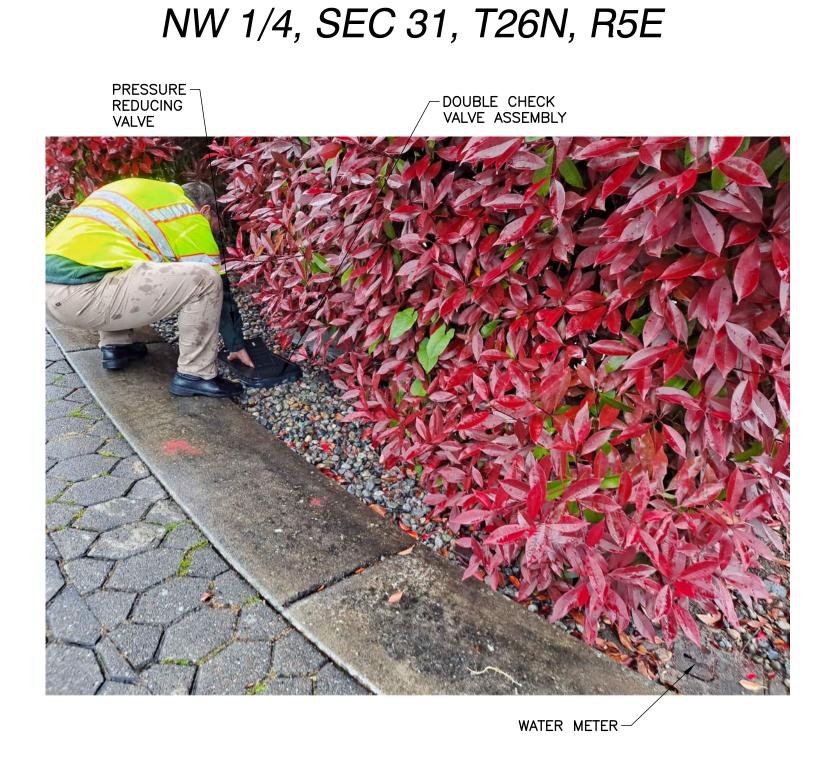

8479 WATER SERVICE

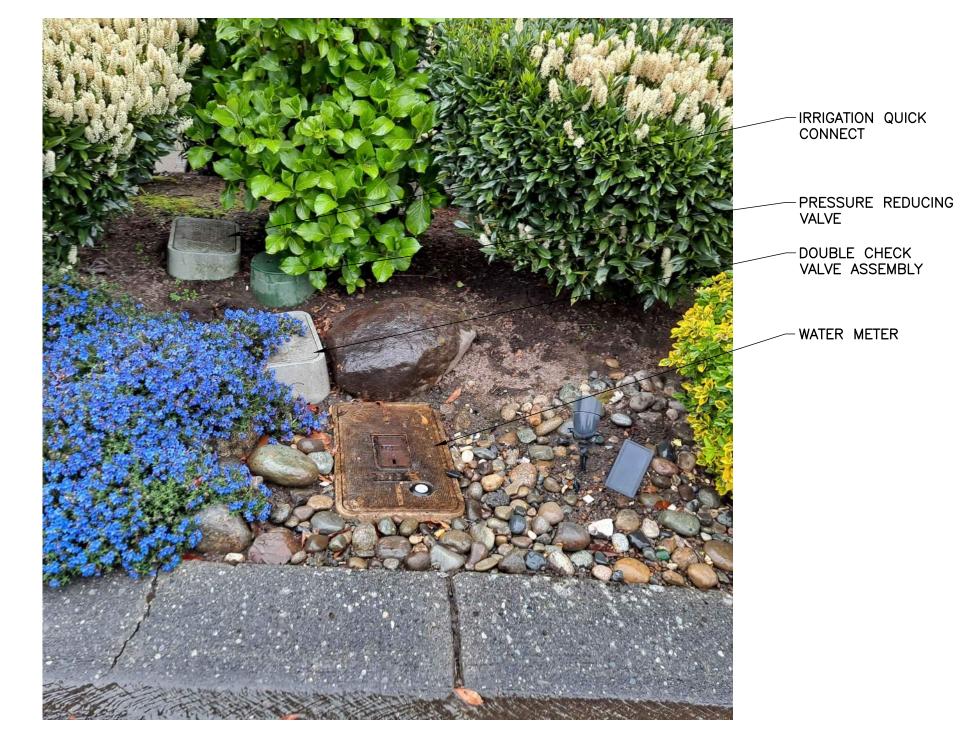

8473 WATER SERVICE

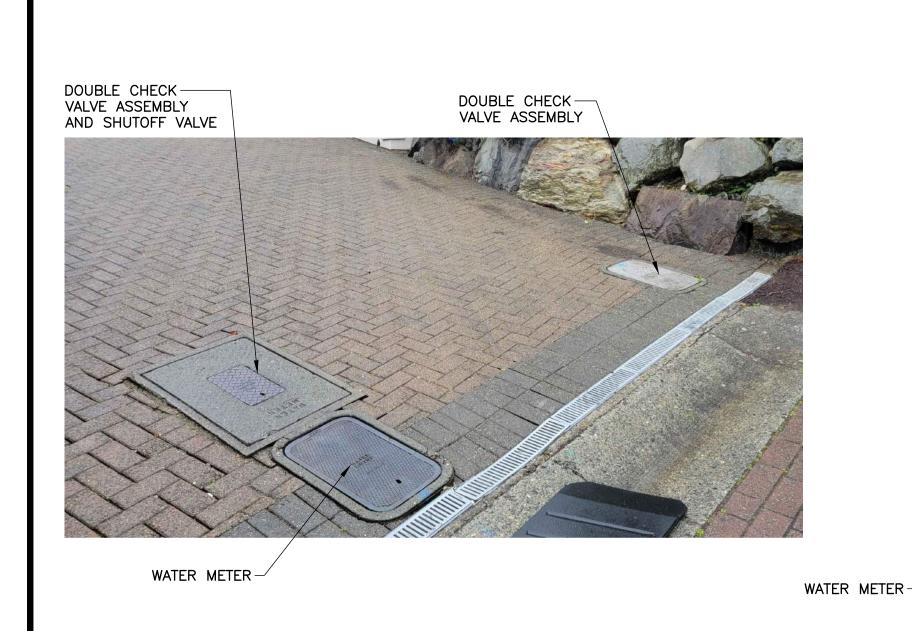





8486 WATER SERVICE

8487 WATER SERVICE

NO	BY	APPD	REVISION	DATE	W.
					0
					IF TH
					NOT THEI IS NO
	BID SET DRAWING - NOT FOR CONSTRUCTION				

THIS BAR DOES DT MEASURE 1" HEN DRAWING NOT TO SCALE PACE JOB # 21061.00

11255 Kirkland Way, Suite 300 Kirkland, WA 98033 p. 425.827.2014 | f. 425.827.5043 Civil | Structural | Planning | Survey paceengrs.com

DESIGNED BY **DRAWN** CHECKED MAR 2023 DATE

NORTHSHORE UTILITY DISTRICT


6830 NE 185th St. P.O. Box 82489 Kenmore, WA 98028-2684

Kenmore, WA 98028-2684 **Ph:** (425) 398-4400 | **Fax:** (425) 398-4430 | **www.nud.net**

SCHEDULE A PHASE 1

CONTRACT 2023-02 WOODLAND COVE WATER SERVICE REPLACEMENT

BASE MAP L7 C1817 SHEET 5 OF 24

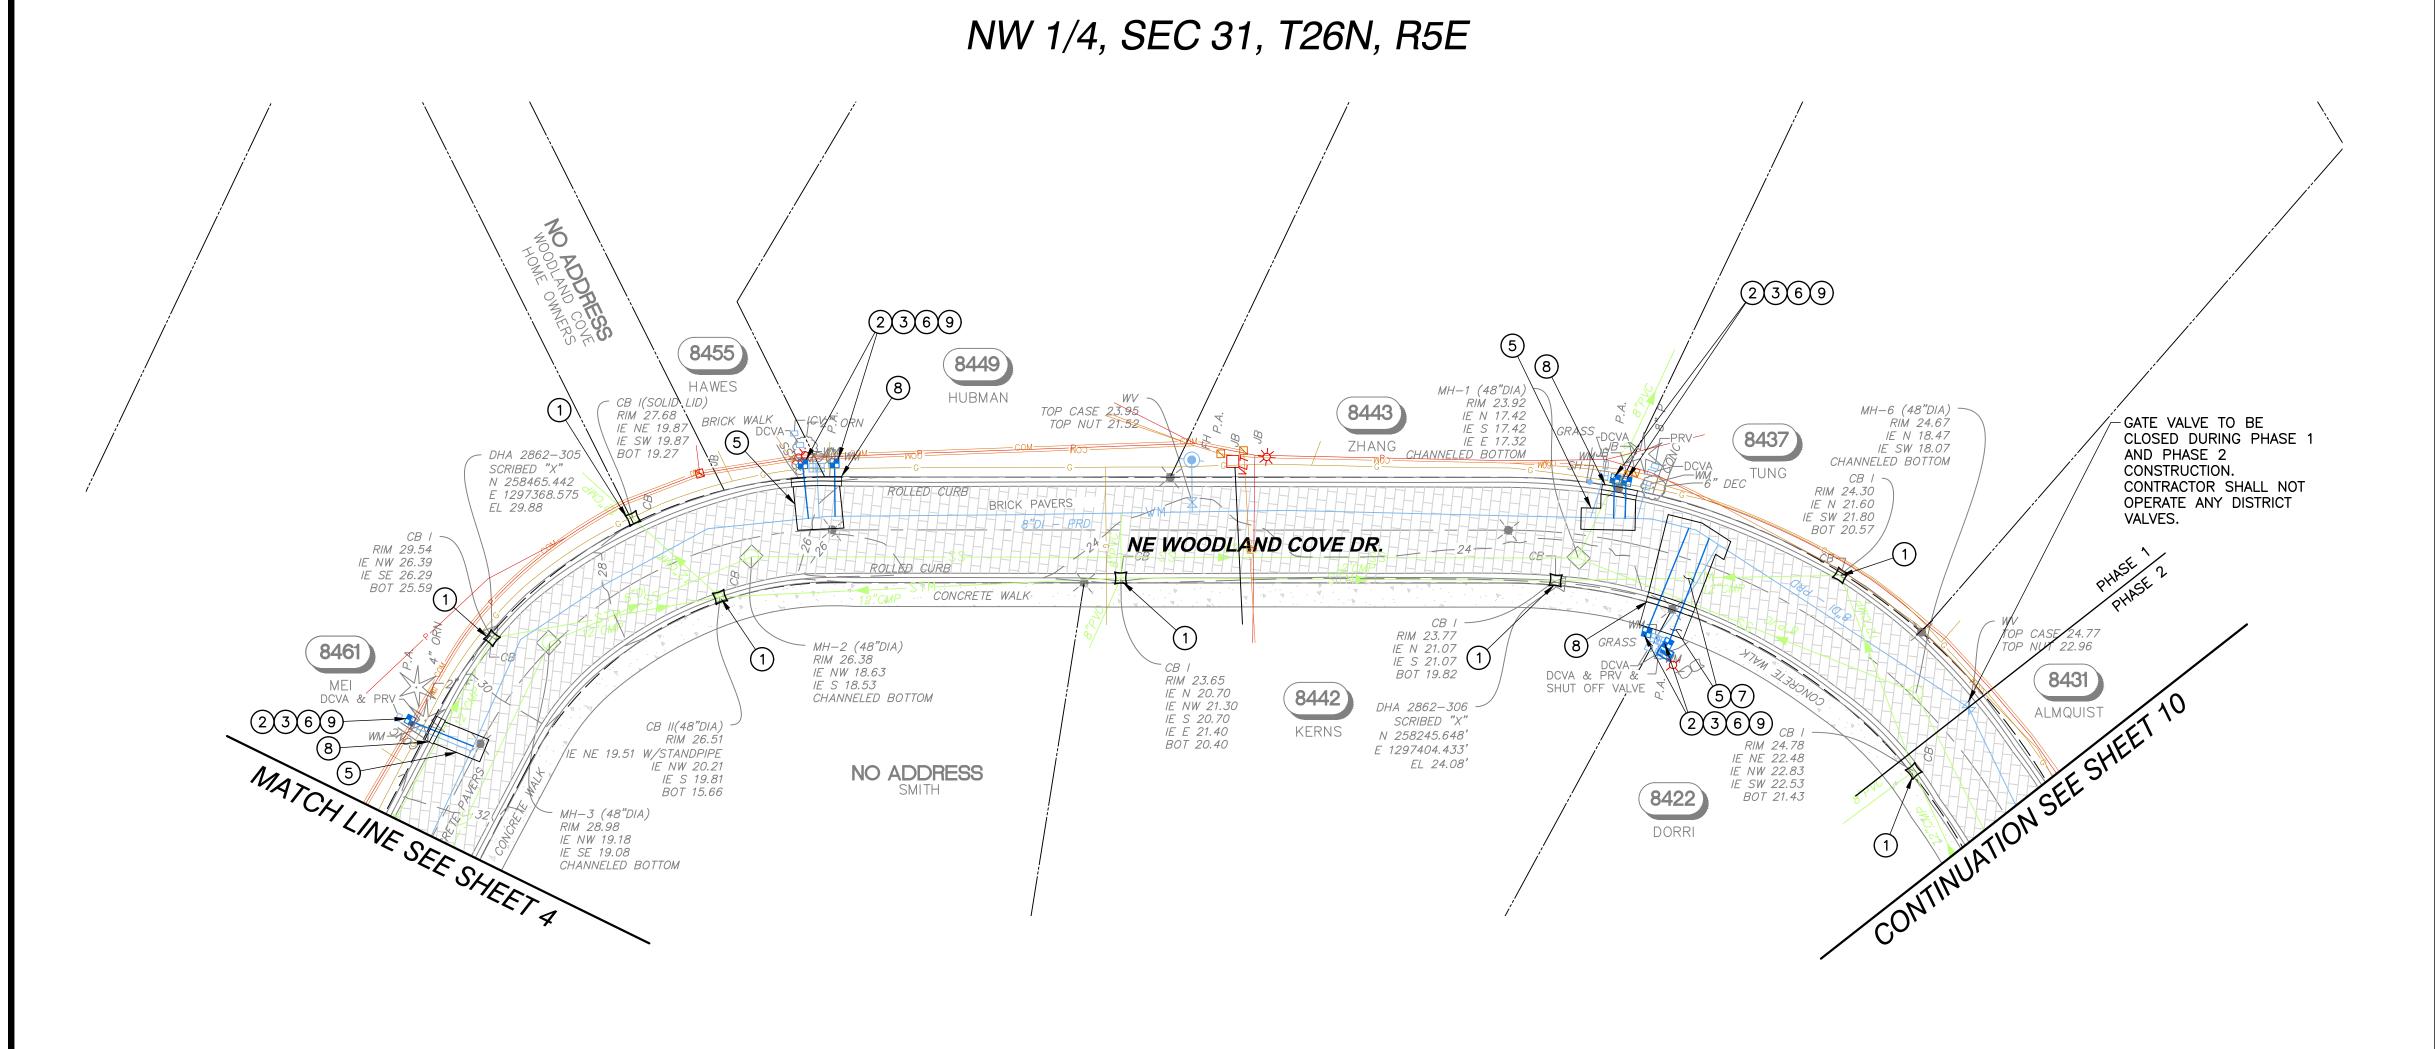


GENERAL NOTES

- 1. SEE SHEET 2 FOR GENERAL NOTES, LEGEND, AND SURVEY CONTROL INFORMATION.
- 2. PRIOR TO EXCAVATION, INSTALL TESC FACILITIES PER SHEET 2.
- 3. COORDINATE AND CONFIRM FITTING REQUIREMENTS IN THE FIELD WITH THE DISTRICT PRIOR TO CONSTRUCTION.
- 4. ALL BURIED WATER MAIN SHALL BE RESTRAINED JOINT (R.J.) PIPE WITH FIELD LOK GASKETS (OR APPROVED EQUAL) AND POLYETHYLENE ENCASEMENT PER NUD STANDARD SPECIFICATIONS.
- 5. LOCATION AND DEPTH OF EXISTING 8" DUCTILE IRON WATER MAINS SHALL BE VERIFIED PRIOR TO WET-TAPPING (TYP.).
- 6. CONTRACTOR SHALL USE APPROPRIATE EQUIPMENT TO MINIMIZE DAMAGE TO PAVERS IN THE ROADWAY, SUCH AS RUBBER TIRES AND TREADS. PAVERS DAMAGED DURING CONSTRUCTION WILL BE REPLACED BY THE CONTRACTOR AT NO ADDITIONAL COST TO THE DISTRICT.
- 7. ALL SERVICE CONNECTIONS ARE ASSUMED TO HAVE A PRIVATE PRV DEVICE ON THE BACKSIDE OF THE METER. UNLESS OTHERWISE NOTED, A REPLACEMENT PRV DEVICE SHALL BE INSTALLED AT THE TIME OF RECONNECTION. SEE SPECIFICATIONS FOR PRESSURE TESTING REQUIREMENTS. SEE SHEET 20 FOR STANDARD DETAIL.
- 8. WATER SERVICE INSTALLATION MAY BE COMPLETED BY EITHER OPEN TRENCH OR TRENCHLESS CONSTRUCTION. MEANS AND METHODS FOR WATER SERVICE INSTALLATION SHALL BE DETERMINED BY THE CONTRACTOR.
- 9. FINAL METER BOX LOCATION SHALL BE COORDINATED WITH AND APPROVED BY THE NUD INSPECTOR.

10. REFER TO SHEET 3 FOR CONSTRUCTION SEQUENCING

CONSTRUCTION NOTES

- (1) CATCH BASIN AND INLET SEDIMENTATION PROTECTION REQUIRED, SEE SHEET 2 FOR ADDITIONAL INFORMATION.
- (2) INSTALL NEW 1" WATER SERVICE PER THE STANDARD DETAIL, SEE SHEET 20.
- 3 EXISTING WATER SERVICE SADDLE, METER BOX, AND SETTER TO BE REMOVED AND DISPOSED. EXISTING METER TO BE REUSED AND TRANSFERRED TO THE NEW SETTER BY THE CONTRACTOR UNDER DISTRICT INSPECTION. ABANDON EXISTING WATER SERVICE PIPE IN PLACE. WATER MAIN SHALL BE REPAIRED WITH ROMAC SS1, 6" LONG REPAIR BANDS.
- FEMOVE AND SAVE EXISTING ROADWAY AND DRIVEWAY BRICK PAVERS. REPLACE ONCE BACKFILL IS COMPLETE. SEE SPECIFICATIONS AND DETAIL ON SHEET 24 FOR MORE INFORMATION.
- 6 REMOVE AND REPLACE OR INSTALL NEW PRV BEHIND METER.
- (7) REMOVE, DISPOSE AND REPLACE EX. SIDEWALK TO NEAREST EXPANSION JOINT.
- (8) REMOVE, DISPOSE AND REPLACE EX. ROLLED CURB TO NEAREST EXPANSION JOINT.
- (9) LANDSCAPE RESTORATION.

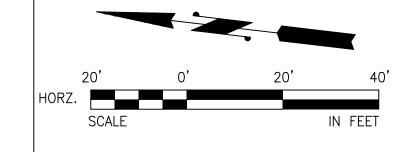



NO	BY	APPD	REVISION	DATE	
					0
					· IF
		E	BID SET DRAWING - NOT FOR CONSTRUCTION	<u>. I</u>	15



	DESIGNED BY	ME
Ingineering Services Company	DRAWN BY	AM
rkland Way, Suite 300 WA 98033	CHECKED BY	HP
27.2014 f. 425.827.5043 ructural Planning Survey	APPROVAL	HP
rs.com E JOB # 21061.00	DATE	MAR 2



NORTHSHORE UTILITY DISTRICT

6830 NE 185th St. Kenmore, WA 98028-2684

P.O. Box 82489 Kenmore, WA 98028-2684

Ph: (425) 398-4400 | **Fax:** (425) 398-4430 | **www.nud.net**

CONTRACT 2023-02
WOODLAND COVE WATER SERVICE REPLACEMENT


SCHEDULE A PHASE 1


BASE MAP L7 C1817

SHEET

6 OF 24

NW 1/4, SEC 31, T26N, R5E

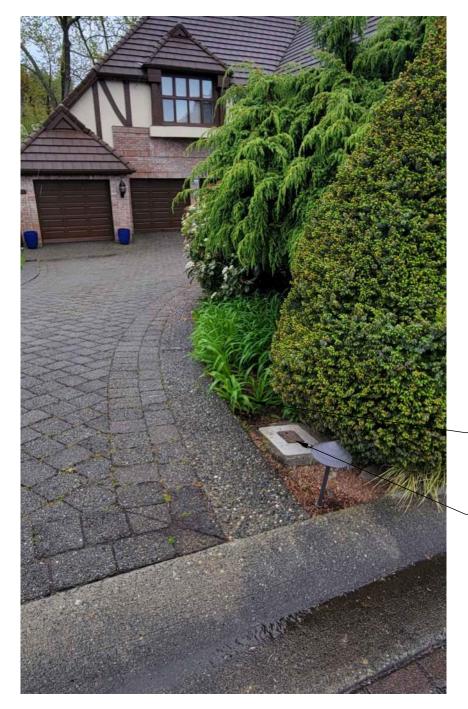

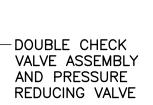

- WATER METER



UNKNOWN BOX-



DOUBLE CHECK—VALVE ASSEMBLY WATER METER -

8461 WATER SERVICE






8443 WATER SERVICE



8442 WATER SERVICE



8422 WATER SERVICE

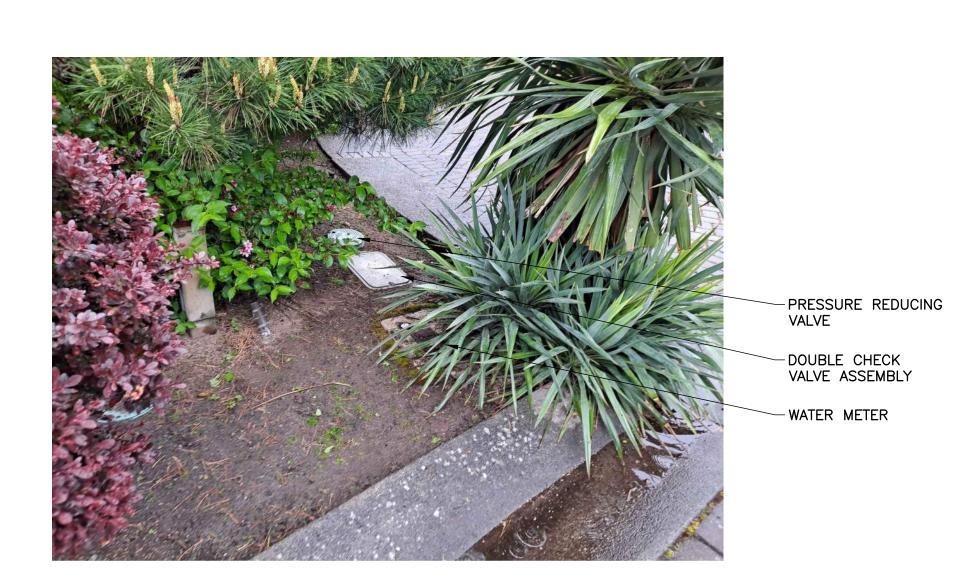

8437 WATER SERVICE

Kenmore, WA 98028-2684

P.O. Box 82489

	DESIGNED BY	МВ
An Engineering Services Company	DRAWN BY	AMJ
11255 Kirkland Way, Suite 300 Kirkland, WA 98033	CHECKED BY	НРР
p. 425.827.2014 f. 425.827.5043 Civil Structural Planning Survey	APPROVAL	НРР
paceengrs.com		


NORTHSHORE UTILITY DISTRICT

6830 NE 185th St. Kenmore, WA 98028-2684

Ph: (425) 398-4400 | **Fax:** (425) 398-4430 | **www.nud.net**

CONTRACT 2023-02 WOODLAND COVE WATER SERVICE REPLACEMENT

SCHEDULE A PHASE 1

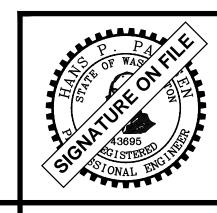


BASE MAP L7 C1817 SHEET

7 OF 24

NO	BY	APPD	REVISION	DATE	W
					$\begin{bmatrix} vv \\ 0 \end{bmatrix}$
					IF TH
					NOT THE
	BID SET DRAWING - NOT FOR CONSTRUCTION				

VARNING THIS BAR DOES IT MEASURE 1" EN DRAWING NOT TO SCALE PACE JOB # 21061.00

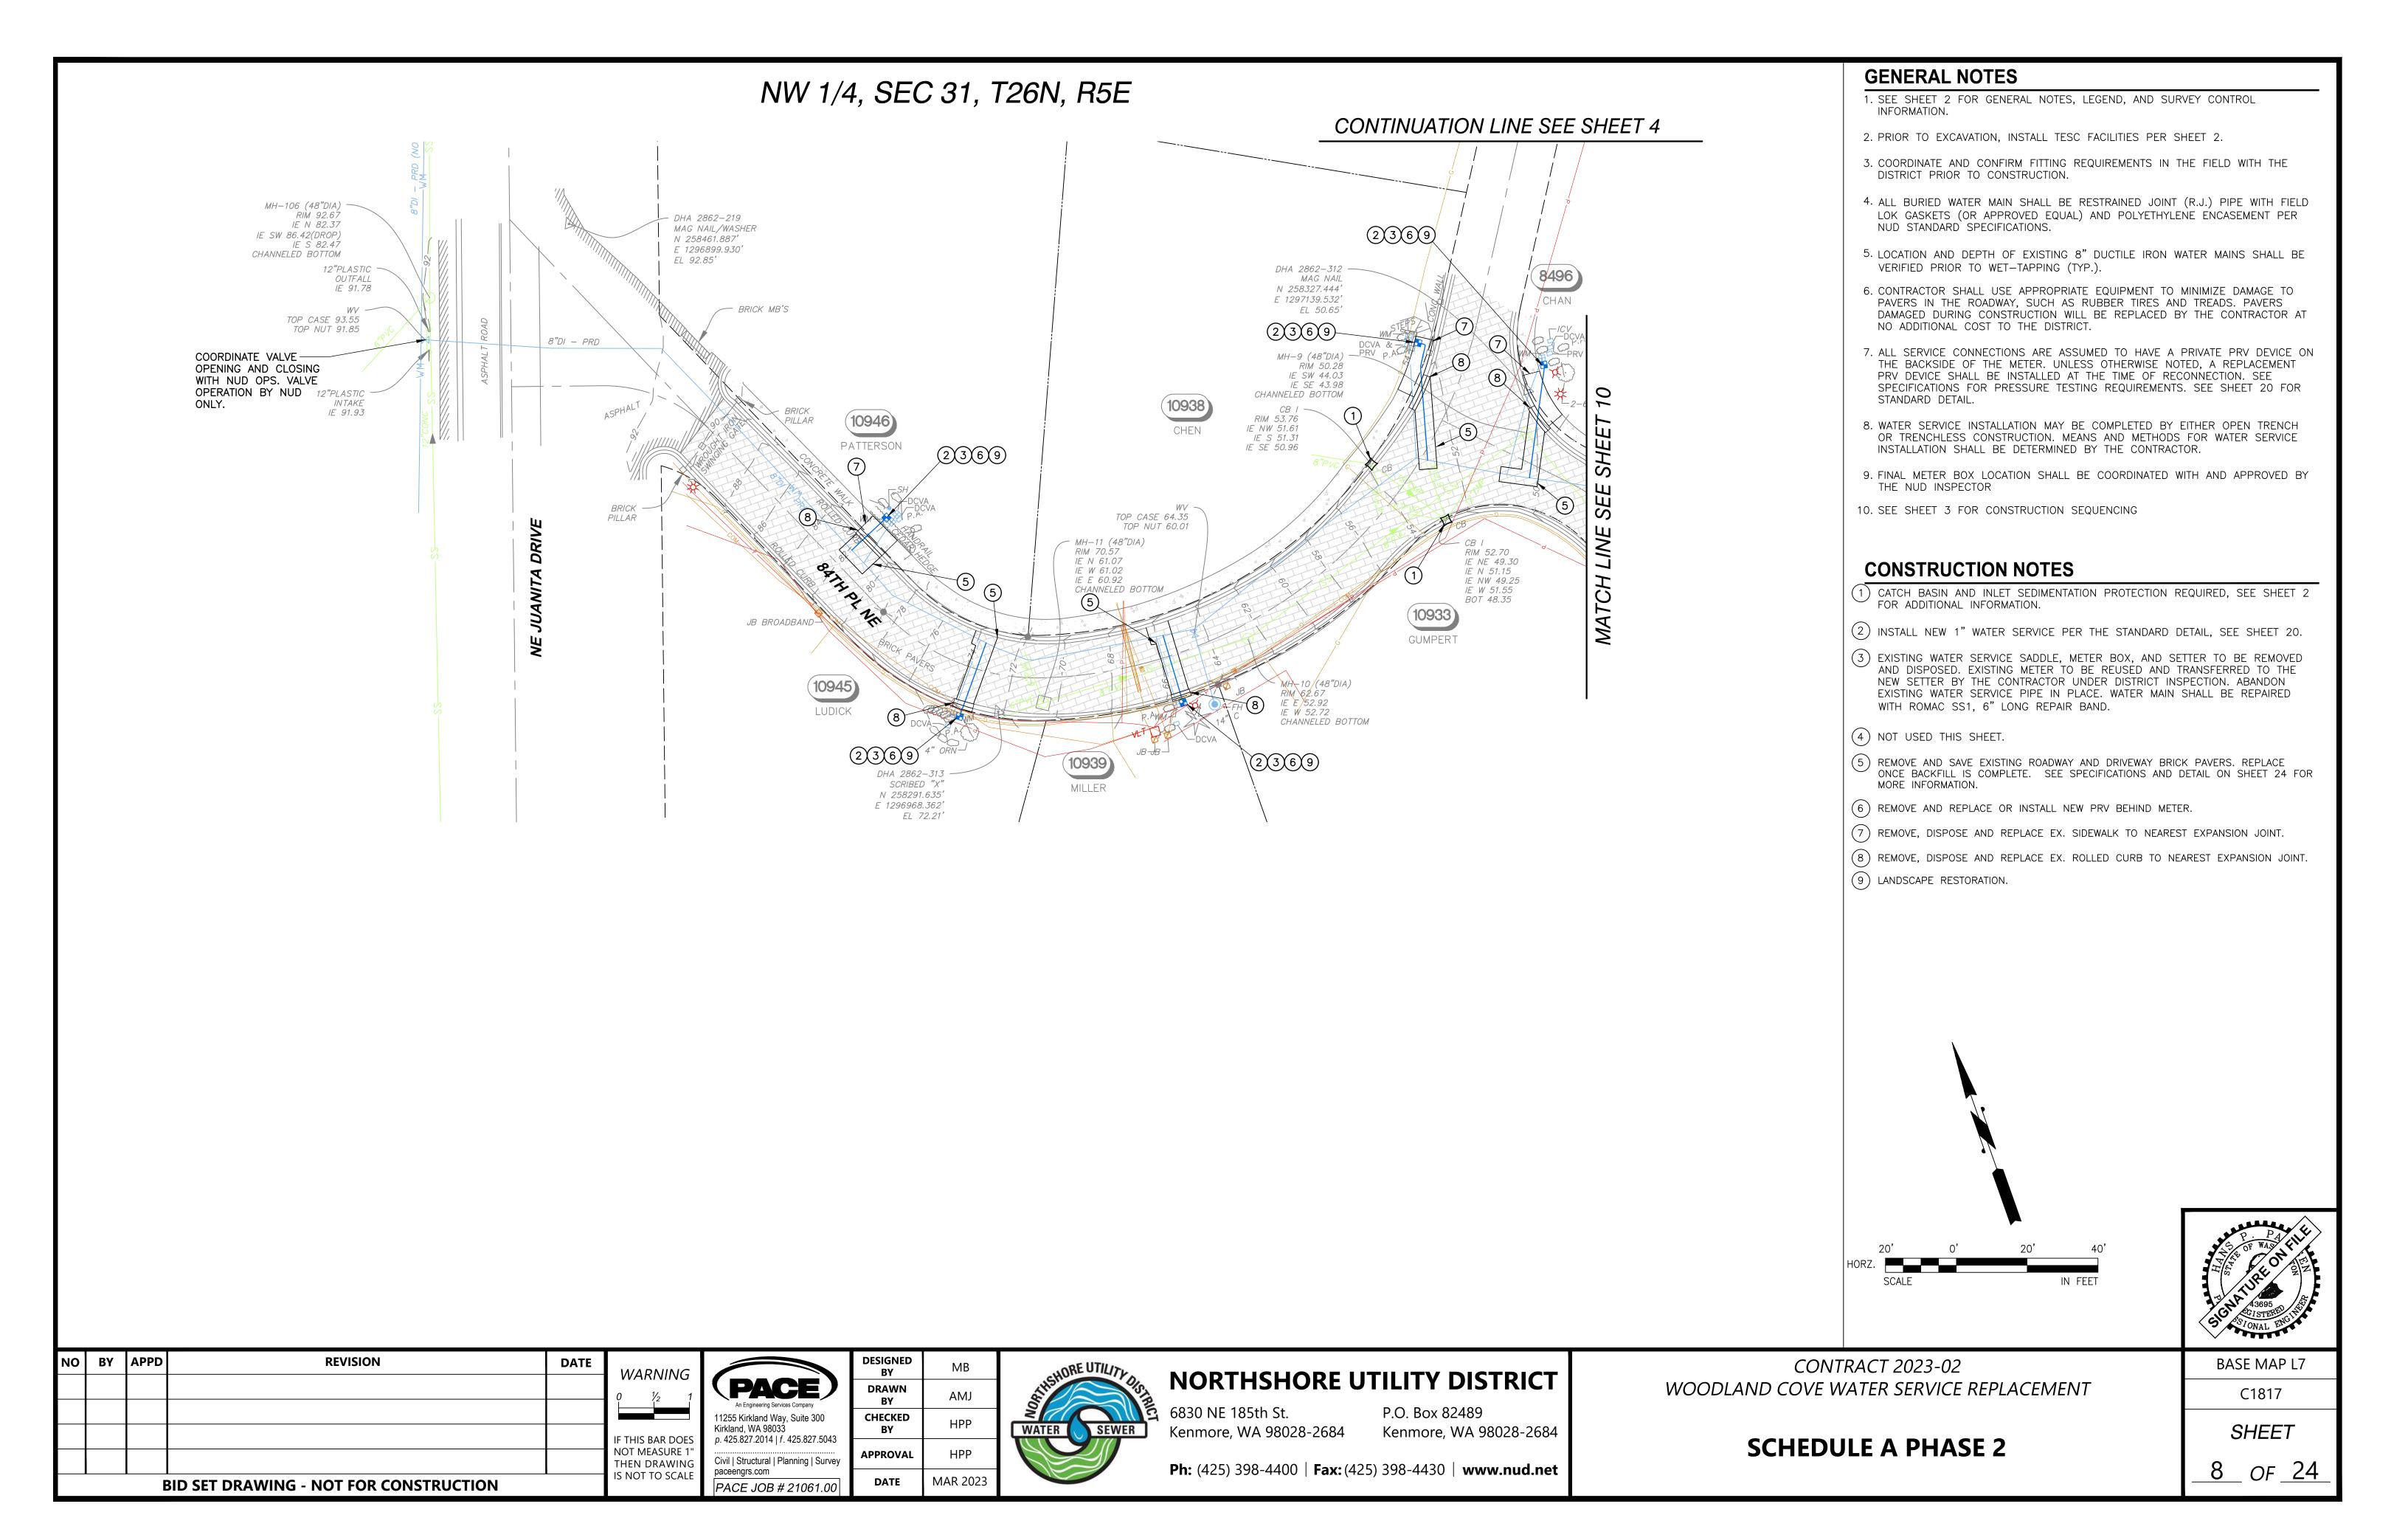

NW 1/4, SEC 31, T26N, R5E



- DOUBLE CHECK VALVE ASSEMBLY -PRESSURE REDUCING VALVE ─ WATER METER

10946 WATER SERVICE

10945 WATER SERVICE



TER	SERVICE	

MAR 2023

NO	BY	APPD	REVISION	DATE	WAF
					0
					IF THIS I
					THEN D
		E	BID SET DRAWING - NOT FOR CONSTRUCTION		IS NOT

WARNING 0 ½ 1	An Engineering Services Comp 11255 Kirkland Way, Suit
IF THIS BAR DOES	Kirkland, WA 98033 p. 425.827.2014 f. 425.8
NOT MEASURE 1" THEN DRAWING IS NOT TO SCALE	Civil Structural Plannin paceengrs.com
13 NOT TO SCALE	PACE JOB # 210

	DESIGNED BY
An Engineering Services Company	DRAWN BY
11255 Kirkland Way, Suite 300 Kirkland, WA 98033	CHECKED BY
p. 425.827.2014 f. 425.827.5043	APPROVAL
PACE JOB # 21061.00	DATE


CHO	RE UTILITY DIS
STITS	
WATER	SEWER

ON THE UTILITY DISCHARGE	NORTHSHORE U	FILITY DISTRIC
		P.O. Box 82489
VATER SEWER	Kenmore, WA 98028-2684	Kenmore, WA 98028-2

Ph: (425) 398-4400 | **Fax:** (425) 398-4430 | **www.nud.net**

CONTRACT 2023-02 WOODLAND COVE WATER SERVICE REPLACEMENT

SCHEDULE A PHASE 2

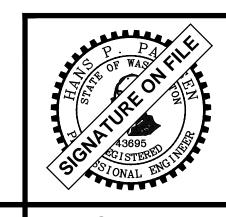

BASE MAP L7 C1817 SHEET 9 OF 24

NW 1/4, SEC 31, T26N, R5E CONTINUATION SEE SHEET 6 (8422) 2369 8431 RIM 25.71 IE NW 23.26 IE S 23.11 IE NE 23.11 BOT 22.56 DORRI MATCHLINE DHA 2862-310 -MAG NAIL N 258147.624' E 1297309.780' EL 27.88' (8425) CB | RIM 34.61 SEE SHEET GRADY DHA 2862-311 ~ MAG NAIL N 258194.087' E 1297202.994' EL 37.36' MH-7 (48"DIA) RIM 26.62 IE NW 18.87 IE NE 18.77 CHANNELED BOTTOM 2369 8419 DAVIDSON (10933) **GUMPERT** 2369 MH-8 (48"DIA) BOT 32.45 1 2369 IE NW 29.83 IE SE 29.73 CHANNELED BOTTOM (8407) XIAO 2369 KETTLEWELL


GENERAL NOTES

- 1. SEE SHEET 2 FOR GENERAL NOTES, LEGEND, AND SURVEY CONTROL INFORMATION.
- 2. PRIOR TO EXCAVATION, INSTALL TESC FACILITIES PER SHEET 2.
- 3. COORDINATE AND CONFIRM FITTING REQUIREMENTS IN THE FIELD WITH THE DISTRICT PRIOR TO CONSTRUCTION.
- 4. ALL BURIED WATER MAIN SHALL BE RESTRAINED JOINT (R.J.) PIPE WITH FIELD LOK GASKETS (OR APPROVED EQUAL) AND POLYETHYLENE ENCASEMENT PER NUD STANDARD SPECIFICATIONS.
- 5. LOCATION AND DEPTH OF EXISTING 8" DUCTILE IRON WATER MAINS SHALL BE VERIFIED PRIOR TO WET-TAPPING (TYP.).
- 6. CONTRACTOR SHALL USE APPROPRIATE EQUIPMENT TO MINIMIZE DAMAGE TO PAVERS IN THE ROADWAY, SUCH AS RUBBER TIRES AND TREADS. PAVERS DAMAGED DURING CONSTRUCTION WILL BE REPLACED BY THE CONTRACTOR AT NO ADDITIONAL COST TO THE DISTRICT.
- 7. ALL SERVICE CONNECTIONS ARE ASSUMED TO HAVE A PRIVATE PRV DEVICE ON THE BACKSIDE OF THE METER. UNLESS OTHERWISE NOTED, A REPLACEMENT PRV DEVICE SHALL BE INSTALLED AT THE TIME OF RECONNECTION. SEE SPECIFICATIONS FOR PRESSURE TESTING REQUIREMENTS. SEE SHEET 20 FOR STANDARD DETAIL.
- 8. WATER SERVICE INSTALLATION MAY BE COMPLETED BY EITHER OPEN TRENCH OR TRENCHLESS CONSTRUCTION. MEANS AND METHODS FOR WATER SERVICE INSTALLATION SHALL BE DETERMINED BY THE CONTRACTOR.
- 9. FINAL METER BOX LOCATION SHALL BE COORDINATED WITH AND APPROVED BY THE NUD INSPECTOR.

10. SEE SHEET 3 FOR CONSTRUCTION SEQUENCING

CONSTRUCTION NOTES

- (1) CATCH BASIN AND INLET SEDIMENTATION PROTECTION REQUIRED, SEE SHEET 2 FOR ADDITIONAL INFORMATION.
- (2) INSTALL NEW 1" WATER SERVICE PER THE STANDARD DETAIL, SEE SHEET 20.
- (3) EXISTING WATER SERVICE SADDLE, METER BOX, AND SETTER TO BE REMOVED AND DISPOSED. EXISTING METER TO BE REUSED AND TRANSFERRED TO THE NEW SETTER BY THE CONTRACTOR UNDER DISTRICT INSPECTION. ABANDON EXISTING WATER SERVICE PIPE IN PLACE. WATER MAIN SHALL BE REPAIRED WITH ROMAC SS1, 6" LONG REPAIR BAND.
- (4) NOT USED THIS SHEET.
- (5) REMOVE AND SAVE EXISTING ROADWAY AND DRIVEWAY BRICK PAVERS. REPLACE ONCE BACKFILL IS COMPLETE. SEE SPECIFICATIONS AND DETAIL ON SHEET 24 FOR MORE INFORMATION.
- (6) REMOVE AND REPLACE OR INSTALL NEW PRV BEHIND METER.
- (7) REMOVE, DISPOSE AND REPLACE EX. SIDEWALK TO NEAREST EXPANSION JOINT.
- (8) REMOVE, DISPOSE AND REPLACE EX. ROLLED CURB TO NEAREST EXPANSION JOINT.
- (9) LANDSCAPE RESTORATION.

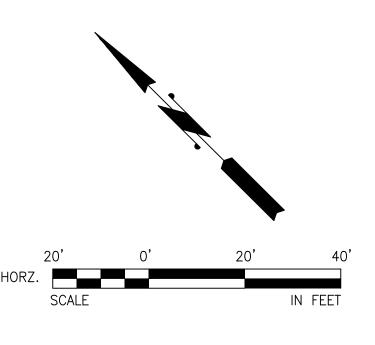



	_
D. W.	
S OF WAS	
E S S S Z	
43695 GISTERED CHE	
S ONAL ENGIN	
A	

NO	BY	APPD	REVISION	DATE	WA
					0
					IF THI
					NOT I
		E	BID SET DRAWING - NOT FOR CONSTRUCTION		IS NO



PAC An Engineering Servi	SE ces Company
11255 Kirkland Wa Kirkland, WA 98033 p. 425.827.2014 f	3
Civil Structural P paceengrs.com	lanning Survey
PACE JOB #	21061.00

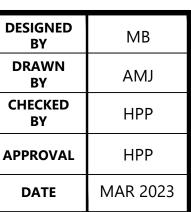

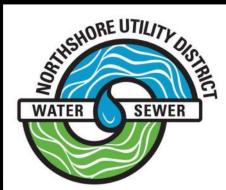

NORTHSHORE UTILITY DISTRICT

6830 NE 185th St. Kenmore, WA 98028-2684

P.O. Box 82489 Kenmore, WA 98028-2684

Ph: (425) 398-4400 | **Fax:** (425) 398-4430 | **www.nud.net**

CONTRACT 2023-02 WOODLAND COVE WATER SERVICE REPLACEMENT

SCHEDULE A PHASE 2


BASE MAP L7 C1817

SHEET

<u>10</u> of <u>24</u>

NW 1/4, SEC 31, T26N, R5E



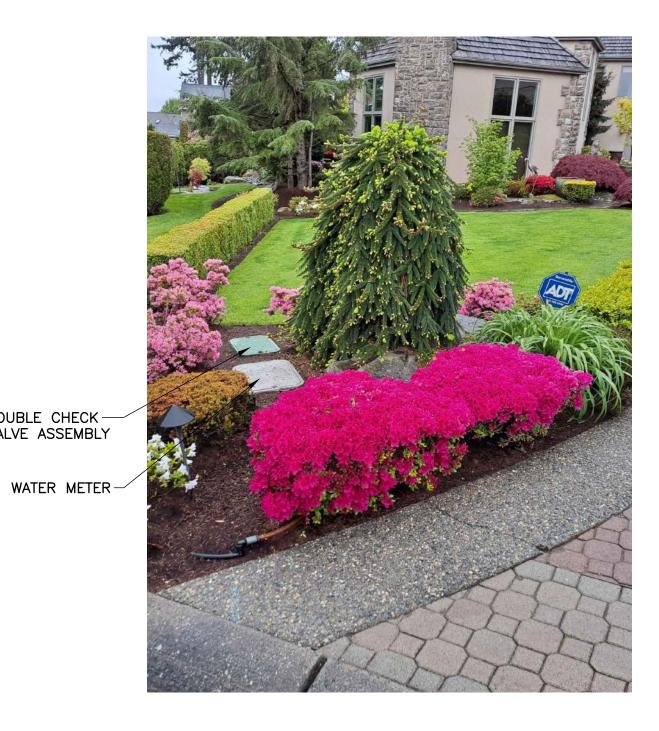



10933 WATER SERVICE

8407 WATER SERVICE

8413 WATER SERVICE







-DOUBLE CHECK VALVE ASSEMBLY

8419 WATER SERVICE

8425 WATER SERVICE

DESIGNED BY

DRAWN

CHECKED


APPROVAL

8431 WATER SERVICE

NO	ВҮ	APPD	REVISION	DATE
		· E	BID SET DRAWING - NOT FOR CONSTRUCTION	

VARNING	PACE An Engineering Services Company
THIS BAR DOES DT MEASURE 1"	11255 Kirkland Way, Suite 300 Kirkland, WA 98033 p. 425.827.2014 f. 425.827.5
IEN DRAWING NOT TO SCALE	Civil Structural Planning Supaceengrs.com
	PACE JOB # 21061.

'	PACE An Engineering Services Company
5	11255 Kirkland Way, Suite 300 Kirkland, WA 98033 p. 425.827.2014 f. 425.827.5043
9	Civil Structural Planning Survey paceengrs.com
	PACE JOB # 21061.00

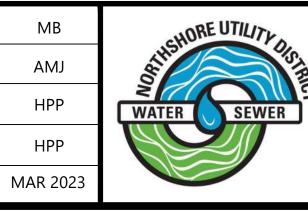

NORTHSHORE	UTILITY DISTRIC
6830 NE 185th St.	P.O. Box 82489

6830 NE 185th St. Kenmore, WA 98028-2684 Kenmore, WA 98028-2684


Ph: (425) 398-4400 | **Fax:** (425) 398-4430 | **www.nud.net**


CONTRACT 2023-02 WOODLAND COVE WATER SERVICE REPLACEMENT

SCHEDULE A PHASE 2




BASE MAP L7 C1817 SHEET <u>11</u> of <u>24</u>

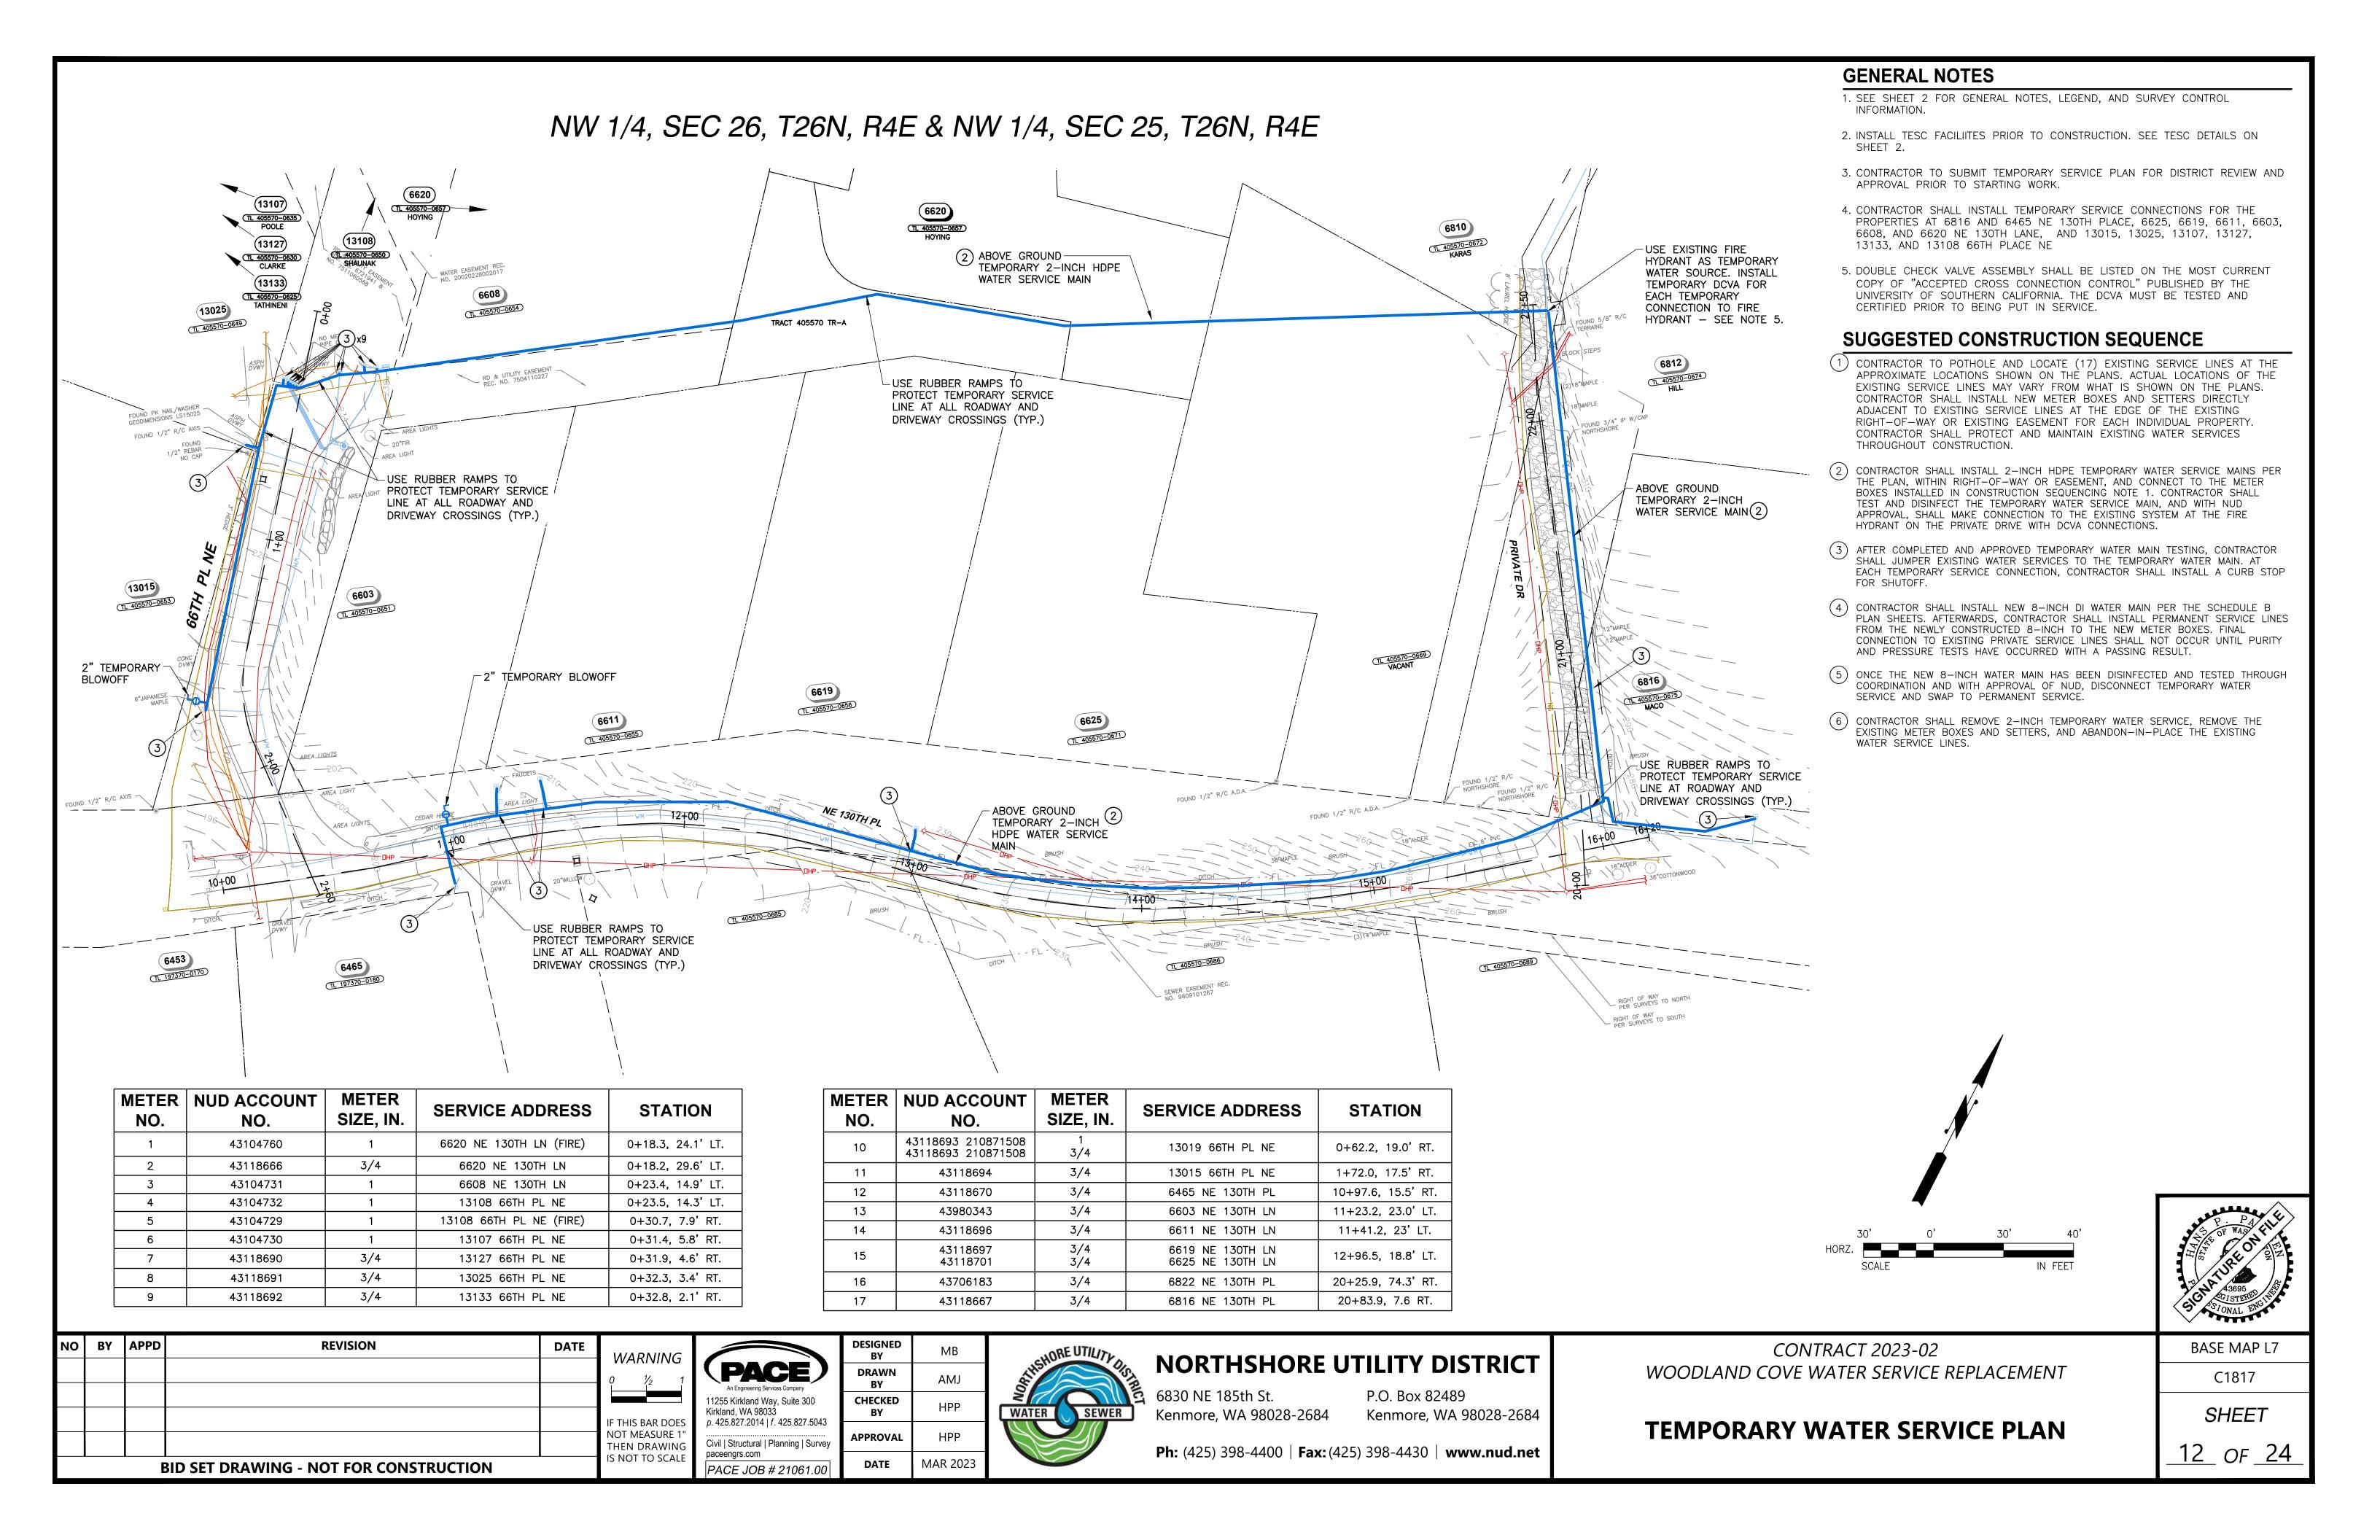

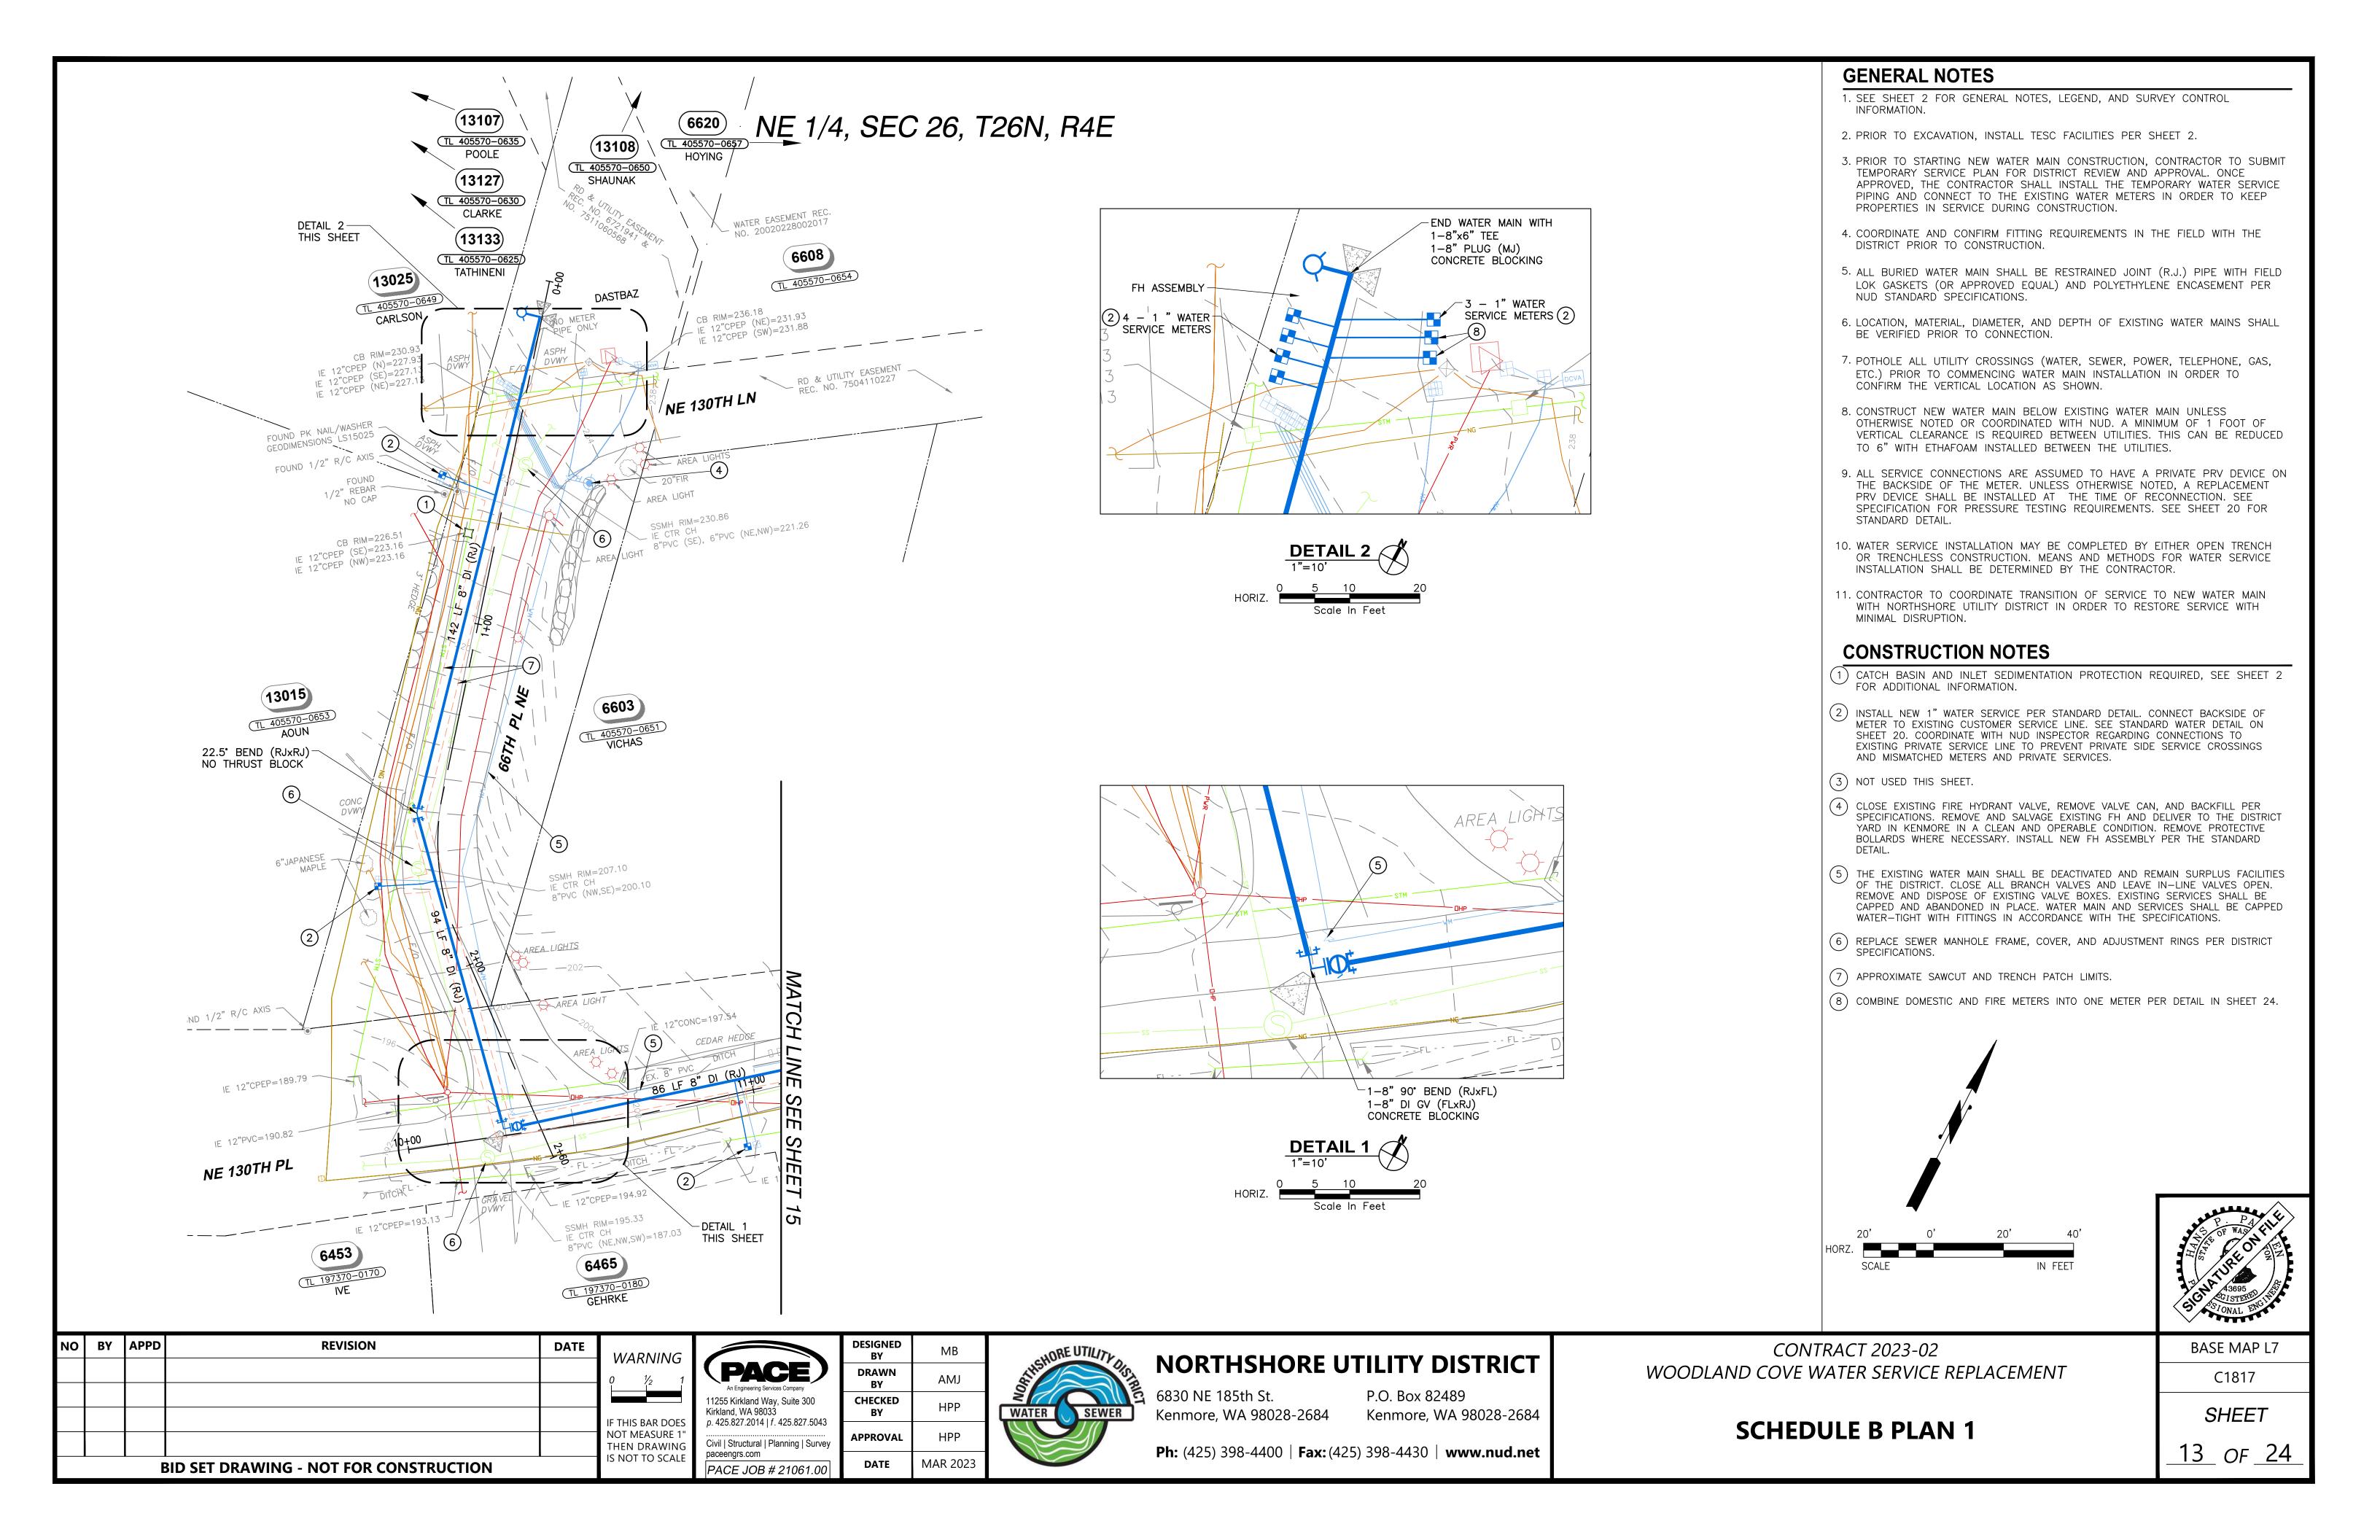

NE 1/4, SEC 26, T26N, R4E

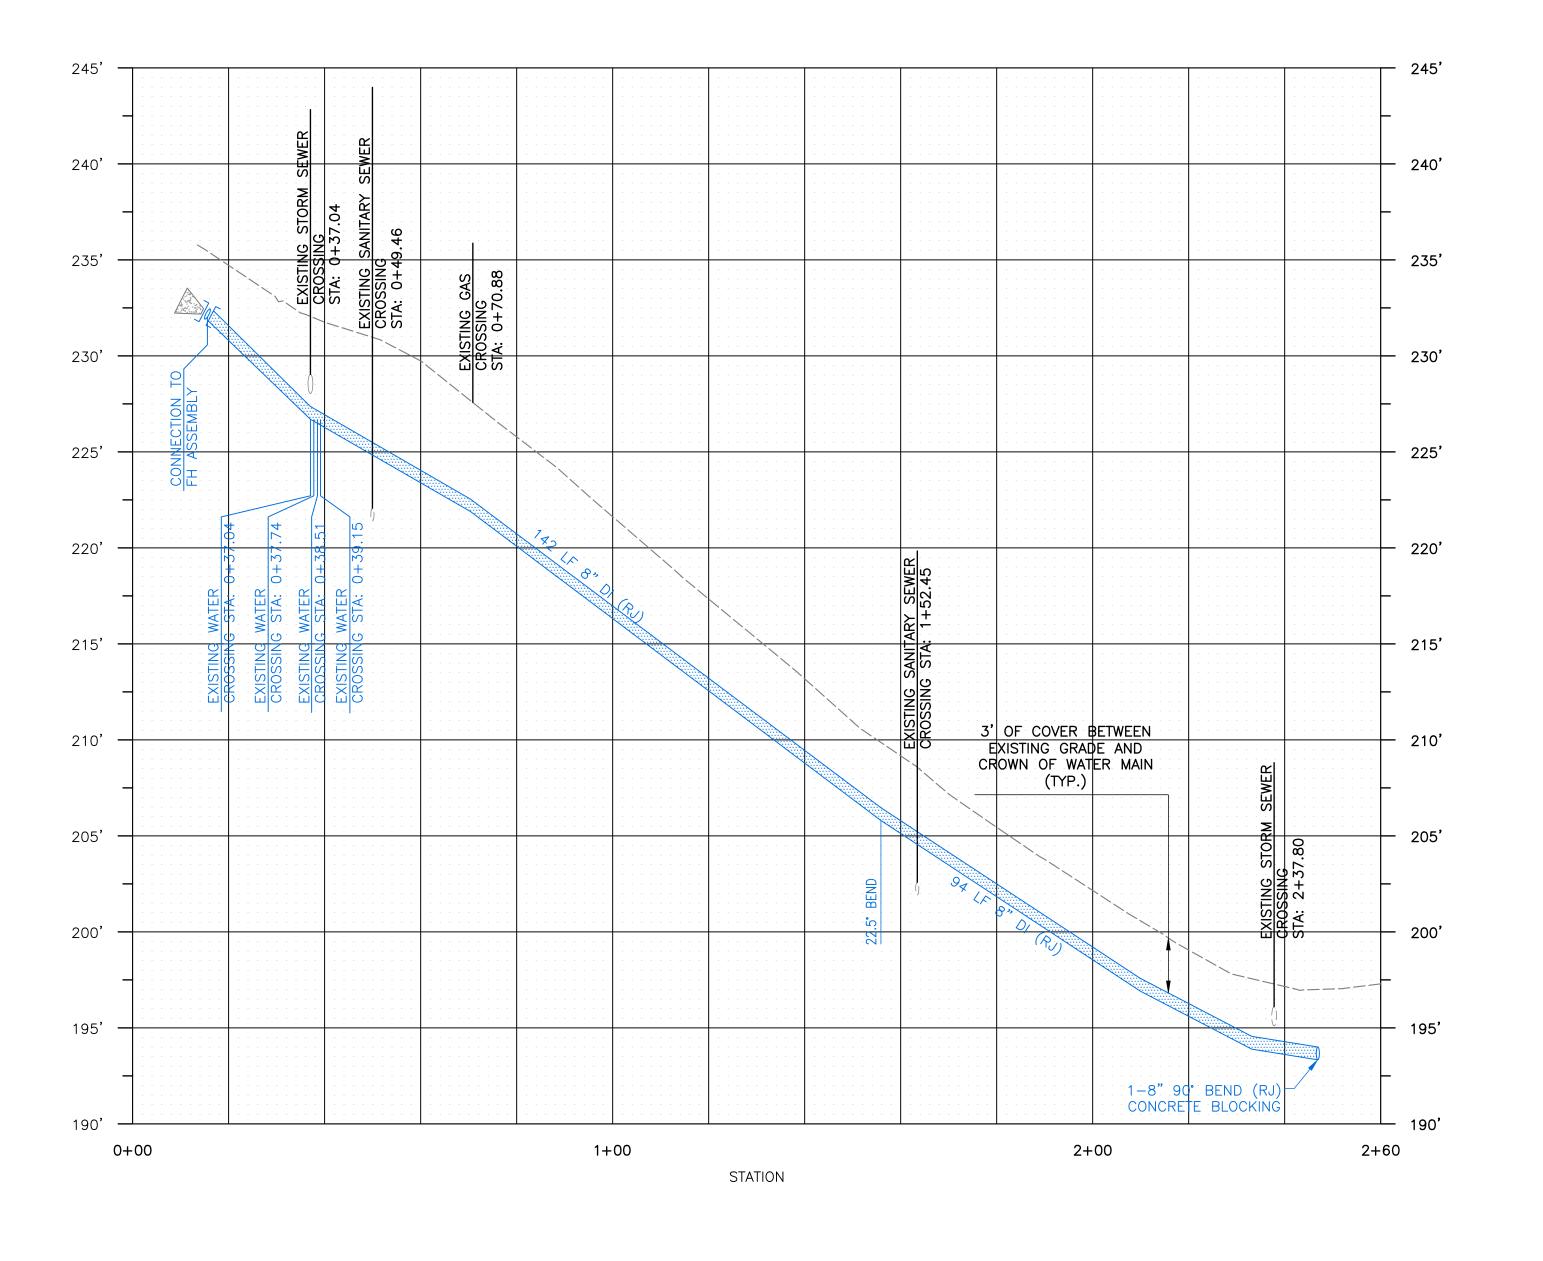

GENERAL NOTES

1. SEE SHEET 2 FOR GENERAL NOTES, LEGEND, AND SURVEY CONTROL INFORMATION.

- 2. PRIOR TO EXCAVATION, INSTALL TESC FACILITIES PER SHEET 2.
- 3. PRIOR TO STARTING NEW WATER MAIN CONSTRUCTION, CONTRACTOR TO SUBMIT TEMPORARY SERVICE PLAN FOR DISTRICT REVIEW AND APPROVAL. ONCE APPROVED, THE CONTRACTOR SHALL INSTALL THE TEMPORARY WATER SERVICE PIPING AND CONNECT TO THE EXISTING WATER METERS IN ORDER TO KEEP PROPERTIES IN SERVICE DURING CONSTRUCTION.
- 4. COORDINATE AND CONFIRM FITTING REQUIREMENTS IN THE FIELD WITH THE DISTRICT PRIOR TO CONSTRUCTION.
- 5. ALL BURIED WATER MAIN SHALL BE RESTRAINED JOINT (R.J.) PIPE WITH FIELD LOK GASKETS (OR APPROVED EQUAL) AND POLYETHYLENE ENCASEMENT PER NUD STANDARD SPECIFICATIONS.
- 6. LOCATION, MATERIAL, DIAMETER, AND DEPTH OF EXISTING WATER MAINS SHALL BE VERIFIED PRIOR TO CONNECTION.
- 7. POTHOLE ALL UTILITY CROSSINGS (WATER, SEWER, POWER, TELEPHONE, GAS, ETC.) PRIOR TO COMMENCING WATER MAIN INSTALLATION IN ORDER TO CONFIRM THE VERTICAL LOCATION AS SHOWN.
- 8. CONSTRUCT NEW WATER MAIN BELOW EXISTING WATER MAIN UNLESS OTHERWISE NOTED OR COORDINATED WITH NUD. A MINIMUM OF 1 FOOT OF VERTICAL CLEARANCE IS REQUIRED BETWEEN UTILITIES. THIS CAN BE REDUCED TO 6" WITH ETHAFOAM INSTALLED BETWEEN THE UTILITIES.
- 9. ALL SERVICE CONNECTIONS ARE ASSUMED TO HAVE A PRIVATE PRV DEVICE ON THE BACKSIDE OF THE METERE. UNLESS OTHERWISE NOTED, A REPLACEMENT PRV DEVICE SHALL BE INSTALLED AT THE TIME OF RECONNECTION. SEE SPECIFICATION FOR PRESSURE TESTING REQUIREMENTS. SEE SHEET 20 FOR STANDARD DETAIL.
- 10. WATER SERVICE INSTALLATION MAY BE COMPLETED BY EITHER OPEN TRENCH OR TRENCHLESS CONSTRUCTION. MEANS AND METHODS FOR WATER SERVICE INSTALLATION SHALL BE DETERMINED BY THE CONTRACTOR.
- 11. CONTRACTOR TO COORDINATE TRANSITION OF SERVICE TO NEW WATER MAIN WITH NORTHSHORE UTILITY DISTRICT IN ORDER TO RESTORE SERVICE WITH MINIMAL DISRUPTION.

CONSTRUCTION NOTES

- (1) CATCH BASIN AND INLET SEDIMENTATION PROTECTION REQUIRED, SEE SHEET 2 FOR ADDITIONAL INFORMATION.
- 2) INSTALL NEW 1" WATER SERVICE PER STANDARD DETAIL. CONNECT BACKSIDE OF METER TO EXISTING CUSTOMER SERVICE LINE. SEE STANDARD WATER DETAIL ON SHEET 20.
- PROPOSED WATER MAIN SHALL BE LOCATED WITHIN EXISTING WATER MAIN ALIGNMENT ALONG NE 130TH STREET BETWEEN INTERSECTIONS OF 66TH PL NE AND PRIVATE DRIVE. EXISTING WATER MAIN SHALL BE REMOVED AND DISPOSED OF IN ACCORDANCE WITH DISTRICT SPECIFICATIONS.
- 4 CLOSE EXISTING FIRE HYDRANT VALVE, REMOVE VALVE CAN, AND BACKFILL PER SPECIFICATIONS. REMOVE AND SALVAGE EXISTING FH AND DELIVER TO THE DISTRICT YARD IN KENMORE IN A CLEAN AND OPERABLE CONDITION. REMOVE PROTECTIVE BOLLARDS WHERE NECESSARY. INSTALL NEW FH ASSEMBLY PER THE STANDARD DETAIL
- THE EXISTING WATER MAIN SHALL BE DEACTIVATED AND REMAIN SURPLUS FACILITIES OF THE DISTRICT. CLOSE ALL BRANCH VALVES AND LEAVE IN—LINE VALVES OPEN. REMOVE AND DISPOSE OF EXISTING VALVE BOXES. THE PIPE SHALL BE CAPPED WATER—TIGHT WITH FITTINGS IN ACCORDANCE WITH THE SPECIFICATIONS.
- (6) REPLACE SEWER MANHOLE PER DISTRICT SPECIFICATIONS.

	20'	0'	20'	40'
HORZ.				
	SCALE			IN FEET
VERT.	5'	0'	5'	10'
	SCALE			IN FEET

A 3695 CHARLES OF WASHINGTON O

WOODLAND COVE WATER SERVICE REPLACEMENT

BASE MAP L7 C1817

SHEET

<u>14</u> of <u>24</u>

SCHEDULE B PROFILE 1

CONTRACT 2023-02

NORTHSHORE UTILITY DISTRICT

6830 NE 185th St. P.O. Box 82489 Kenmore, WA 98028-2684 Kenmore, WA 98028-2684

Ph: (425) 398-4400 | **Fax:** (425) 398-4430 | **www.nud.net**

		0 1/2
		IF THIS BAR D

REVISION

BID SET DRAWING - NOT FOR CONSTRUCTION

BY APPD

IF THIS BAR DOES
NOT MEASURE 1"
THEN DRAWING
IS NOT TO SCALE


An Engineering Services Company
11255 Kirkland Way, Suite 300
Kirkland, WA 98033
p. 425.827.2014 | f. 425.827.5043
Civil | Structural | Planning | Survey paceengrs.com

PACE JOB # 21061.00

DATE



NE 1/4, SEC 26, T26N, R4E AND NW 1/4 SEC 25, T26N, R4E

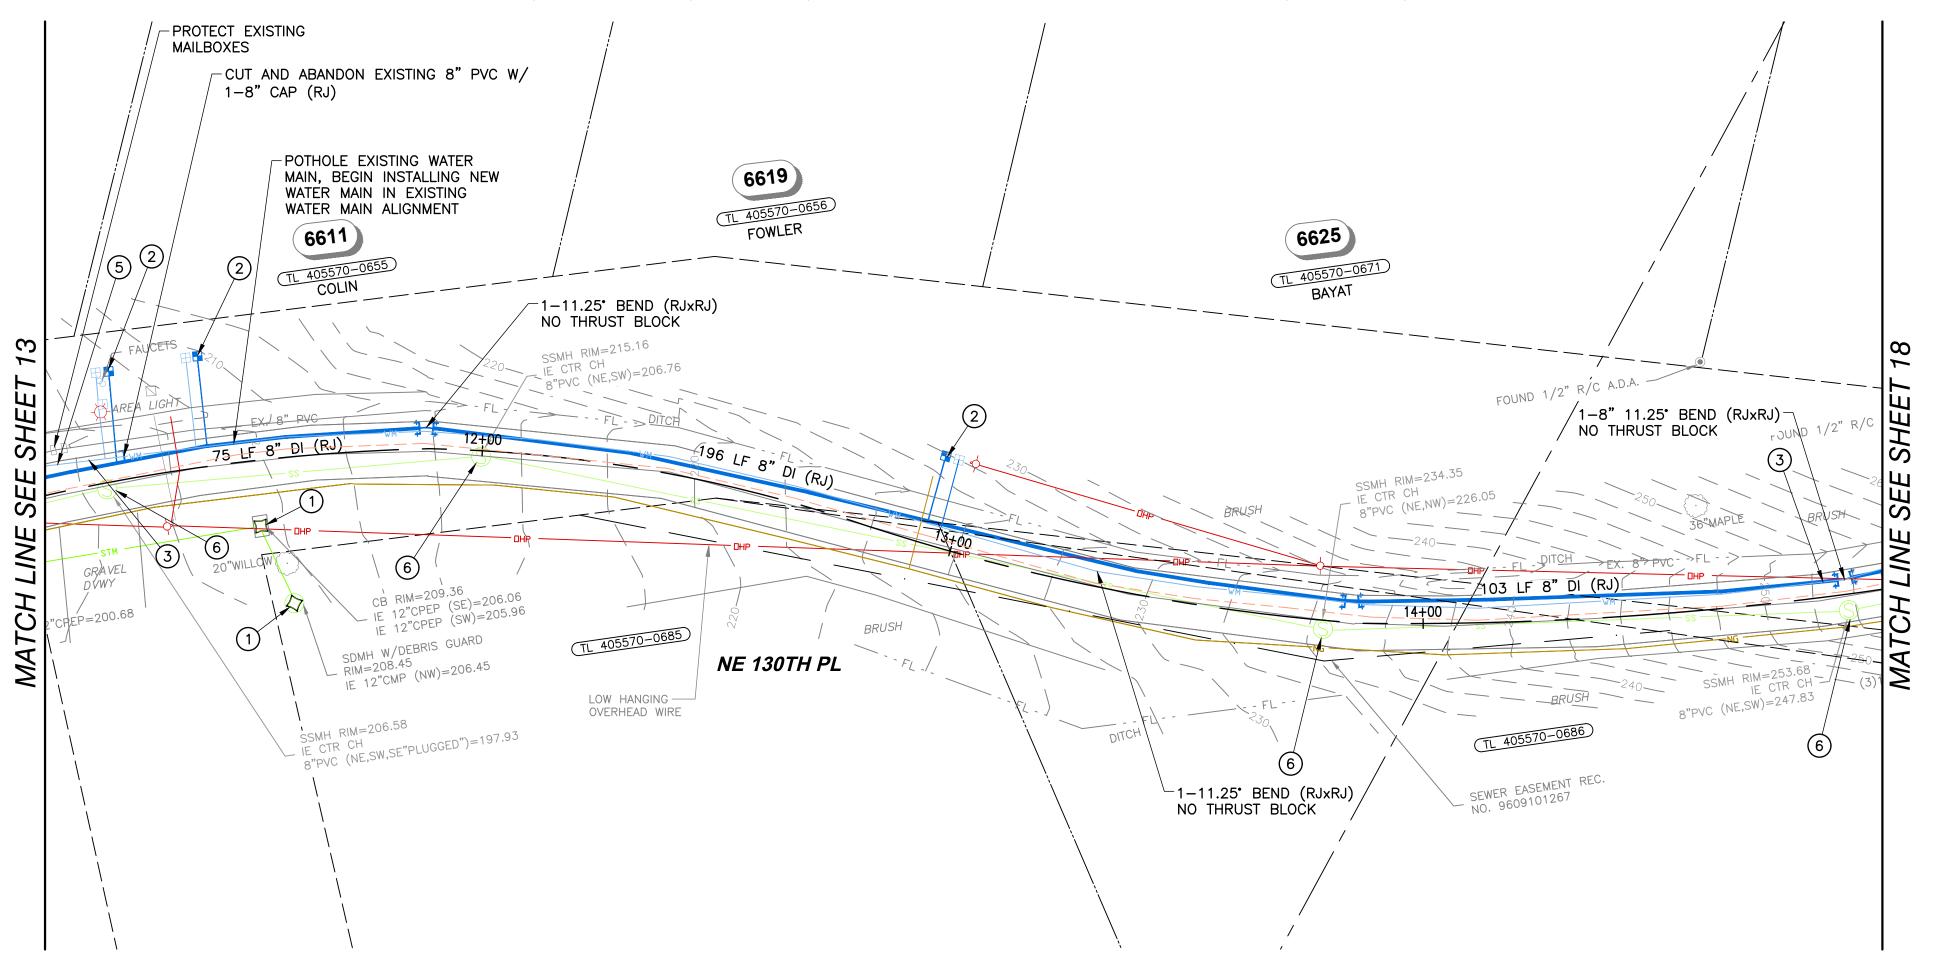


GENERAL NOTES

1. SEE SHEET 2 FOR GENERAL NOTES, LEGEND, AND SURVEY CONTROL INFORMATION.

- 2. PRIOR TO EXCAVATION, INSTALL TESC FACILITIES PER SHEET 2.
- 3. PRIOR TO STARTING NEW WATER MAIN CONSTRUCTION, CONTRACTOR TO SUBMIT TEMPORARY SERVICE PLAN FOR DISTRICT REVIEW AND APPROVAL. ONCE APPROVED, THE CONTRACTOR SHALL INSTALL THE TEMPORARY WATER SERVICE PIPING AND CONNECT TO THE EXISTING WATER METERS IN ORDER TO KEEP PROPERTIES IN SERVICE DURING CONSTRUCTION.
- 4. COORDINATE AND CONFIRM FITTING REQUIREMENTS IN THE FIELD WITH THE DISTRICT PRIOR TO CONSTRUCTION.
- 5. ALL BURIED WATER MAIN SHALL BE RESTRAINED JOINT (R.J.) PIPE WITH FIELD LOK GASKETS (OR APPROVED EQUAL) AND POLYETHYLENE ENCASEMENT PER NUD STANDARD SPECIFICATIONS.
- 6. LOCATION, MATERIAL, DIAMETER, AND DEPTH OF EXISTING WATER MAINS SHALL BE VERIFIED PRIOR TO CONNECTION.
- 7. POTHOLE ALL UTILITY CROSSINGS (WATER, SEWER, POWER, TELEPHONE, GAS, ETC.) PRIOR TO COMMENCING WATER MAIN INSTALLATION IN ORDER TO CONFIRM THE VERTICAL LOCATION AS SHOWN.
- 8. CONSTRUCT NEW WATER MAIN BELOW EXISTING WATER MAIN UNLESS OTHERWISE NOTED OR COORDINATED WITH NUD. A MINIMUM OF 1 FOOT OF VERTICAL CLEARANCE IS REQUIRED BETWEEN UTILITIES. THIS CAN BE REDUCED TO 6" WITH ETHAFOAM INSTALLED BETWEEN THE UTILITIES.
- 9. ALL SERVICE CONNECTIONS ARE ASSUMED TO HAVE A PRIVATE PRV DEVICE ON THE BACKSIDE OF THE METERE. UNLESS OTHERWISE NOTED, A REPLACEMENT PRV DEVICE SHALL BE INSTALLED AT THE TIME OF RECONNECTION. SEE SPECIFICATION FOR PRESSURE TESTING REQUIREMENTS. SEE SHEET 20 FOR STANDARD DETAIL.
- 10. WATER SERVICE INSTALLATION MAY BE COMPLETED BY EITHER OPEN TRENCH OR TRENCHLESS CONSTRUCTION. MEANS AND METHODS FOR WATER SERVICE INSTALLATION SHALL BE DETERMINED BY THE CONTRACTOR.
- 11. CONTRACTOR TO COORDINATE TRANSITION OF SERVICE TO NEW WATER MAIN WITH NORTHSHORE UTILITY DISTRICT IN ORDER TO RESTORE SERVICE WITH MINIMAL DISRUPTION.

CONSTRUCTION NOTES

- (1) CATCH BASIN AND INLET SEDIMENTATION PROTECTION REQUIRED, SEE SHEET 2 FOR ADDITIONAL INFORMATION.
- 2) INSTALL NEW 1" WATER SERVICE PER STANDARD DETAIL. CONNECT BACKSIDE OF METER TO EXISTING CUSTOMER SERVICE LINE. SEE STANDARD WATER DETAIL ON SHEET 20.
- PROPOSED WATER MAIN SHALL BE LOCATED WITHIN EXISTING WATER MAIN ALIGNMENT ALONG NE 130TH STREET BETWEEN INTERSECTIONS OF 66TH PL NE AND PRIVATE DRIVE. EXISTING WATER MAIN SHALL BE REMOVED AND DISPOSED OF IN ACCORDANCE WITH DISTRICT SPECIFICATIONS.
- (4) CLOSE EXISTING FIRE HYDRANT VALVE, REMOVE VALVE CAN, AND BACKFILL PER SPECIFICATIONS. REMOVE AND SALVAGE EXISTING FH AND DELIVER TO THE DISTRICT YARD IN KENMORE IN A CLEAN AND OPERABLE CONDITION. REMOVE PROTECTIVE BOLLARDS WHERE NECESSARY. INSTALL NEW FH ASSEMBLY PER THE STANDARD DETAIL
- THE EXISTING WATER MAIN SHALL BE DEACTIVATED AND REMAIN SURPLUS FACILITIES OF THE DISTRICT. CLOSE ALL BRANCH VALVES AND LEAVE IN—LINE VALVES OPEN. REMOVE AND DISPOSE OF EXISTING VALVE BOXES. THE PIPE SHALL BE CAPPED WATER—TIGHT WITH FITTINGS IN ACCORDANCE WITH THE SPECIFICATIONS.
- (6) REPLACE SEWER MANHOLE PER DISTRICT SPECIFICATIONS.

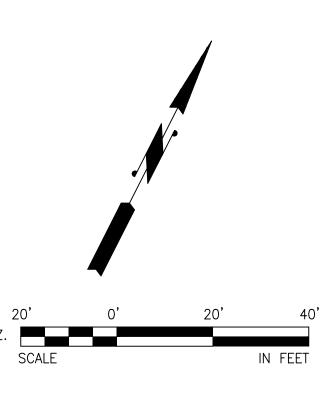



NO	BY	APPD	REVISION	DATE	l v
					0
					IF
					N TI
		·	BID SET DRAWING - NOT FOR CONSTRUCTION	1	IS

WARNING 0 ½ 1	PACE An Engineering Services Company
IF THIS BAR DOES	11255 Kirkland Way, Suite 3 Kirkland, WA 98033 p. 425.827.2014 f. 425.827
NOT MEASURE 1" THEN DRAWING IS NOT TO SCALE	Civil Structural Planning paceengrs.com
10 110 110 30/122	PACE JOB # 2106

	DESIGNED BY	МВ
Dempany Dempany	DRAWN BY	AMJ
uite 300	CHECKED BY	HPP
5.827.5043 ning Survey	APPROVAL	HPP
1061.00	DATE	MAR 202
	*	



NORTHSHORE UTILITY DISTRICT

6830 NE 185th St. Kenmore, WA 98028-2684 P.O. Box 82489 Kenmore, WA 98028-2684

Ph: (425) 398-4400 | **Fax:** (425) 398-4430 | **www.nud.net**

CONTRACT 2023-02
WOODLAND COVE WATER SERVICE REPLACEMENT

SCHEDULE B PLAN 2


BASE MAP L7

C1817

SHEET

15 OF 24

NE 1/4, SEC 26, T26N, R4E

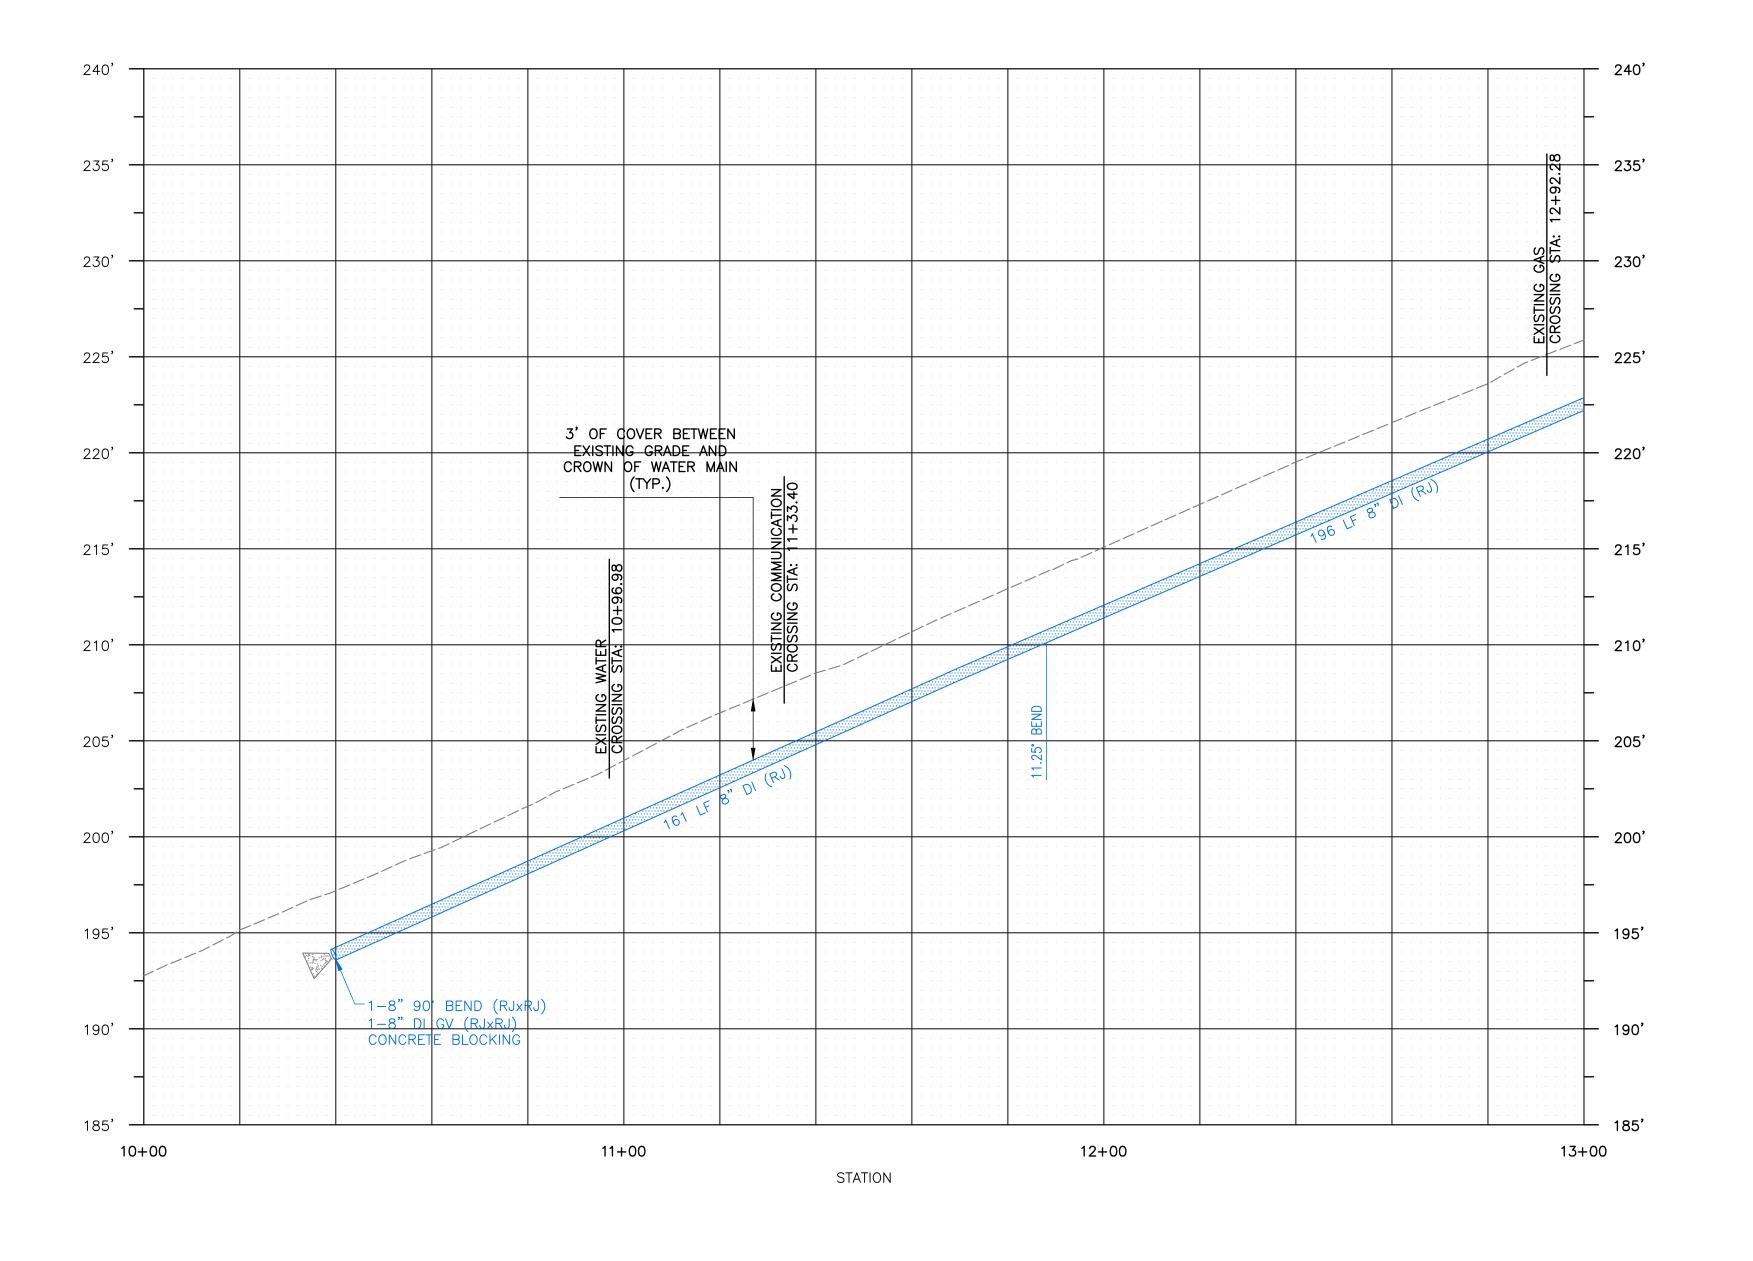


GENERAL NOTES


1. SEE SHEET 2 FOR GENERAL NOTES, LEGEND, AND SURVEY CONTROL INFORMATION.

- 2. PRIOR TO EXCAVATION, INSTALL TESC FACILITIES PER SHEET 2.
- 3. PRIOR TO STARTING NEW WATER MAIN CONSTRUCTION, CONTRACTOR TO SUBMIT TEMPORARY SERVICE PLAN FOR DISTRICT REVIEW AND APPROVAL. ONCE APPROVED, THE CONTRACTOR SHALL INSTALL THE TEMPORARY WATER SERVICE PIPING AND CONNECT TO THE EXISTING WATER METERS IN ORDER TO KEEP PROPERTIES IN SERVICE DURING CONSTRUCTION.
- 4. COORDINATE AND CONFIRM FITTING REQUIREMENTS IN THE FIELD WITH THE DISTRICT PRIOR TO CONSTRUCTION.
- 5. ALL BURIED WATER MAIN SHALL BE RESTRAINED JOINT (R.J.) PIPE WITH FIELD LOK GASKETS (OR APPROVED EQUAL) AND POLYETHYLENE ENCASEMENT PER NUD STANDARD SPECIFICATIONS.
- 6. LOCATION, MATERIAL, DIAMETER, AND DEPTH OF EXISTING WATER MAINS SHALL BE VERIFIED PRIOR TO CONNECTION.
- 7. POTHOLE ALL UTILITY CROSSINGS (WATER, SEWER, POWER, TELEPHONE, GAS, ETC.) PRIOR TO COMMENCING WATER MAIN INSTALLATION IN ORDER TO CONFIRM THE VERTICAL LOCATION AS SHOWN.
- 8. CONSTRUCT NEW WATER MAIN BELOW EXISTING WATER MAIN UNLESS OTHERWISE NOTED OR COORDINATED WITH NUD. A MINIMUM OF 1 FOOT OF VERTICAL CLEARANCE IS REQUIRED BETWEEN UTILITIES. THIS CAN BE REDUCED TO 6" WITH ETHAFOAM INSTALLED BETWEEN THE UTILITIES.
- 9. ALL SERVICE CONNECTIONS ARE ASSUMED TO HAVE A PRIVATE PRV DEVICE ON THE BACKSIDE OF THE METERE. UNLESS OTHERWISE NOTED, A REPLACEMENT PRV DEVICE SHALL BE INSTALLED AT THE TIME OF RECONNECTION. SEE SPECIFICATION FOR PRESSURE TESTING REQUIREMENTS. SEE SHEET 20 FOR STANDARD DETAIL.
- 10. WATER SERVICE INSTALLATION MAY BE COMPLETED BY EITHER OPEN TRENCH OR TRENCHLESS CONSTRUCTION. MEANS AND METHODS FOR WATER SERVICE INSTALLATION SHALL BE DETERMINED BY THE CONTRACTOR.
- 11. CONTRACTOR TO COORDINATE TRANSITION OF SERVICE TO NEW WATER MAIN WITH NORTHSHORE UTILITY DISTRICT IN ORDER TO RESTORE SERVICE WITH MINIMAL DISRUPTION.

CONSTRUCTION NOTES

- (1) CATCH BASIN AND INLET SEDIMENTATION PROTECTION REQUIRED, SEE SHEET 2 FOR ADDITIONAL INFORMATION.
- 2 INSTALL NEW 1" WATER SERVICE PER STANDARD DETAIL. CONNECT BACKSIDE OF METER TO EXISTING CUSTOMER SERVICE LINE. SEE STANDARD WATER DETAIL ON
- (3) PROPOSED WATER MAIN SHALL BE LOCATED WITHIN EXISTING WATER MAIN ALIGNMENT ALONG NE 130TH STREET BETWEEN INTERSECTIONS OF 66TH PL NE AND PRIVATE DRIVE. EXISTING WATER MAIN SHALL BE REMOVED AND DISPOSED OF IN ACCORDANCE WITH DISTRICT SPECIFICATIONS.
- (4) CLOSE EXISTING FIRE HYDRANT VALVE, REMOVE VALVE CAN, AND BACKFILL PER SPECIFICATIONS. REMOVE AND SALVAGE EXISTING FH AND DELIVER TO THE DISTRICT YARD IN KENMORE IN A CLEAN AND OPERABLE CONDITION. REMOVE PROTECTIVE BOLLARDS WHERE NECESSARY. INSTALL NEW FH ASSEMBLY PER THE STANDARD
- 5 THE EXISTING WATER MAIN SHALL BE DEACTIVATED AND REMAIN SURPLUS FACILITIES
 OF THE DISTRICT CLOSE ALL READER VALVES AND LEAVE IN LINE VALVES OPEN OF THE DISTRICT. CLOSE ALL BRANCH VALVES AND LEAVE IN-LINE VALVES OPEN. REMOVE AND DISPOSE OF EXISTING VALVE BOXES. THE PIPE SHALL BE CAPPED WATER-TIGHT WITH FITTINGS IN ACCORDANCE WITH THE SPECIFICATIONS.
- (6) REPLACE SEWER MANHOLE PER DISTRICT SPECIFICATIONS.

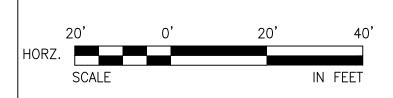


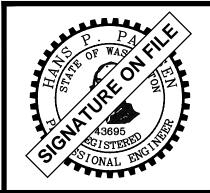

NO	BY	APPD	REVISION	DATE	И
					$\begin{bmatrix} \mathbf{v}_1 \\ \mathbf{o} \end{bmatrix}$
					IF T
					NO THI
	BID SET DRAWING - NOT FOR CONSTRUCTION				IS N



	DESIGNED BY	
Engineering Services Company	DRAWN BY	
Kirkland Way, Suite 300 d, WA 98033	CHECKED BY	
327.2014 f. 425.827.5043 tructural Planning Survey	APPROVAL	
grs.com E JOB # 21061.00	DATE	М

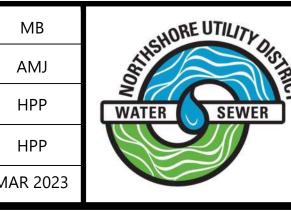

AMJ

HPP

NORTHSHORE	UTILITY DISTRICT	
		ı

6830 NE 185th St. P.O. Box 82489 Kenmore, WA 98028-2684 Kenmore, WA 98028-2684

Ph: (425) 398-4400 | **Fax:** (425) 398-4430 | **www.nud.net**

CONTRACT 2023-02 WOODLAND COVE WATER SERVICE REPLACEMENT


SCHEDULE B PROFILE 2


BASE MAP L7 C1817

SHEET

<u>16</u> of <u>24</u>

NE 1/4, SEC 26, T26N, R4E

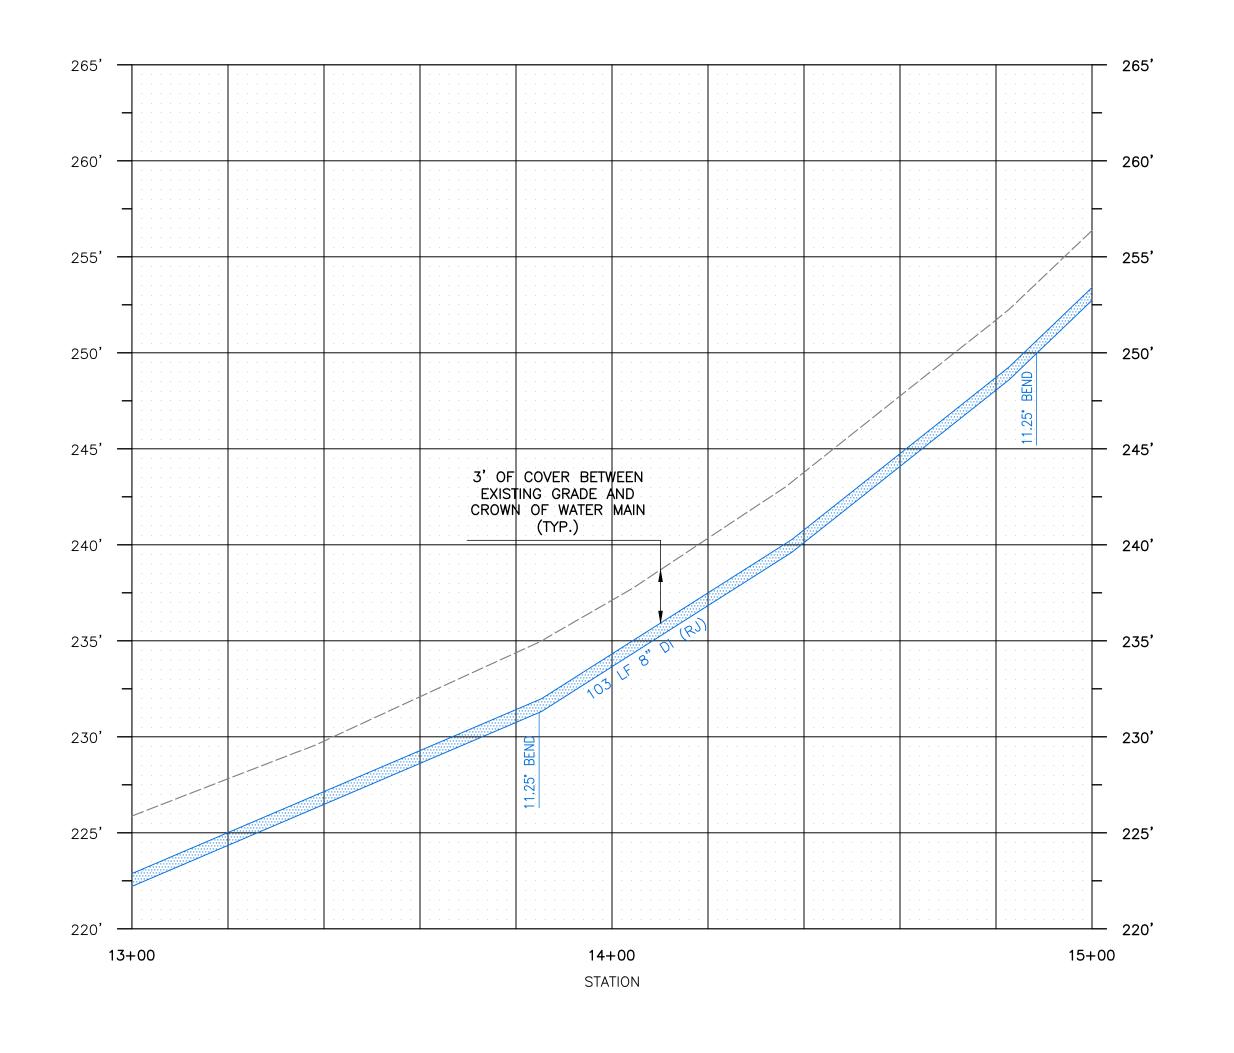

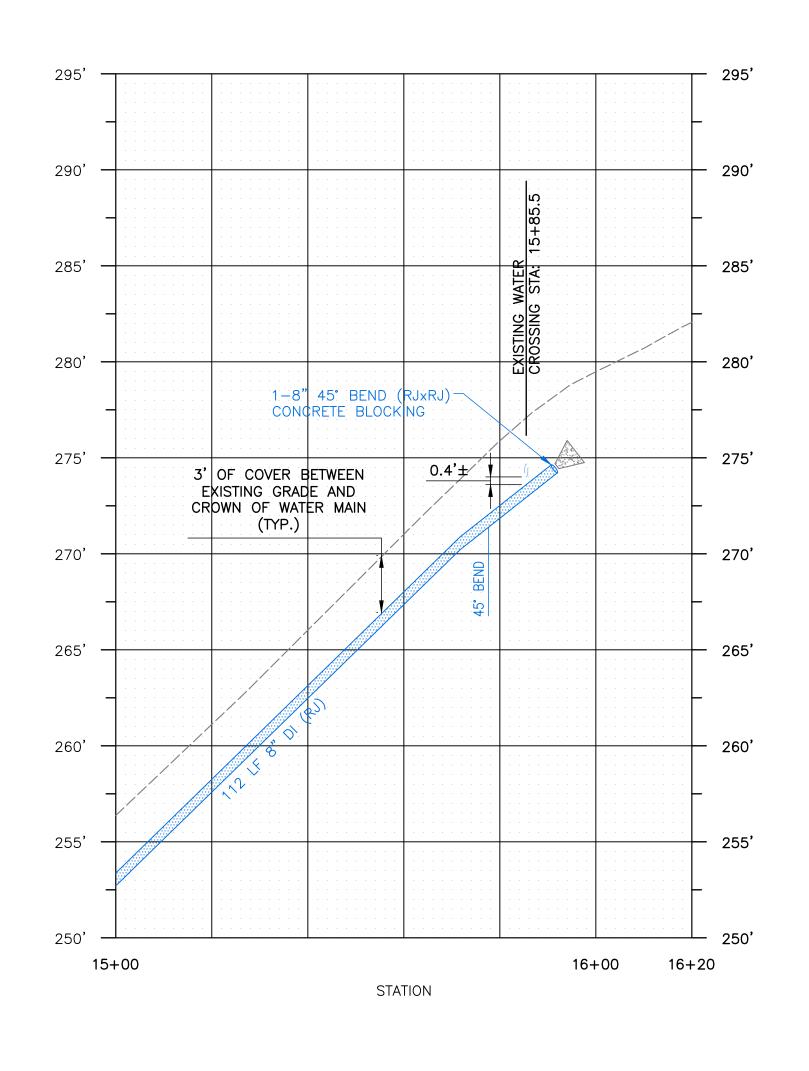


GENERAL NOTES


1. SEE SHEET 2 FOR GENERAL NOTES, LEGEND, AND SURVEY CONTROL INFORMATION.

- 2. PRIOR TO EXCAVATION, INSTALL TESC FACILITIES PER SHEET 2.
- 3. PRIOR TO STARTING NEW WATER MAIN CONSTRUCTION, CONTRACTOR TO SUBMIT TEMPORARY SERVICE PLAN FOR DISTRICT REVIEW AND APPROVAL. ONCE APPROVED, THE CONTRACTOR SHALL INSTALL THE TEMPORARY WATER SERVICE PIPING AND CONNECT TO THE EXISTING WATER METERS IN ORDER TO KEEP PROPERTIES IN SERVICE DURING CONSTRUCTION.
- 4. COORDINATE AND CONFIRM FITTING REQUIREMENTS IN THE FIELD WITH THE DISTRICT PRIOR TO CONSTRUCTION.
- 5. ALL BURIED WATER MAIN SHALL BE RESTRAINED JOINT (R.J.) PIPE WITH FIELD LOK GASKETS (OR APPROVED EQUAL) AND POLYETHYLENE ENCASEMENT PER NUD STANDARD SPECIFICATIONS.
- 6. LOCATION, MATERIAL, DIAMETER, AND DEPTH OF EXISTING WATER MAINS SHALL BE VERIFIED PRIOR TO CONNECTION.
- 7. POTHOLE ALL UTILITY CROSSINGS (WATER, SEWER, POWER, TELEPHONE, GAS, ETC.) PRIOR TO COMMENCING WATER MAIN INSTALLATION IN ORDER TO CONFIRM THE VERTICAL LOCATION AS SHOWN.
- 8. CONSTRUCT NEW WATER MAIN BELOW EXISTING WATER MAIN UNLESS OTHERWISE NOTED OR COORDINATED WITH NUD. A MINIMUM OF 1 FOOT OF VERTICAL CLEARANCE IS REQUIRED BETWEEN UTILITIES. THIS CAN BE REDUCED TO 6" WITH ETHAFOAM INSTALLED BETWEEN THE UTILITIES.
- 9. ALL SERVICE CONNECTIONS ARE ASSUMED TO HAVE A PRIVATE PRV DEVICE ON THE BACKSIDE OF THE METERE. UNLESS OTHERWISE NOTED, A REPLACEMENT PRV DEVICE SHALL BE INSTALLED AT THE TIME OF RECONNECTION. SEE SPECIFICATION FOR PRESSURE TESTING REQUIREMENTS. SEE SHEET 20 FOR STANDARD DETAIL.
- 10. WATER SERVICE INSTALLATION MAY BE COMPLETED BY EITHER OPEN TRENCH OR TRENCHLESS CONSTRUCTION. MEANS AND METHODS FOR WATER SERVICE INSTALLATION SHALL BE DETERMINED BY THE CONTRACTOR.
- 11. CONTRACTOR TO COORDINATE TRANSITION OF SERVICE TO NEW WATER MAIN WITH NORTHSHORE UTILITY DISTRICT IN ORDER TO RESTORE SERVICE WITH MINIMAL DISRUPTION.

CONSTRUCTION NOTES

- (1) CATCH BASIN AND INLET SEDIMENTATION PROTECTION REQUIRED, SEE SHEET 2 FOR ADDITIONAL INFORMATION.
- 2) INSTALL NEW 1" WATER SERVICE PER STANDARD DETAIL. CONNECT BACKSIDE OF METER TO EXISTING CUSTOMER SERVICE LINE. SEE STANDARD WATER DETAIL ON
- (3) PROPOSED WATER MAIN SHALL BE LOCATED WITHIN EXISTING WATER MAIN ALIGNMENT ALONG NE 130TH STREET BETWEEN INTERSECTIONS OF 66TH PL NE AND PRIVATE DRIVE. EXISTING WATER MAIN SHALL BE REMOVED AND DISPOSED OF IN ACCORDANCE WITH DISTRICT SPECIFICATIONS.
- (4) CLOSE EXISTING FIRE HYDRANT VALVE, REMOVE VALVE CAN, AND BACKFILL PER SPECIFICATIONS. REMOVE AND SALVAGE EXISTING FH AND DELIVER TO THE DISTRICT YARD IN KENMORE IN A CLEAN AND OPERABLE CONDITION. REMOVE PROTECTIVE BOLLARDS WHERE NECESSARY. INSTALL NEW FH ASSEMBLY PER THE STANDARD
- 5 THE EXISTING WATER MAIN SHALL BE DEACTIVATED AND REMAIN SURPLUS FACILITIES
 OF THE DISTRICT CLOSE ALL READER VALVES AND LEAVE IN-LINE VALVES OPEN OF THE DISTRICT. CLOSE ALL BRANCH VALVES AND LEAVE IN-LINE VALVES OPEN. REMOVE AND DISPOSE OF EXISTING VALVE BOXES. THE PIPE SHALL BE CAPPED WATER-TIGHT WITH FITTINGS IN ACCORDANCE WITH THE SPECIFICATIONS.
- (6) REPLACE SEWER MANHOLE PER DISTRICT SPECIFICATIONS.

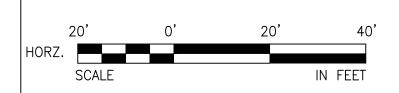


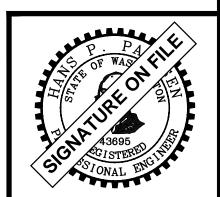

NO	BY	APPD	REVISION	DATE	W
					, VV
					IF TI
					NOT The
		E	BID SET DRAWING - NOT FOR CONSTRUCTION		IS N

RNING ½ 1	PACE An Engineering Services Company
	11255 Kirkland Way, Suite 300 Kirkland, WA 98033
BAR DOES	p. 425.827.2014 f. 425.827.50
EASURE 1"	
DRAWING	Civil Structural Planning Sur
TO SCALE	paceengrs.com

PACE JOB # 21061.00

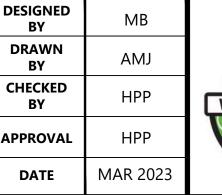



NORTHSHORE UTILITY DISTRICT

6830 NE 185th St. Kenmore, WA 98028-2684

P.O. Box 82489 Kenmore, WA 98028-2684

Ph: (425) 398-4400 | **Fax:** (425) 398-4430 | **www.nud.net**

CONTRACT 2023-02 WOODLAND COVE WATER SERVICE REPLACEMENT

SCHEDULE B PROFILE 2


BASE MAP L7

C1817

SHEET

<u>17</u> of <u>24</u>

NW 1/4, SEC 26, T26N, R4E & NW 1/4, SEC 25, T26N, R4E

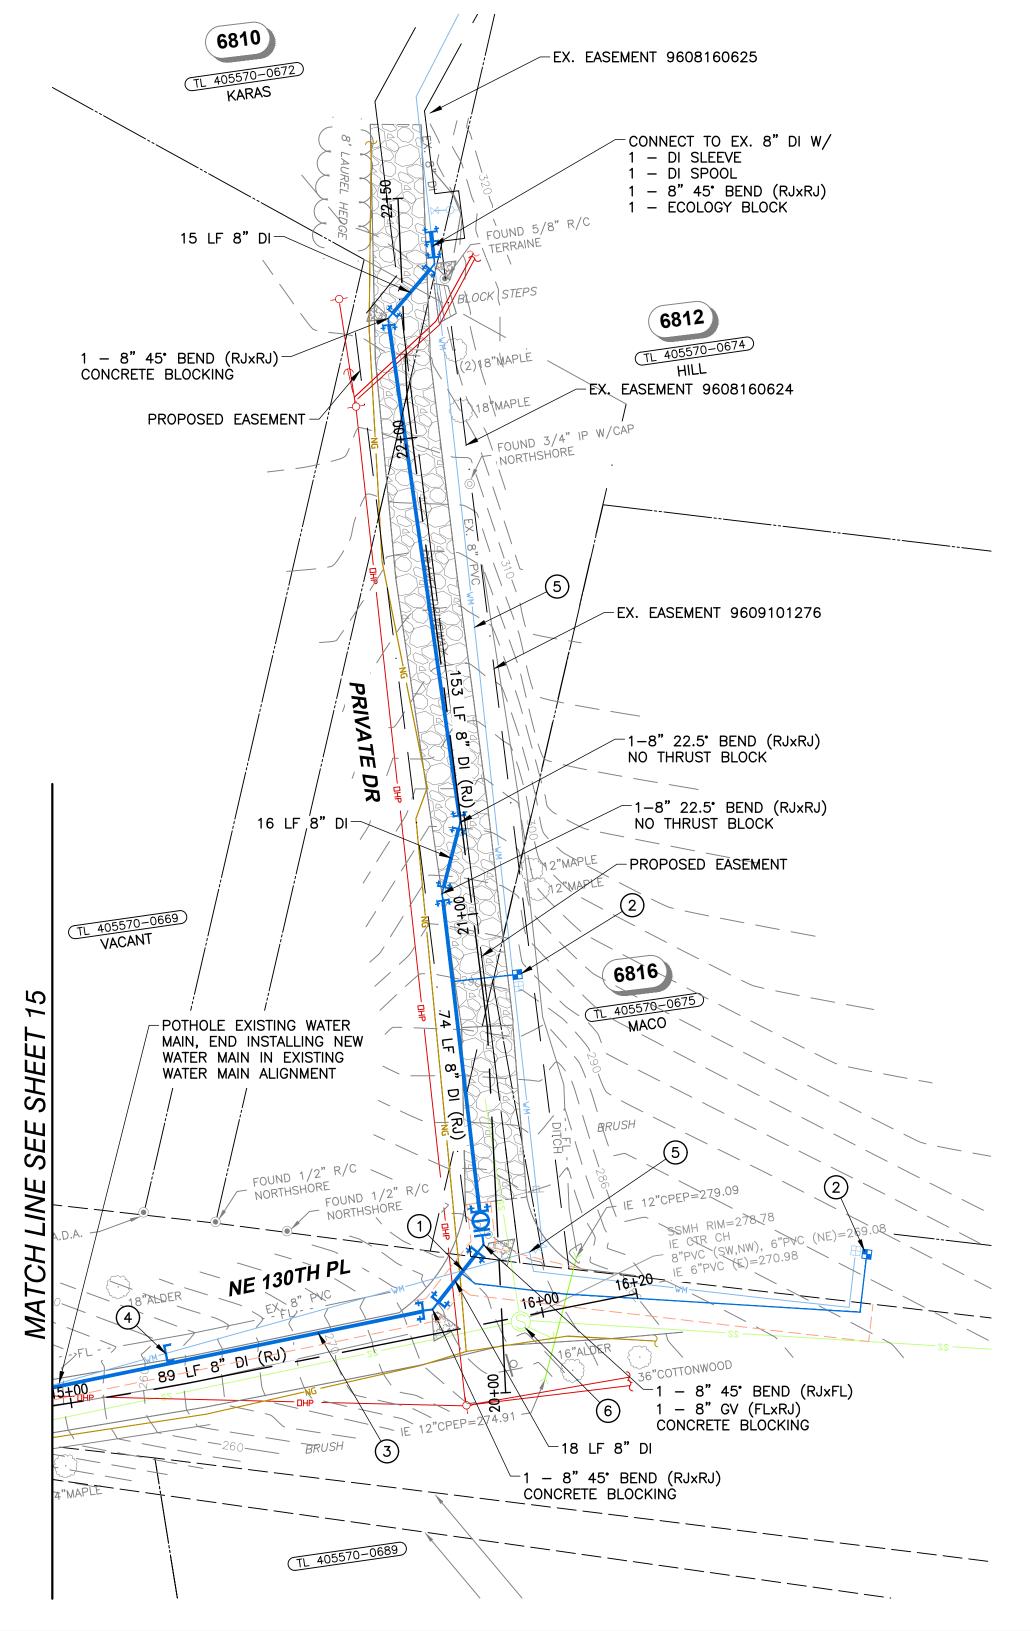


GENERAL NOTES

1. SEE SHEET 2 FOR GENERAL NOTES, LEGEND, AND SURVEY CONTROL INFORMATION.

- 2. PRIOR TO EXCAVATION, INSTALL TESC FACILITIES PER SHEET 2.
- 3. PRIOR TO STARTING NEW WATER MAIN CONSTRUCTION, CONTRACTOR TO SUBMIT TEMPORARY SERVICE PLAN FOR DISTRICT REVIEW AND APPROVAL. ONCE APPROVED, THE CONTRACTOR SHALL INSTALL THE TEMPORARY WATER SERVICE PIPING AND CONNECT TO THE EXISTING WATER METERS IN ORDER TO KEEP PROPERTIES IN SERVICE DURING CONSTRUCTION.
- 4. COORDINATE AND CONFIRM FITTING REQUIREMENTS IN THE FIELD WITH THE DISTRICT PRIOR TO CONSTRUCTION.
- 5. ALL BURIED WATER MAIN SHALL BE RESTRAINED JOINT (R.J.) PIPE WITH FIELD LOK GASKETS (OR APPROVED EQUAL) AND POLYETHYLENE ENCASEMENT PER NUD STANDARD SPECIFICATIONS.
- 6. LOCATION, MATERIAL, DIAMETER, AND DEPTH OF EXISTING WATER MAINS SHALL BE VERIFIED PRIOR TO CONNECTION.
- 7. POTHOLE ALL UTILITY CROSSINGS (WATER, SEWER, POWER, TELEPHONE, GAS, ETC.) PRIOR TO COMMENCING WATER MAIN INSTALLATION IN ORDER TO CONFIRM THE VERTICAL LOCATION AS SHOWN.
- 8. CONSTRUCT NEW WATER MAIN BELOW EXISTING WATER MAIN UNLESS OTHERWISE NOTED OR COORDINATED WITH NUD. A MINIMUM OF 1 FOOT OF VERTICAL CLEARANCE IS REQUIRED BETWEEN UTILITIES. THIS CAN BE REDUCED TO 6" WITH ETHAFOAM INSTALLED BETWEEN THE UTILITIES.
- 9. ALL SERVICE CONNECTIONS ARE ASSUMED TO HAVE A PRIVATE PRV DEVICE ON THE BACKSIDE OF THE METERE. UNLESS OTHERWISE NOTED, A REPLACEMENT PRV DEVICE SHALL BE INSTALLED AT THE TIME OF RECONNECTION. SEE SPECIFICATION FOR PRESSURE TESTING REQUIREMENTS. SEE SHEET 20 FOR STANDARD DETAIL.
- 10. WATER SERVICE INSTALLATION MAY BE COMPLETED BY EITHER OPEN TRENCH OR TRENCHLESS CONSTRUCTION. MEANS AND METHODS FOR WATER SERVICE INSTALLATION SHALL BE DETERMINED BY THE CONTRACTOR.
- 11. CONTRACTOR TO COORDINATE TRANSITION OF SERVICE TO NEW WATER MAIN WITH NORTHSHORE UTILITY DISTRICT IN ORDER TO RESTORE SERVICE WITH MINIMAL DISRUPTION.

CONSTRUCTION NOTES

- (1) CONTRACTOR SHALL POTHOLE AT EXISTING CROSSINGS TO VERIFY FEASIBILITY OF PROPOSED CONSTRUCTION, TYP.
- 2 INSTALL NEW 1" WATER SERVICE PER STANDARD DETAIL. CONNECT BACKSIDE OF METER TO EXISTING CUSTOMER SERVICE LINE. SEE STANDARD WATER DETAIL ON SHEET 20
- PROPOSED WATER MAIN SHALL BE LOCATED WITHIN EXISTING WATER MAIN ALIGNMENT ALONG NE 130TH STREET BETWEEN INTERSECTIONS OF 66TH PL NE AND PRIVATE DRIVE. EXISTING WATER MAIN SHALL BE REMOVED AND DISPOSED OF IN ACCORDANCE WITH DISTRICT SPECIFICATIONS.
- 4 CUT AND CAP.
- THE EXISTING WATER MAIN SHALL BE DEACTIVATED AND REMAIN SURPLUS FACILITIES OF THE DISTRICT. CLOSE ALL BRANCH VALVES AND LEAVE IN—LINE VALVES OPEN. REMOVE AND DISPOSE OF EXISTING VALVE BOXES. THE PIPE SHALL BE CAPPED WATER—TIGHT WITH FITTINGS IN ACCORDANCE WITH THE SPECIFICATIONS.
- (6) REPLACE SEWER MANHOLE PER DISTRICT SPECIFICATIONS.

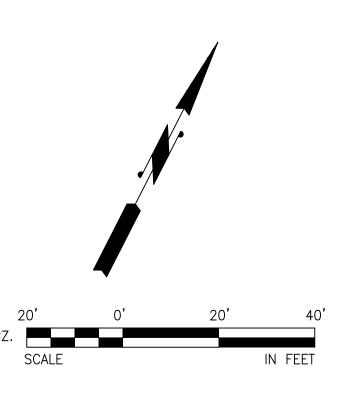



NO	BY	APPD	REVISION	DATE	WA
					0 VVA
					IF THIS
					NOT M THEN
			BID SET DRAWING - NOT FOR CONSTRUCTION		IS NOT

WARNING

O ½ 1

An Engineering Service
11255 Kirkland Way,
Kirkland, WA 98033
p. 425.827.2014 | f.

THEN DRAWING
IS NOT TO SCALE

PACE JOB #

DESIGNED
BY

DRAWN
BY

11255 Kirkland Way, Suite 300
Kirkland, WA 98033
p. 425.827.2014 | f. 425.827.5043

Civil | Structural | Planning | Survey paceengrs.com


PACE JOB # 21061.00

DESIGNED
BY

CHECKED
BY

APPROVAL

APPROVAL

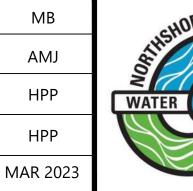



NORTHSHORE UTILITY DISTRICT

6830 NE 185th St. Kenmore, WA 98028-2684 P.O. Box 82489 Kenmore, WA 98028-2684

Ph: (425) 398-4400 | **Fax:** (425) 398-4430 | **www.nud.net**

CONTRACT 2023-02
WOODLAND COVE WATER SERVICE REPLACEMENT

SCHEDULE B PLAN 3


BASE MAP L7

SHEET

<u>18</u> of <u>24</u>

C1817

NW 1/4, SEC 26, T26N, R4E & NW 1/4, SEC 25, T26N, R4E

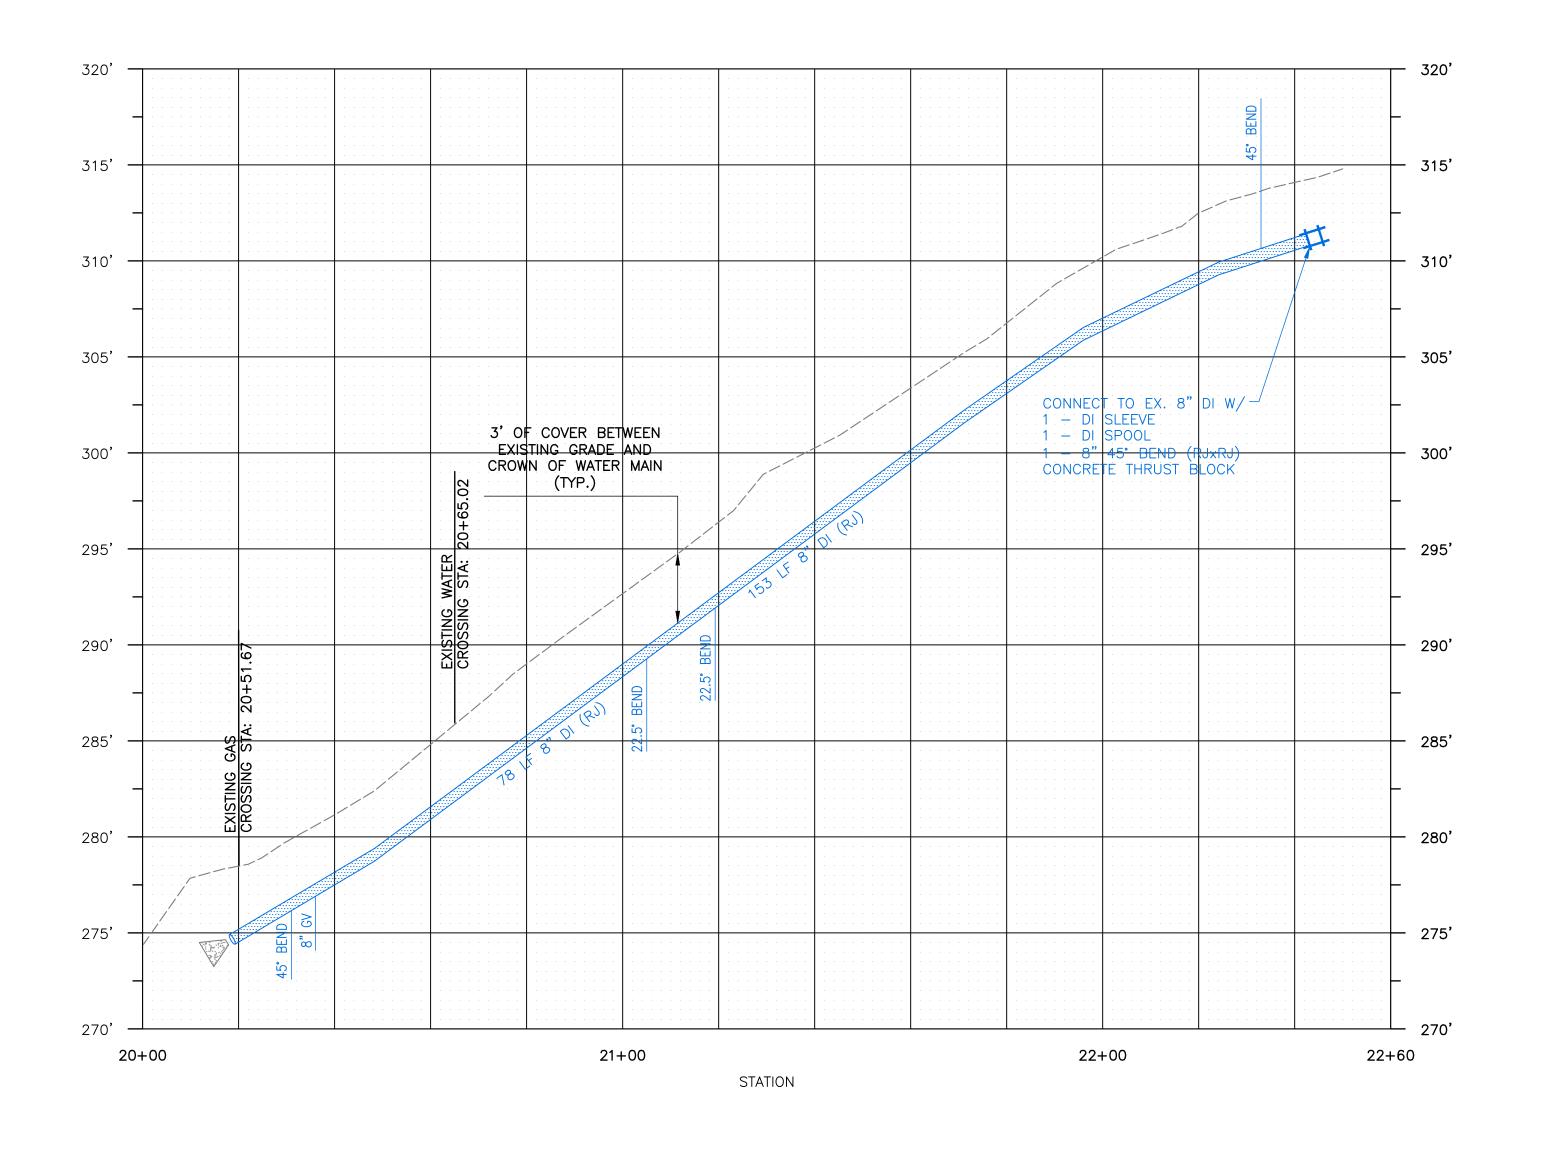

GENERAL NOTES

1. SEE SHEET 2 FOR GENERAL NOTES, LEGEND, AND SURVEY CONTROL INFORMATION.

- 2. PRIOR TO EXCAVATION, INSTALL TESC FACILITIES PER SHEET 2.
- 3. PRIOR TO STARTING NEW WATER MAIN CONSTRUCTION, CONTRACTOR TO SUBMIT TEMPORARY SERVICE PLAN FOR DISTRICT REVIEW AND APPROVAL. ONCE APPROVED, THE CONTRACTOR SHALL INSTALL THE TEMPORARY WATER SERVICE PIPING AND CONNECT TO THE EXISTING WATER METERS IN ORDER TO KEEP PROPERTIES IN SERVICE DURING CONSTRUCTION.
- 4. COORDINATE AND CONFIRM FITTING REQUIREMENTS IN THE FIELD WITH THE DISTRICT PRIOR TO CONSTRUCTION.
- 5. ALL BURIED WATER MAIN SHALL BE RESTRAINED JOINT (R.J.) PIPE WITH FIELD LOK GASKETS (OR APPROVED EQUAL) AND POLYETHYLENE ENCASEMENT PER NUD STANDARD SPECIFICATIONS.
- 6. LOCATION, MATERIAL, DIAMETER, AND DEPTH OF EXISTING WATER MAINS SHALL BE VERIFIED PRIOR TO CONNECTION.
- 7. POTHOLE ALL UTILITY CROSSINGS (WATER, SEWER, POWER, TELEPHONE, GAS, ETC.) PRIOR TO COMMENCING WATER MAIN INSTALLATION IN ORDER TO CONFIRM THE VERTICAL LOCATION AS SHOWN.
- 8. CONSTRUCT NEW WATER MAIN BELOW EXISTING WATER MAIN UNLESS OTHERWISE NOTED OR COORDINATED WITH NUD. A MINIMUM OF 1 FOOT OF VERTICAL CLEARANCE IS REQUIRED BETWEEN UTILITIES. THIS CAN BE REDUCED TO 6" WITH ETHAFOAM INSTALLED BETWEEN THE UTILITIES.
- 9. ALL SERVICE CONNECTIONS ARE ASSUMED TO HAVE A PRIVATE PRV DEVICE ON THE BACKSIDE OF THE METERE. UNLESS OTHERWISE NOTED, A REPLACEMENT PRV DEVICE SHALL BE INSTALLED AT THE TIME OF RECONNECTION. SEE SPECIFICATION FOR PRESSURE TESTING REQUIREMENTS. SEE SHEET 20 FOR STANDARD DETAIL.
- 10. WATER SERVICE INSTALLATION MAY BE COMPLETED BY EITHER OPEN TRENCH OR TRENCHLESS CONSTRUCTION. MEANS AND METHODS FOR WATER SERVICE INSTALLATION SHALL BE DETERMINED BY THE CONTRACTOR.
- 11. CONTRACTOR TO COORDINATE TRANSITION OF SERVICE TO NEW WATER MAIN WITH NORTHSHORE UTILITY DISTRICT IN ORDER TO RESTORE SERVICE WITH MINIMAL DISRUPTION.

CONSTRUCTION NOTES

- (1) CATCH BASIN AND INLET SEDIMENTATION PROTECTION REQUIRED, SEE SHEET 2 FOR ADDITIONAL INFORMATION.
- 2) INSTALL NEW 1" WATER SERVICE PER STANDARD DETAIL. CONNECT BACKSIDE OF METER TO EXISTING CUSTOMER SERVICE LINE. SEE STANDARD WATER DETAIL ON
- (3) PROPOSED WATER MAIN SHALL BE LOCATED WITHIN EXISTING WATER MAIN ALIGNMENT ALONG NE 130TH STREET BETWEEN INTERSECTIONS OF 66TH PL NE AND PRIVATE DRIVE. EXISTING WATER MAIN SHALL BE REMOVED AND DISPOSED OF IN ACCORDANCE WITH DISTRICT SPECIFICATIONS.
- (4) CLOSE EXISTING FIRE HYDRANT VALVE, REMOVE VALVE CAN, AND BACKFILL PER SPECIFICATIONS. REMOVE AND SALVAGE EXISTING FH AND DELIVER TO THE DISTRICT YARD IN KENMORE IN A CLEAN AND OPERABLE CONDITION. REMOVE PROTECTIVE BOLLARDS WHERE NECESSARY. INSTALL NEW FH ASSEMBLY PER THE STANDARD
- 5 THE EXISTING WATER MAIN SHALL BE DEACTIVATED AND REMAIN SURPLUS FACILITIES OF THE DISTRICT. CLOSE ALL BRANCH VALVES AND LEAVE IN-LINE VALVES OPEN. REMOVE AND DISPOSE OF EXISTING VALVE BOXES. THE PIPE SHALL BE CAPPED WATER-TIGHT WITH FITTINGS IN ACCORDANCE WITH THE SPECIFICATIONS.
- (6) REPLACE SEWER MANHOLE PER DISTRICT SPECIFICATIONS.

	20'	0'	20'	40'
HORZ.				
	SCALE			IN FEET
	5'	0'	5'	10'
VERT.				
	SCALE			IN FEET

CONTRACT 2023-02 WOODLAND COVE WATER SERVICE REPLACEMENT

SCHEDULE B PROFILE 3

BASE MAP L7 C1817

SHEET

<u>19</u> of <u>24</u>

NO	BY	APPD	REVISION	DATE	WA
					0 VVA
					IF THIS
					NOT M
			BID SET DRAWING - NOT FOR CONSTRUCTION		IS NOT








NORTHSHORE UTILITY DISTRICT 6830 NE 185th St. P.O. Box 82489 Kenmore, WA 98028-2684 Kenmore, WA 98028-2684

Ph: (425) 398-4400 | **Fax:** (425) 398-4430 | **www.nud.net**

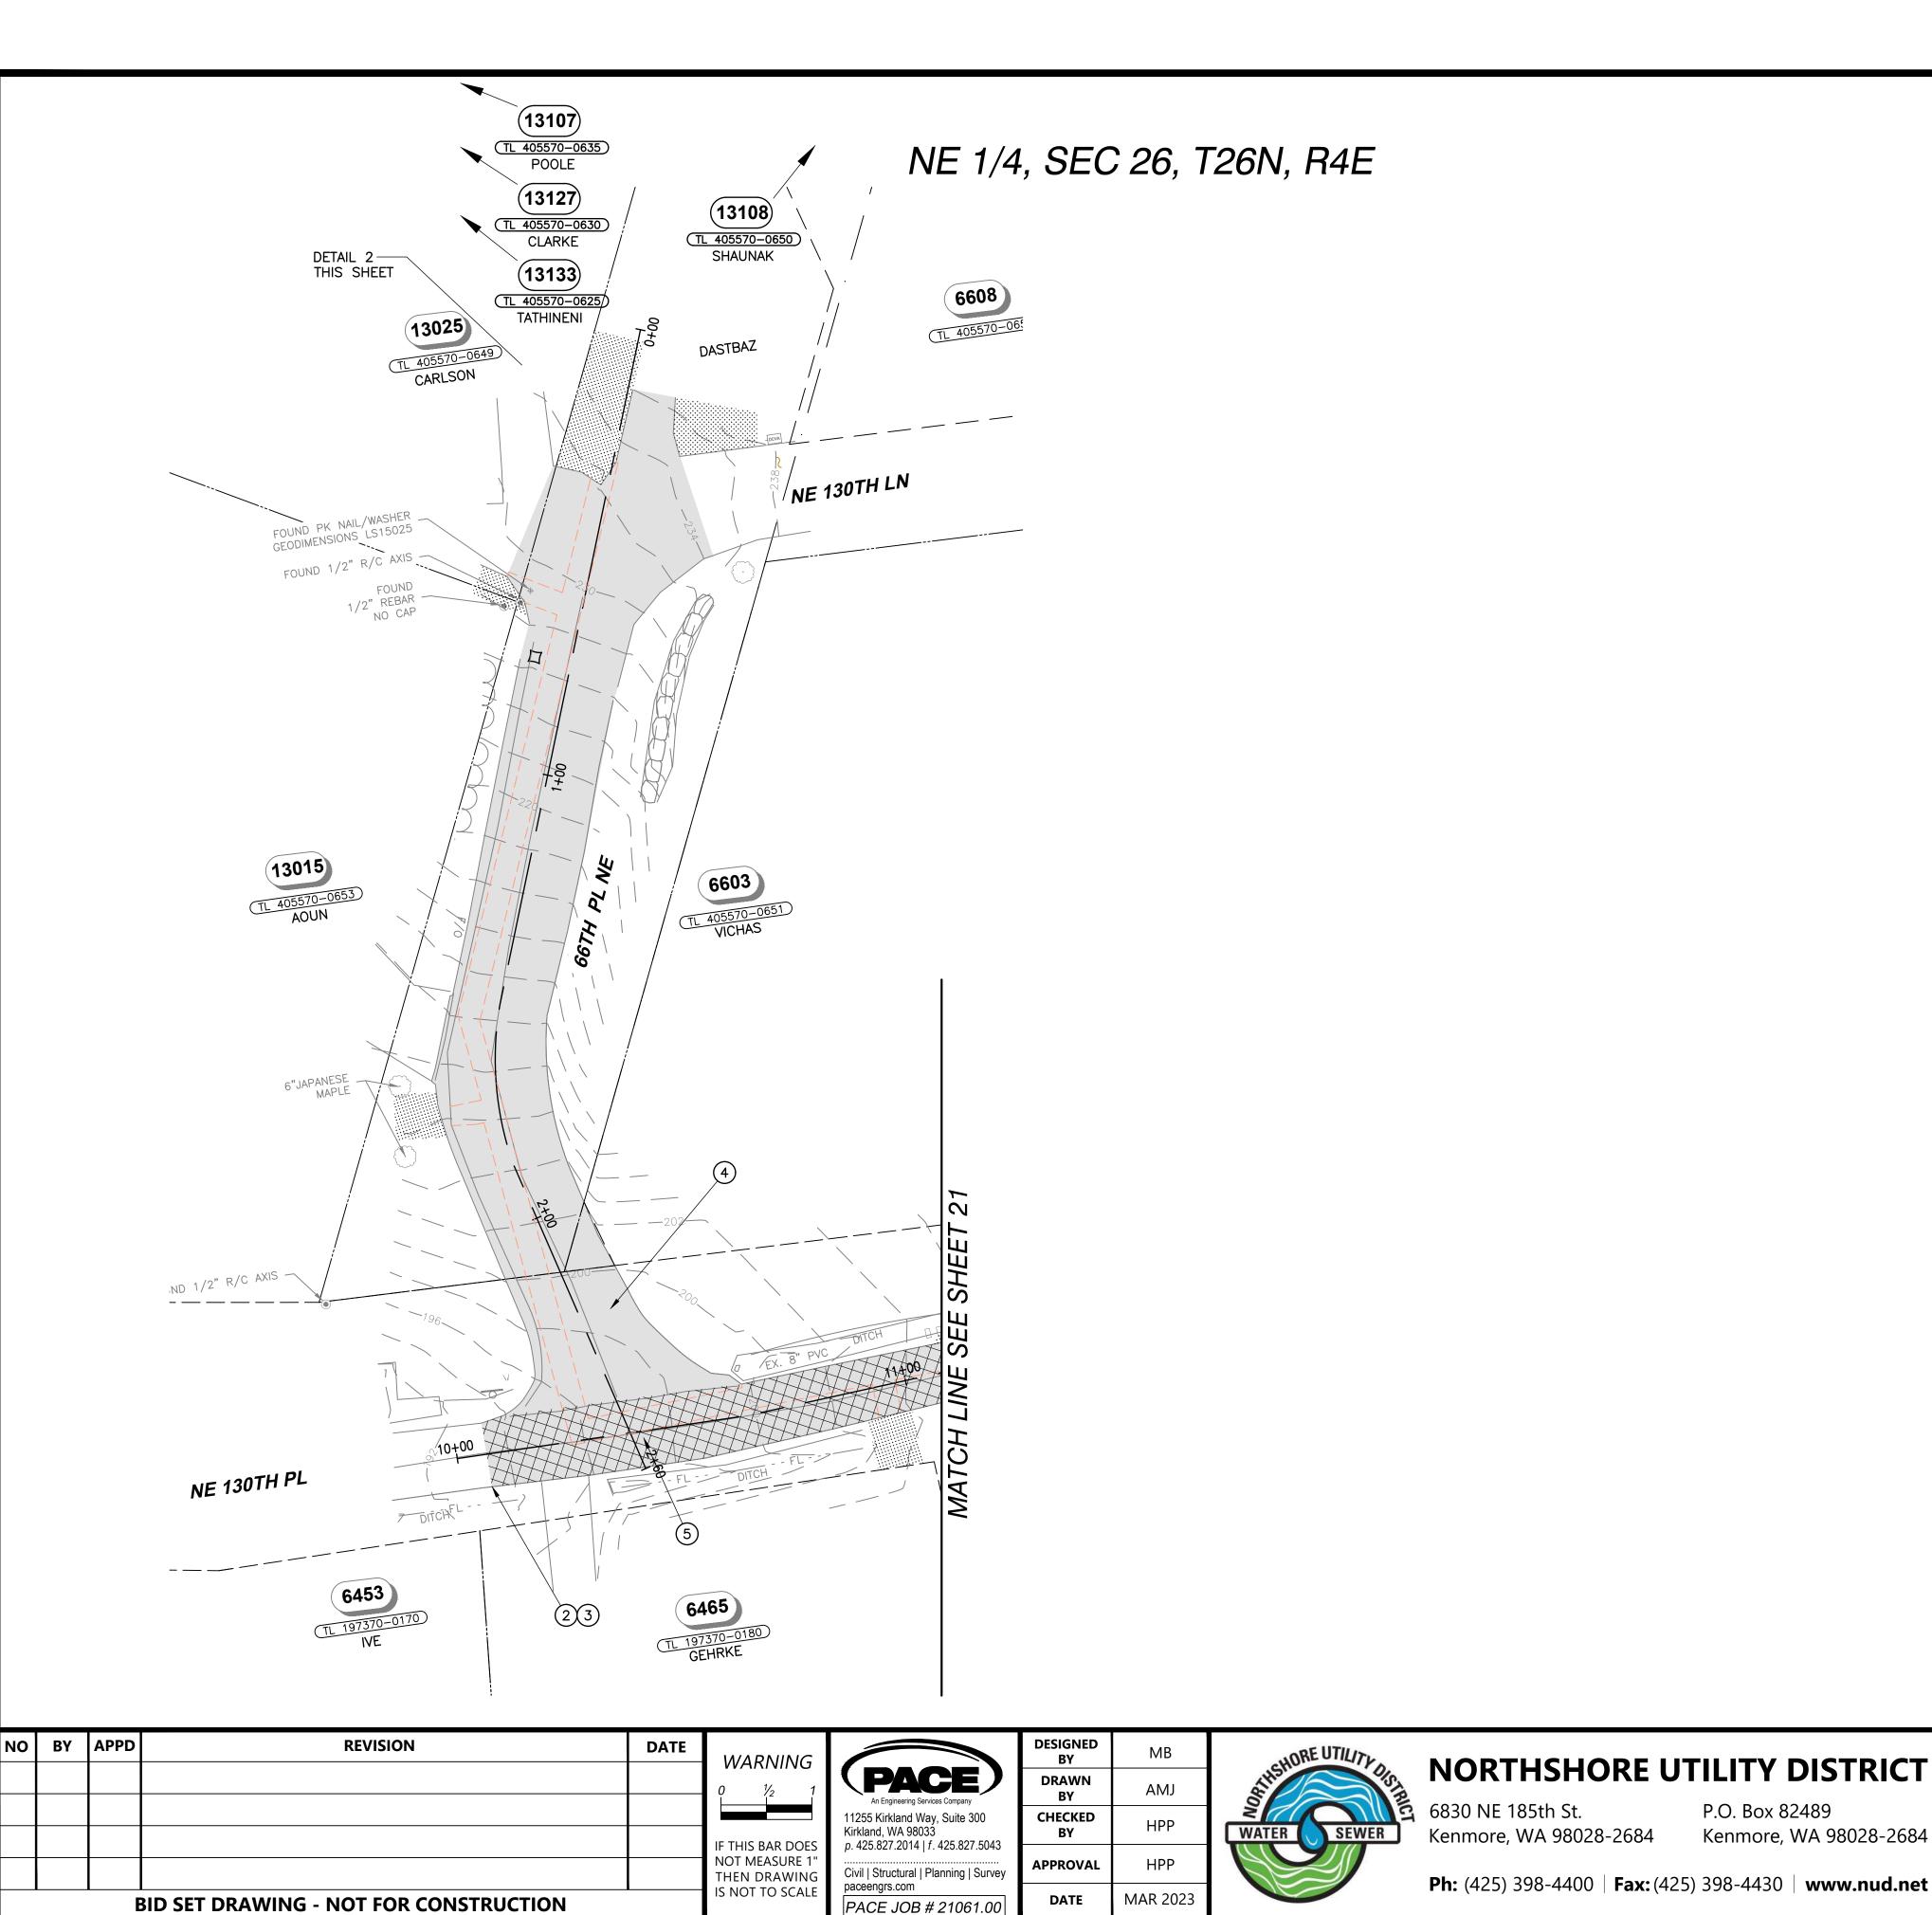

GENERAL NOTES

1. SEE SPECIFICATIONS FOR WORK AND PAYMENT INCLUDED IN GENERAL RESTORATION.

- 2. GRASS AREAS THAT ARE DAMAGED BY THE CONTRACTOR SHALL BE RESTORED WITH 4" OF TOPSOIL AND SOD PER THE SPECIFICATIONS.
- 3. NOT ALL RESTORATION REQUIREMENTS MAY BE SHOWN. THE CONTRACTOR SHALL RESTORE ALL EXISTING IMPROVEMENTS DAMAGED BY CONSTRUCTION ACTIVITIES TO A CONDITION THAT IS EQUAL TO OR BETTER THAN THAT WHICH EXISTED PRIOR TO CONSTRUCTION, WHETHER OR NOT THE EXISTING IMPROVEMENTS AND RESTORATION REQUIREMENTS ARE SHOWN ON THE PLANS.
- 4. PROVIDE A T-CUT AFTER TRENCH EXCAVATION, BACKFILL, AND COMPACTION.

LEGEND




ROADWAY SAWCUT AND TRENCH PATCH (APPROXIMATE LIMITS)


2" HOT MIX ASPHALT CLASS 1/2" BUTT GRIND AND OVERLAY

LANDSCAPE RESTORATION TO MATCH EXISTING CONDITIONS FULL ROADWAY RECONSTRUCTION - MATCH EX. HMA THICKNESS PLUS 1" (MAX. 6") OVER MIN. 6" CRUSHED ROCK

RESTORATION NOTES

- (1) ADJUST ALL UTILITY CASTINGS TO FINISHED GRADE
- 2 SAWCUT OR GRIND. SEAL WITH AR4000W (TYP.)
- (3) THOROUGHLY TACK ALL EDGES (TYP.)
- (4) BUTT GRIND AND OVERLAY
- (5) FULL ROADWAY RECONSTRUCTION

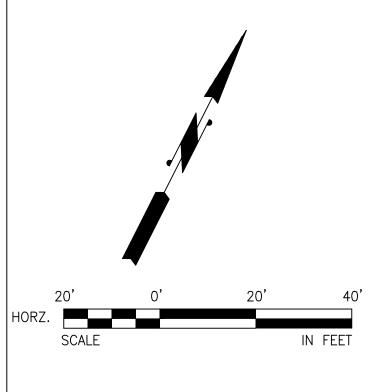

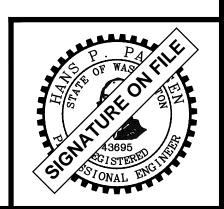

CONTRACT 2023-02 WOODLAND COVE WATER SERVICE REPLACEMENT

P.O. Box 82489

Kenmore, WA 98028-2684


SCHEDULE B RESTORATION PLAN 1

BASE MAP L7 C1817

SHEET

<u>20</u> of <u>24</u>

NE 1/4, SEC 26, T26N, R4E AND NW 1/4 SEC 25, T26N, R4E

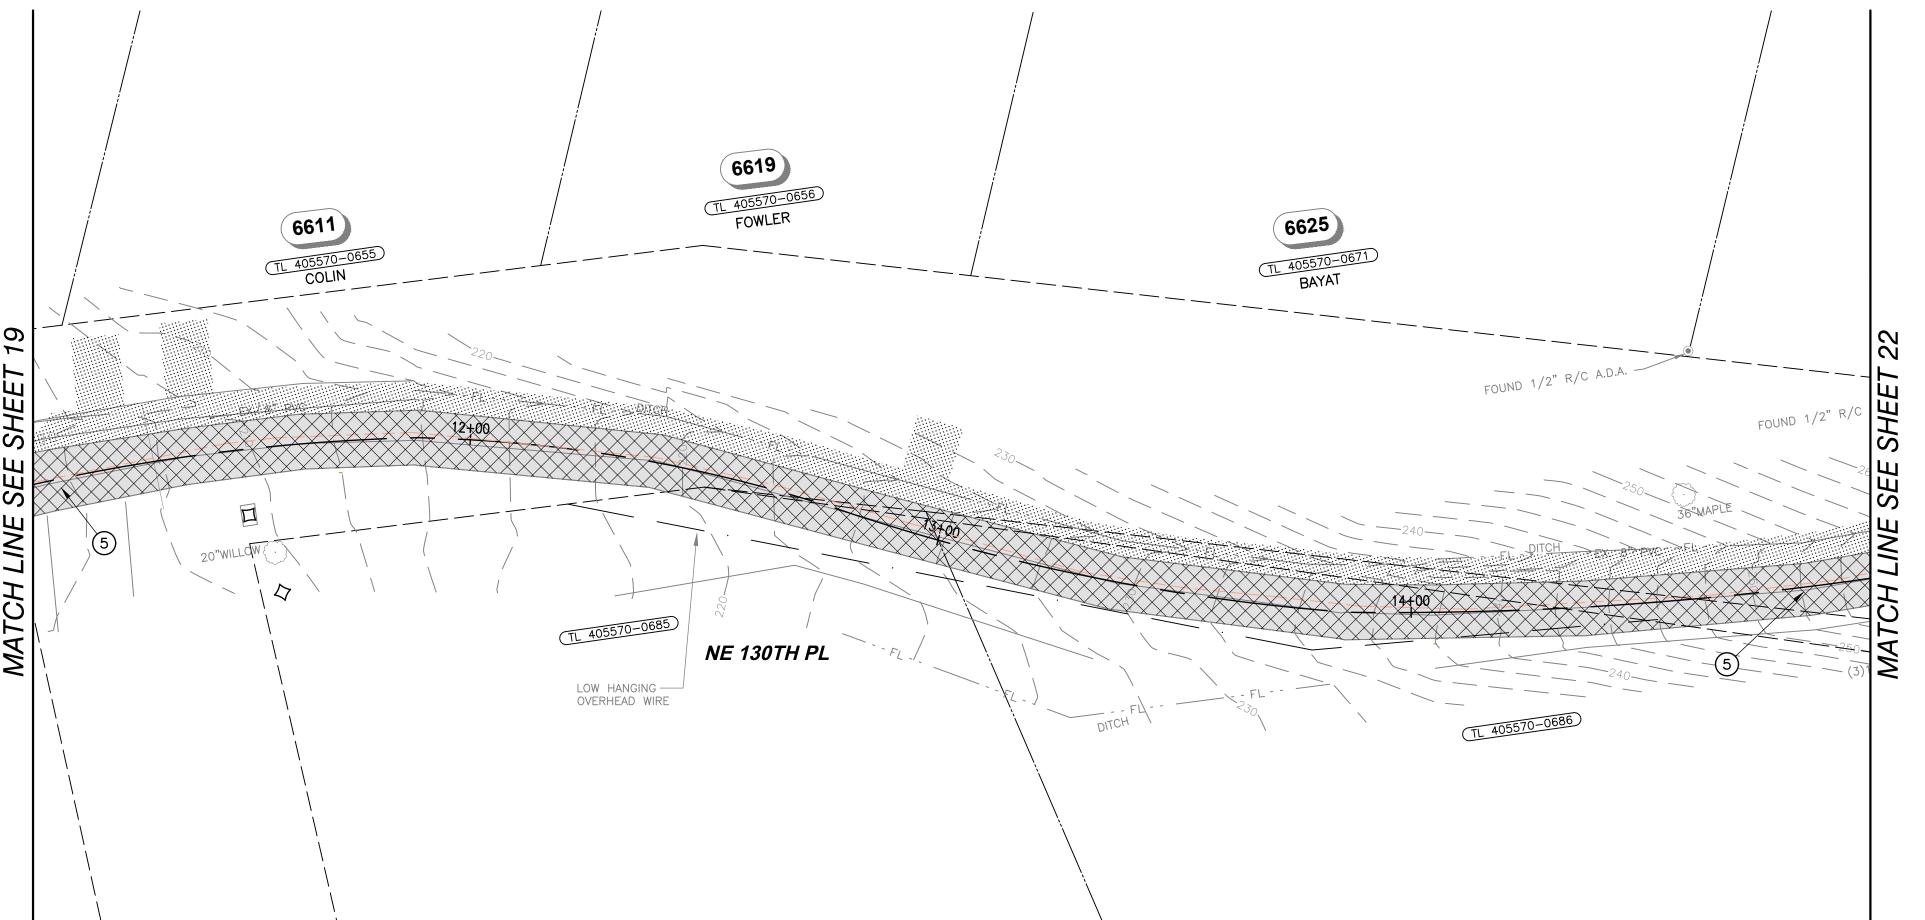

GENERAL NOTES

1. SEE SPECIFICATIONS FOR WORK AND PAYMENT INCLUDED IN GENERAL RESTORATION.

- 2. GRASS AREAS THAT ARE DAMAGED BY THE CONTRACTOR SHALL BE RESTORED WITH 4" OF TOPSOIL AND SOD PER THE SPECIFICATIONS.
- 3. NOT ALL RESTORATION REQUIREMENTS MAY BE SHOWN. THE CONTRACTOR SHALL RESTORE ALL EXISTING IMPROVEMENTS DAMAGED BY CONSTRUCTION ACTIVITIES TO A CONDITION THAT IS EQUAL TO OR BETTER THAN THAT WHICH EXISTED PRIOR TO CONSTRUCTION, WHETHER OR NOT THE EXISTING IMPROVEMENTS AND RESTORATION REQUIREMENTS ARE SHOWN ON THE PLANS.
- 4. PROVIDE A T-CUT AFTER TRENCH EXCAVATION, BACKFILL, AND COMPACTION.

LEGEND



ROADWAY SAWCUT AND TRENCH PATCH (APPROXIMATE LIMITS)


2" HOT MIX ASPHALT CLASS 1/2" BUTT GRIND AND OVERLAY


LANDSCAPE RESTORATION TO MATCH EXISTING CONDITIONS

FULL ROADWAY RECONSTRUCTION — MATCH EX. HMA THICKNESS PLUS 1" (MAX. 6") OVER MIN. 6" CRUSHED ROCK

RESTORATION NOTES

- 1) ADJUST ALL UTILITY CASTINGS TO FINISHED GRADE
- 2 SAWCUT OR GRIND. SEAL WITH AR4000W (TYP.)
- 3 THOROUGHLY TACK ALL EDGES (TYP.)
- (4) BUTT GRIND AND OVERLAY
- 5 FULL ROADWAY RECONSTRUCTION

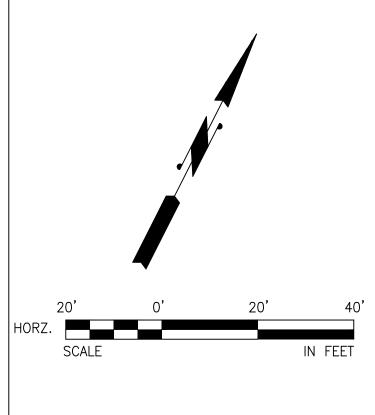

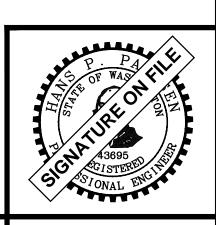

E

NORTHSHORE UTILITY DISTRICT

6830 NE 185th St. P.O. Box 82489 Kenmore, WA 98028-2684 Kenmore, WA 98028-2684

Ph: (425) 398-4400 | **Fax:** (425) 398-4430 | **www.nud.net**

CONTRACT 2023-02
WOODLAND COVE WATER SERVICE REPLACEMENT

SCHEDULE B RESTORATION PLAN 2

BASE MAP L7 C1817

SHEET

21 OF 24

NO	BY	APPD	REVISION	DATE	W
					VV
					IF T
					NO THI
		E	BID SET DRAWING - NOT FOR CONSTRUCTION	1	IS N

An Engineering Services Company
11255 Kirkland Way, Suite 300
Kirkland, WA 98033
p. 425.827.2014 | f. 425.827.5043


Civil | Structural | Planning | Survey paceengrs.com

DRAWN

CHECKED

MAR 2023

NW 1/4, SEC 26, T26N, R4E & NW 1/4, SEC 25, T26N, R4E NE 1/4, SEC 26, T26N, R4E

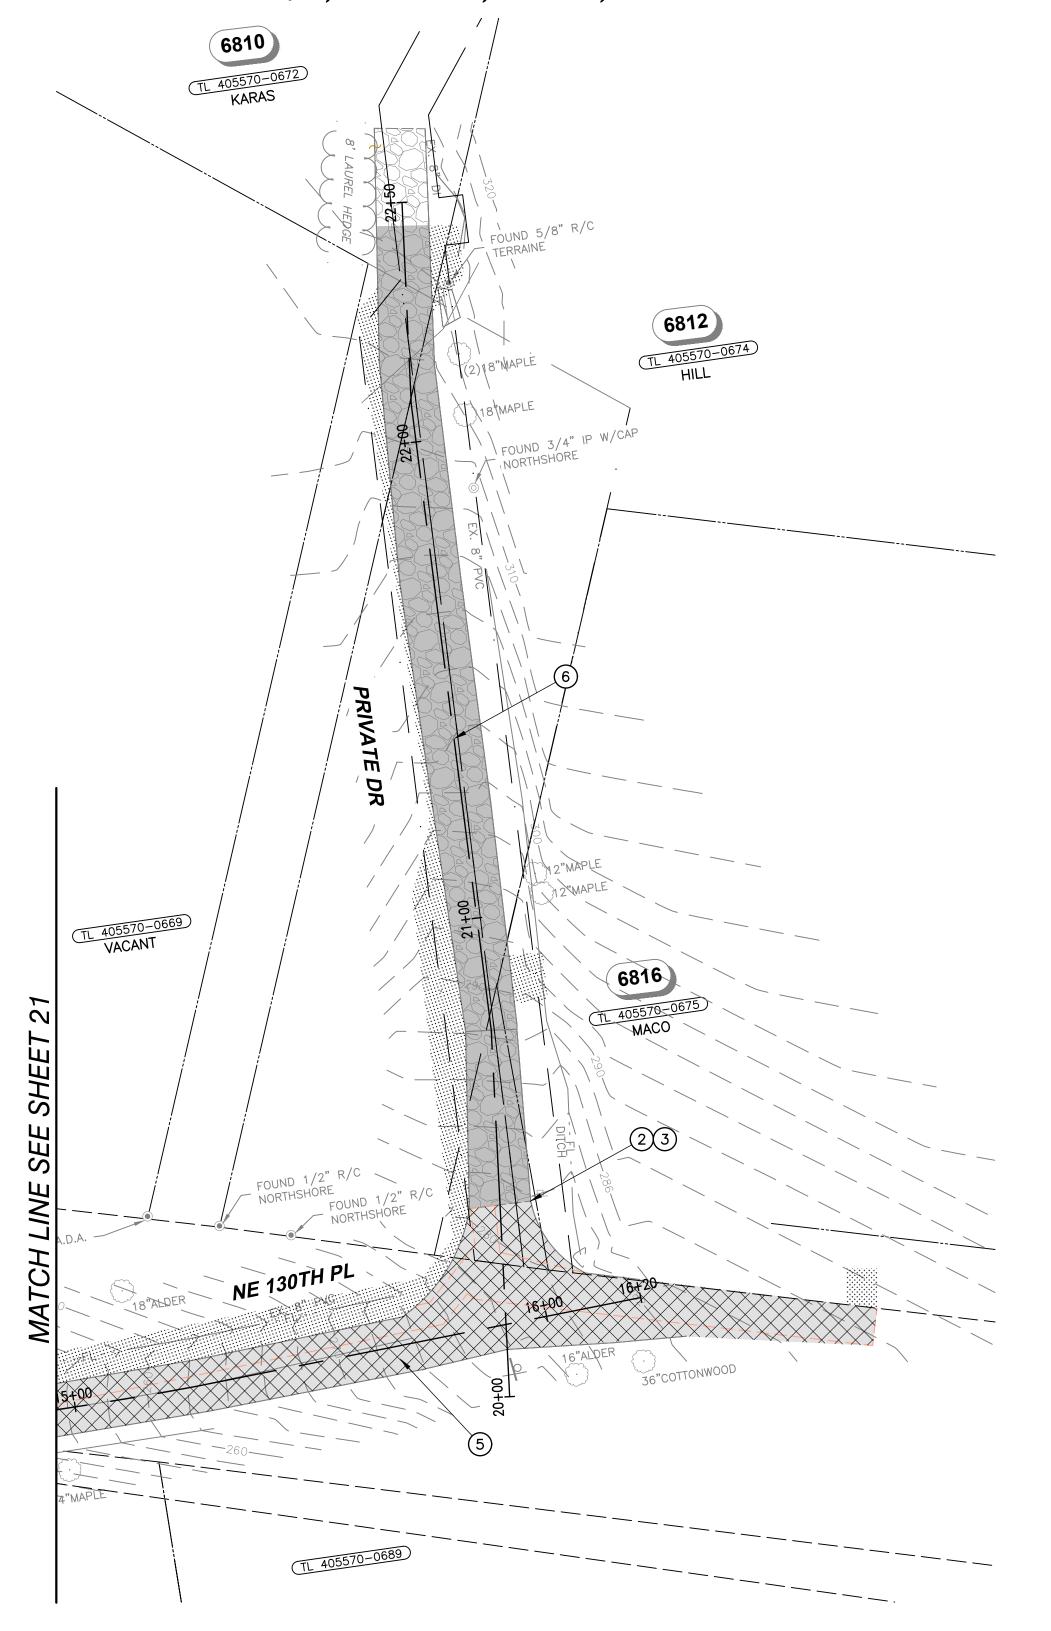

GENERAL NOTES

1. SEE SPECIFICATIONS FOR WORK AND PAYMENT INCLUDED IN GENERAL RESTORATION.

- 2. GRASS AREAS THAT ARE DAMAGED BY THE CONTRACTOR SHALL BE RESTORED WITH 4" OF TOPSOIL AND SOD PER THE SPECIFICATIONS.
- 3. NOT ALL RESTORATION REQUIREMENTS MAY BE SHOWN. THE CONTRACTOR SHALL RESTORE ALL EXISTING IMPROVEMENTS DAMAGED BY CONSTRUCTION ACTIVITIES TO A CONDITION THAT IS EQUAL TO OR BETTER THAN THAT WHICH EXISTED PRIOR TO CONSTRUCTION, WHETHER OR NOT THE EXISTING IMPROVEMENTS AND RESTORATION REQUIREMENTS ARE SHOWN ON THE PLANS.
- 4. PROVIDE A T-CUT AFTER TRENCH EXCAVATION, BACKFILL, AND COMPACTION.

LEGEND

ROADWAY SAWCUT AND TRENCH PATCH (APPROXIMATE LIMITS)

LANDSCAPE RESTORATION TO MATCH EXISTING


2" HOT MIX ASPHALT CLASS 1/2" BUTT GRIND AND OVERLAY

FULL ROADWAY RECONSTRUCTION — MATCH EX. HMA THICKNESS PLUS 1" (MAX. 6") OVER MIN. 6" CRUSHED ROCK

GRAVEL ROADWAY RESTORATION (APPROXIMATE LIMITS) - MIN. 4" COMPACTED CSTC

RESTORATION NOTES

- (1) ADJUST ALL UTILITY CASTINGS TO FINISHED GRADE
- 2 SAWCUT OR GRIND. SEAL WITH AR4000W (TYP.)
- (3) THOROUGHLY TACK ALL EDGES (TYP.)
- (4) BUTT GRIND AND OVERLAY
- (5) FULL ROADWAY RECONSTRUCTION
- 6 GRAVEL ROADWAY RESTORATION

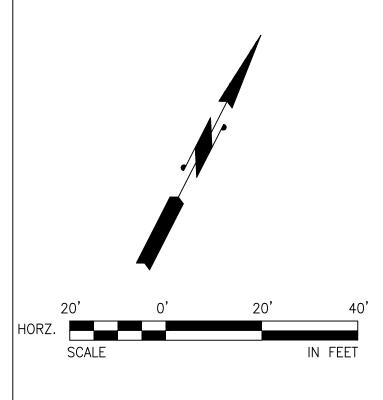



NO	BY	APPD	REVISION	DATE	WA
					0
					IF THIS
					NOT N
		E	BID SET DRAWING - NOT FOR CONSTRUCTION	•	IS NO

IIS BAR DOES MEASURE 1" N DRAWING DT TO SCALE p. 425.827.2014 | f. 425.827.5043 Civil | Structural | Planning | Survey DESIGNED BY DRAWN CHECKED DATE MAR 2023



NORTHSHORE UTILITY DISTRICT

6830 NE 185th St. Kenmore, WA 98028-2684 P.O. Box 82489 Kenmore, WA 98028-2684

Ph: (425) 398-4400 | **Fax:** (425) 398-4430 | **www.nud.net**


CONTRACT 2023-02 WOODLAND COVE WATER SERVICE REPLACEMENT

SCHEDULE B RESTORATION PLAN 3

BASE MAP L7 C1817

SHEET

22 OF 24

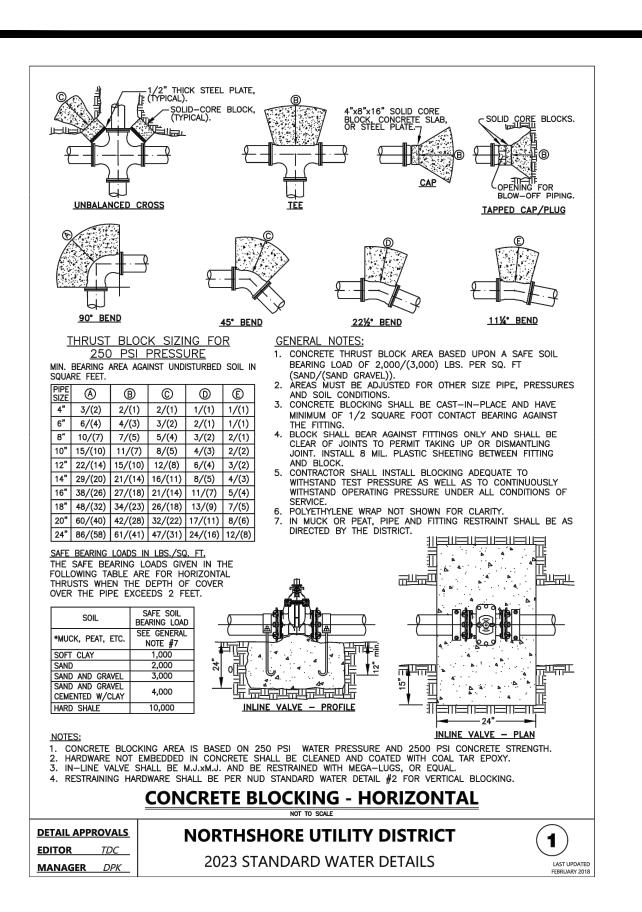

REMOVE & REPLACE SIDEWALK PANEL

LOCATE AND CONNECT TO EXISTING WATER SERVICE LINE. PROVIDE ALL BRASS INSTA-TITE OR COMPRESSION PACK JOINT STYLE FITTINGS. CONFIRM FITTINGS REQUIRED PRIOR TO DISRUPTING EXISTING WATER SERVICE AND COMMENCING RECONNECTION CONSTRUCTION. SEE NOTE 4.

5. MEASURE AND RECORD EXISTING WATER PRESSURE AT BUILDING PRIOR TO RECONNECTION AND AFTER REESTABLISHMENT OF SERVICE. IF PRESSURE READINGS DIFFER BY MORE THAN 5 PSI, THE CONTRACTOR SHALL LOCATE AND CORRECT THE ISSUE AT THE PRIVATE PRV. IF A PRIVATE PRV IS REMOVED DURING NEW SERVICE INSTALLATION,

ALL PIPE FITTINGS SHALL BE BRASS. PRIOR TO MAKING THE CONNECTION, THE CONTRACTOR SHALL POTHOLE THE EXISTING SERVICE LINE TO DETERMINE THE LOCATION, SIZE, AND TYPE OF EXISTING PIPE AND TO CONFIRM THE PIPE AND FITTINGS REQUIRED TO MAKE THE CONNECTION. THE CONTRACTOR SHALL PROVIDE ALL REQUIRED PIPE AND

7. COORDINATE WITH THE DISTRICT TO SALVAGE THE EXISTING METER AND FOR INSTALLATION OF THE METER INTO THE NEW SERVICE SETTER, LOCATE AND RECONNECT THE EXISTING SERVICE LINE ON THE BACK OF THE METER, ALL PIGTAIL AND PRIVATE WATER SERVICE CONNECTIONS SHALL BE TESTED AT LINE PRESSURE AND SHALL BE VISUALLY INSPECTED BY THE DISTRICT.

EXISTING WATER SERVICE RE-CONNECTION

NORTHSHORE UTILITY DISTRICT

2023 STANDARD WATER DETAILS

9. RESTORE THE SITE TO A CONDITION EQUAL TO OR BETTER THAN EXISTED PRIOR TO CONSTRUCTION.

WATER SERVICE PER NUD STANDARD WATER DETAILS, #4 OR #5.
 NEW METER TO BE RELOCATED TO LOCATION SHOWN ON PLANS.

SERVICE SHALL BE DISRUPTED FOR MORE THAN TWO HOURS IN ONE DAY.

5. ALL PEXa PIPE TO PACK JOINT CONNECTIONS REQUIRE A STIFFENER INSERT.

6. FLUSH ALL NEW WATER SERVICE PIPING IN THE PRESENCE OF THE DISTRICT.

8. REMOVE AND REPLACE EXISTING METER BOX AND SETTER.

DETAIL APPROVALS

MANAGER SJD


EDITOR TMC


--- NEW METER BOX


AS CALLED OUT IN PLANS


(IF APPLICABLE)


REPLACE CURB AND GUTTER (IF APPLICABLE)

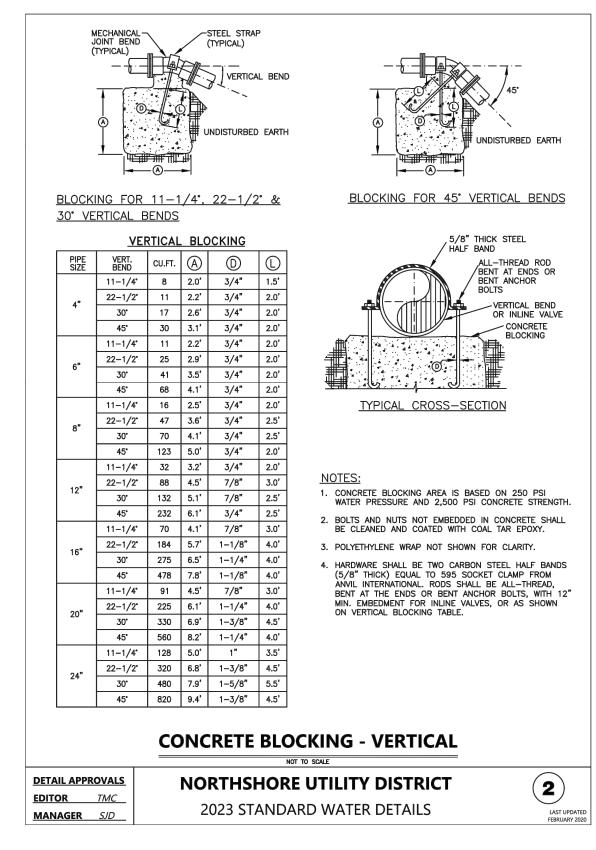


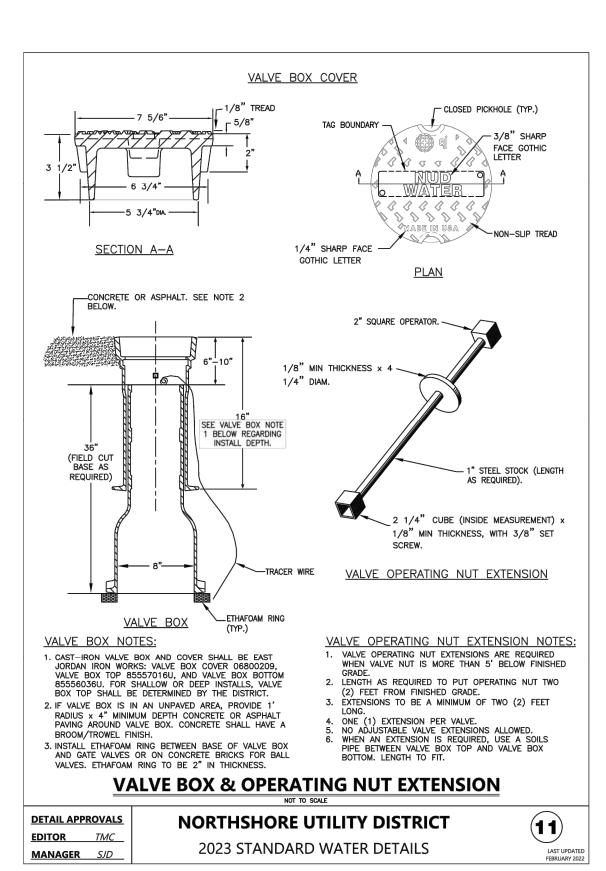

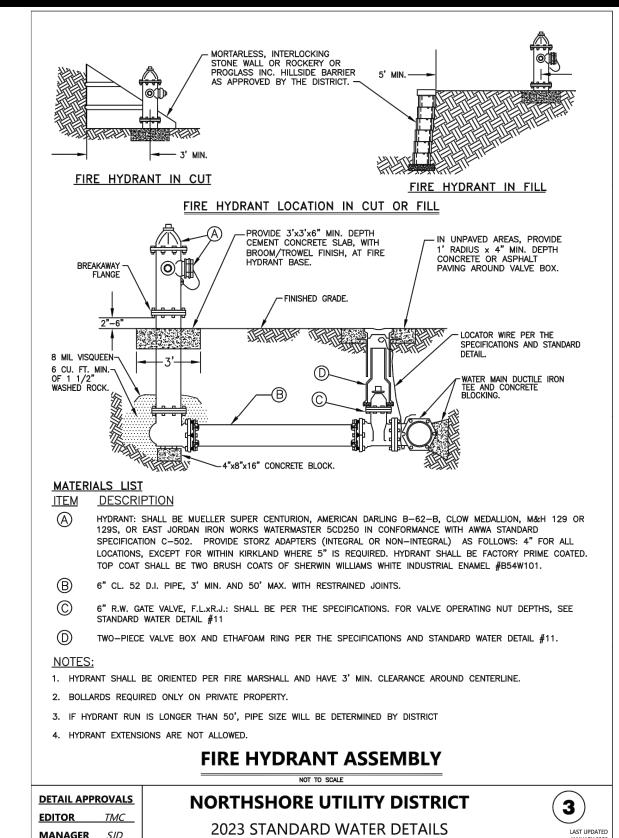

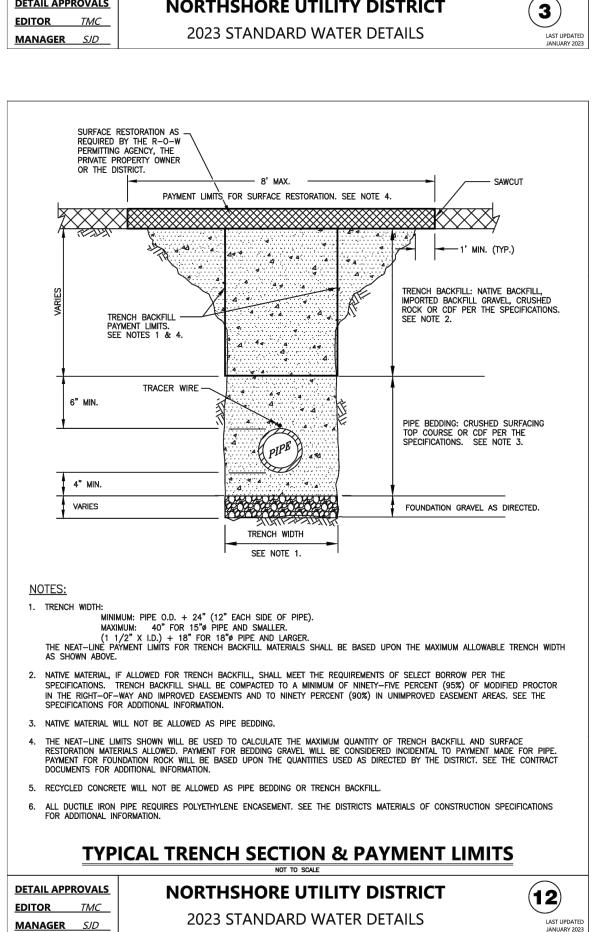

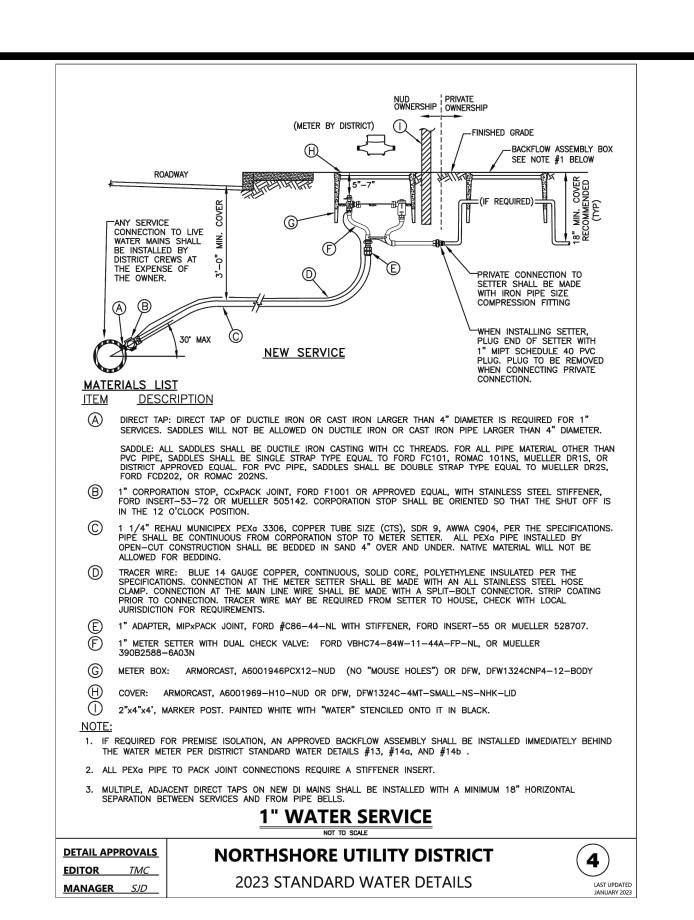

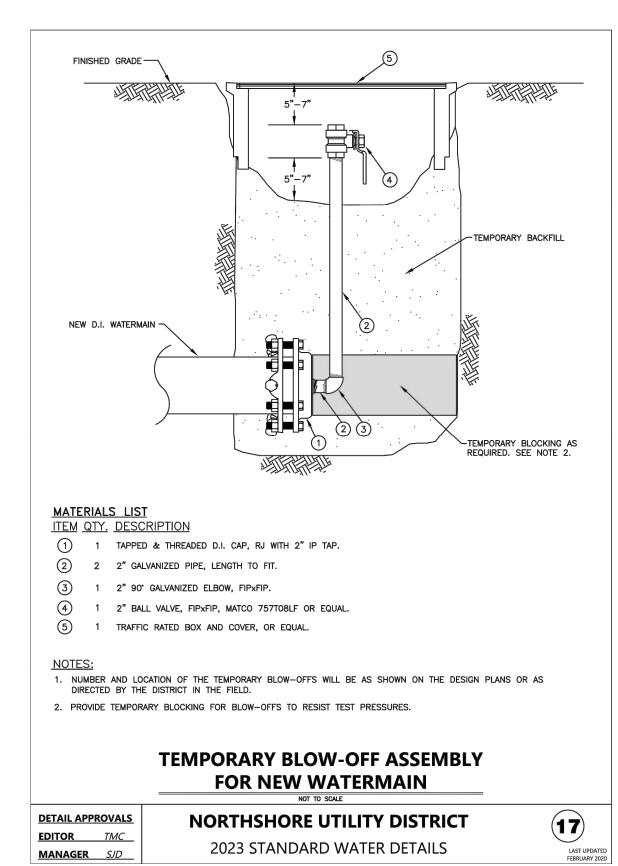



NO	BY	APPD	REVISION	DATE	14/
					<i>W.</i>
					IF TH
					NOT

BID SET DRAWING - NOT FOR CONSTRUCTION

WARNING

0 ½ 1

An Engineering Services Co
11255 Kirkland Way, St
Kirkland, WA 98033

p. 425.827.2014 | f. 42:

THEN DRAWING
IS NOT TO SCALE

PAGE 17

Civil | Structural | Plann
paceengrs.com

DESIGNED
BY

MB

DRAWN
BY

AMJ

AMJ

11255 Kirkland Way, Suite 300
Kirkland, WA 98033
p. 425.827.2014 | f. 425.827.5043

Civil | Structural | Planning | Survey paceengrs.com

PACE JOB # 21061.00

DATE

MB

AMJ


CHECKED
BY

HPP

APPROVAL

HPP

MAR 2023

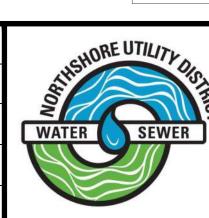

NORTHSHORE UTILITY DISTRICT


6830 NE 185th St. P.O. Box 82489 Kenmore, WA 98028-2684 Kenmore, WA 98028-2684


Ph: (425) 398-4400 | **Fax:** (425) 398-4430 | **www.nud.net**

CONTRACT 2023-02
WOODLAND COVE WATER SERVICE REPLACEMENT

DETAILS

BASE MAP L7
C1817
SHEET
23 OF 24

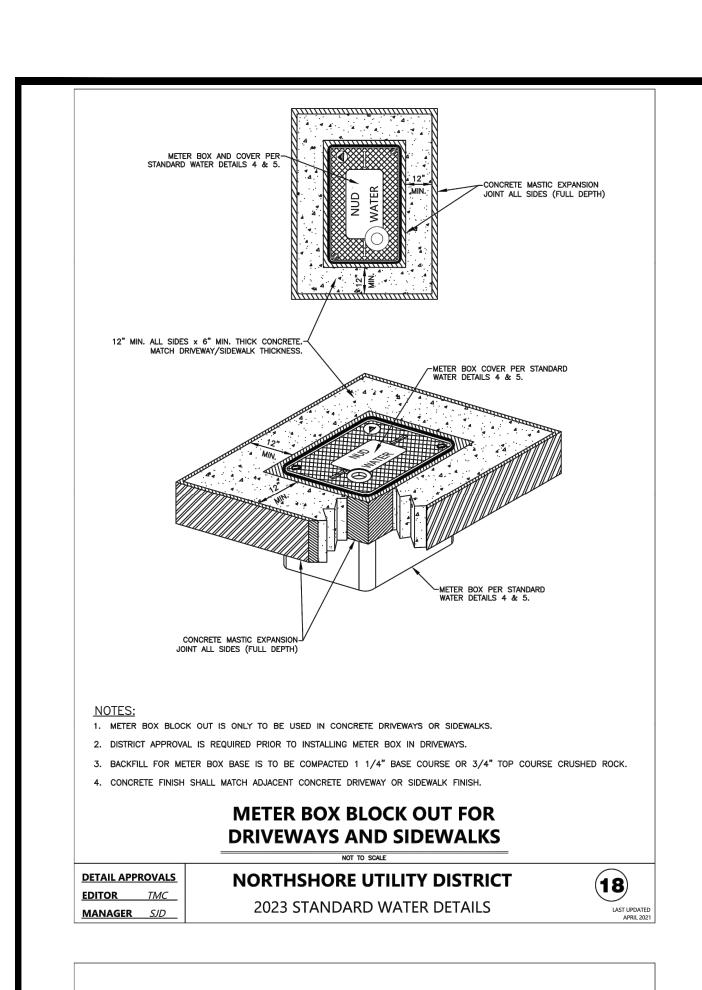


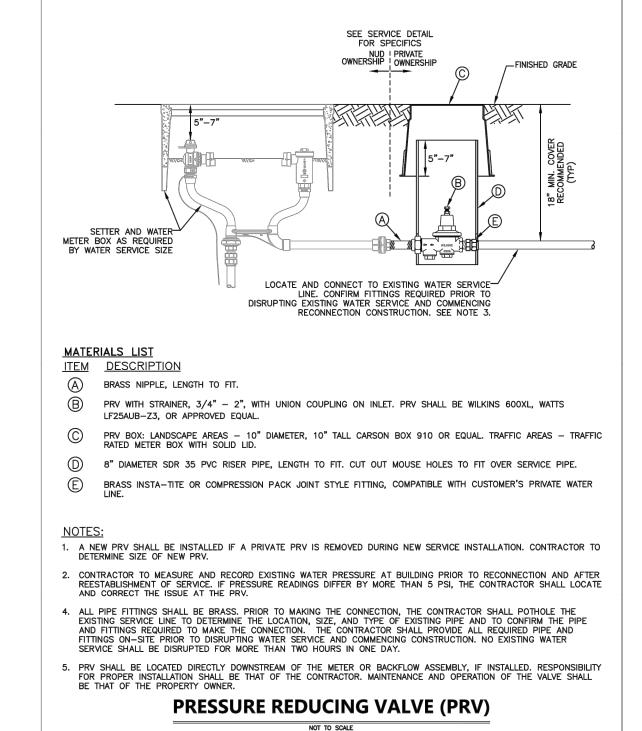



DETAIL APPROVALS

EDITOR TMC

MANAGER SJD

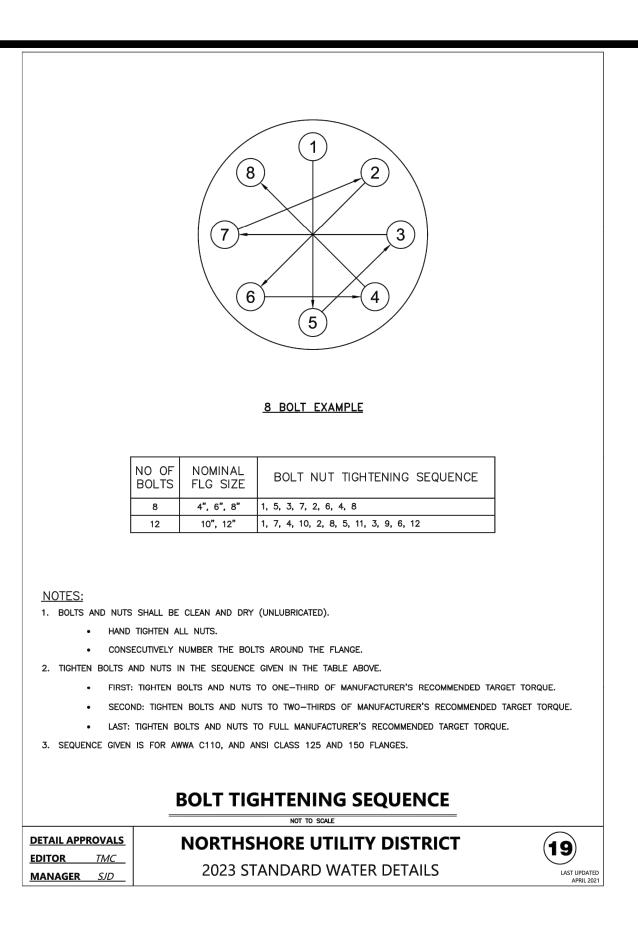

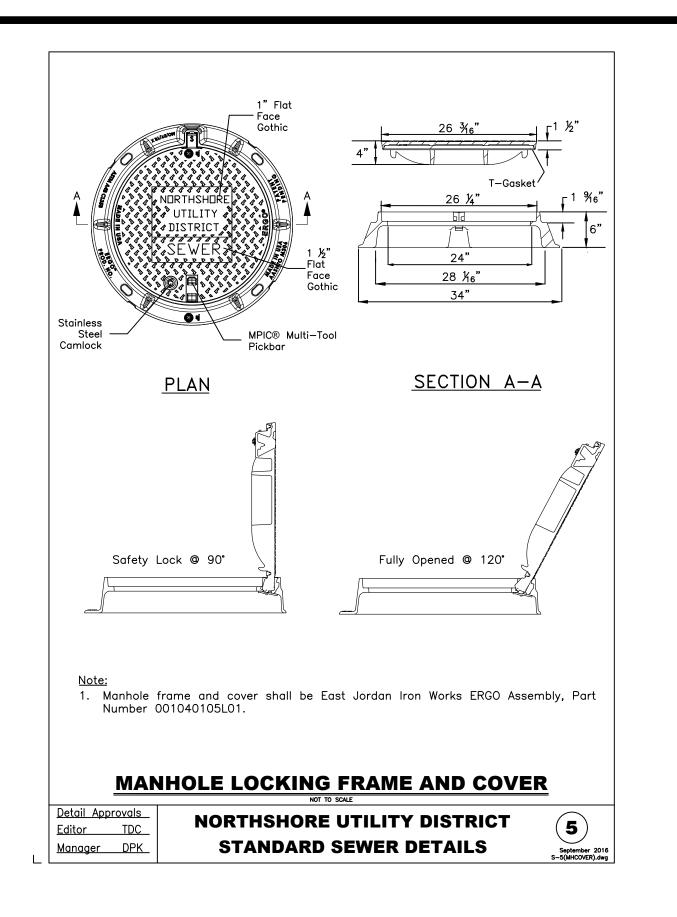

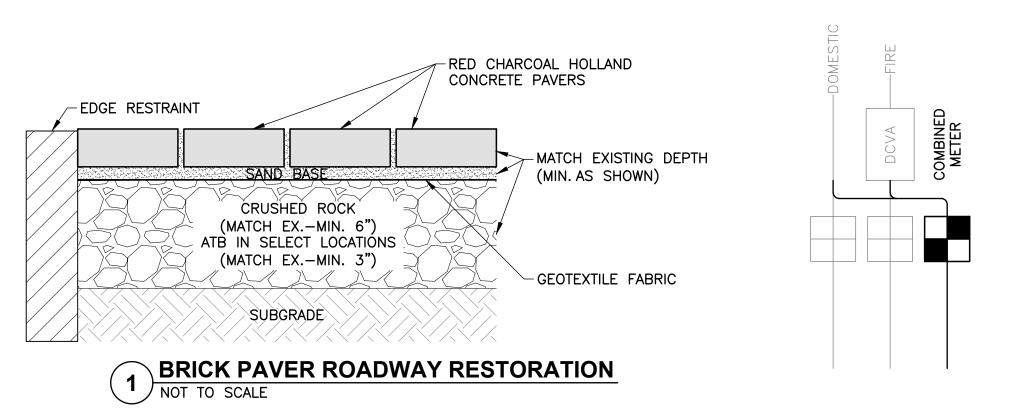

COMBINING DOMESTIC AND FIRE METERS INTO ONE SERVICE METER

NO	BY	APPD	REVISION	DATE	И
					V
					IF T NO
					TH
			BID SET DRAWING - NOT FOR CONSTRUCTION		IS N

NORTHSHORE UTILITY DISTRICT

2023 STANDARD WATER DETAILS

21

PACE 11255 Kirkland Way, Suite 300 Kirkland, WA 98033 THIS BAR DOES p. 425.827.2014 | f. 425.827.5043 OT MEASURE 1 Civil | Structural | Planning | Survey HEN DRAWING paceengrs.com NOT TO SCALE

DESIGNED BY DRAWN CHECKED MAR 2023 DATE PACE JOB # 21061.00



NORTHSHORE UTILITY DISTRICT

6830 NE 185th St. P.O. Box 82489 Kenmore, WA 98028-2684 Kenmore, WA 98028-2684

Ph: (425) 398-4400 | **Fax:** (425) 398-4430 | **www.nud.net**

CONTRACT 2023-02 WOODLAND COVE WATER SERVICE REPLACEMENT

DETAILS

ONAL
BASE MAP L7
C1817
SHEET
24 of _24