# NORTHSHORE UTILITY DISTRICT

# King County, Washington



CONTRACT 2022-01
GRINDER PUMP STATIONS 1-4 REPLACEMENT
NOVEMBER 2022



BID SET


D. BRUCE GARDINER
SUZANNE GREATHOUSE
MATT BREYSSE
THOMAS D. MORTIMER
TRUDY C. ROLLA
ALAN G. NELSON

President of the Board
Secretary of the Board
Commissioner
Commissioner
Commissioner

General Manager

## SHEET INDEX

	SHEET INDEX
Sheet Number	Sheet Description
1	COVER
2	ABREVIATIONS & AREA MAP
3	GENERAL NOTES, LEGEND, & TESC
4	GENERAL DETAILS
5	GRINDER PUMP STATION 1 EXISTING SITE & TESC PLAN
6	GRINDER PUMP STATION 1 BYPASS PUMPING PLAN
7	GRINDER PUMP STATION 1 DEMOLITION
8	PROPOSED GRINDER PUMP STATION 1
9	GRINDER PUMP STATION 1 RESTORATION PLAN
10	GRINDER PUMP STATION 2 EXISTING SITE & TESC PLAN
11	GRINDER PUMP STATION 2 BYPASS PUMPING PLAN
12	GRINDER PUMP STATION 2 DEMOLITION
13	PROPOSED GRINDER PUMP STATION 2
14	GRINDER PUMP STATION 2 RESTORATION PLAN
15	GRINDER PUMP STATION 3 EXISTING SITE & TESC PLAN
16	GRINDER PUMP STATION 3 BYPASS PUMPING PLAN
17	GRINDER PUMP STATION 3 DEMOLITION
18	PROPOSED GRINDER PUMP STATION 3
19	GRINDER PUMP STATION 3 RESTORATION PLAN
20	GRINDER PUMP STATION 4 EXISTING SITE & TESC PLAN
21	GRINDER PUMP STATION 4 BYPASS PUMPING PLAN
22	GRINDER PUMP STATION 4 DEMOLITION
23	PROPOSED GRINDER PUMP STATION 4
24	GRINDER PUMP STATION 4 RESTORATION PLAN
25	ELECTRICAL SYMBOLS, ABBREVIATIONS, NOTES AND WORK SUMMARY
26	GRINDER PUMP STATION 1 ELECTRICAL PLAN
27	GRINDER PUMP STATION 2 ELECTRICAL PLAN
28	GRINDER PUMP STATION 3 ELECTRICAL PLAN
29	GRINDER PUMP STATION 4 ELECTRICAL PLAN
30	ELECTRICAL DETAILS

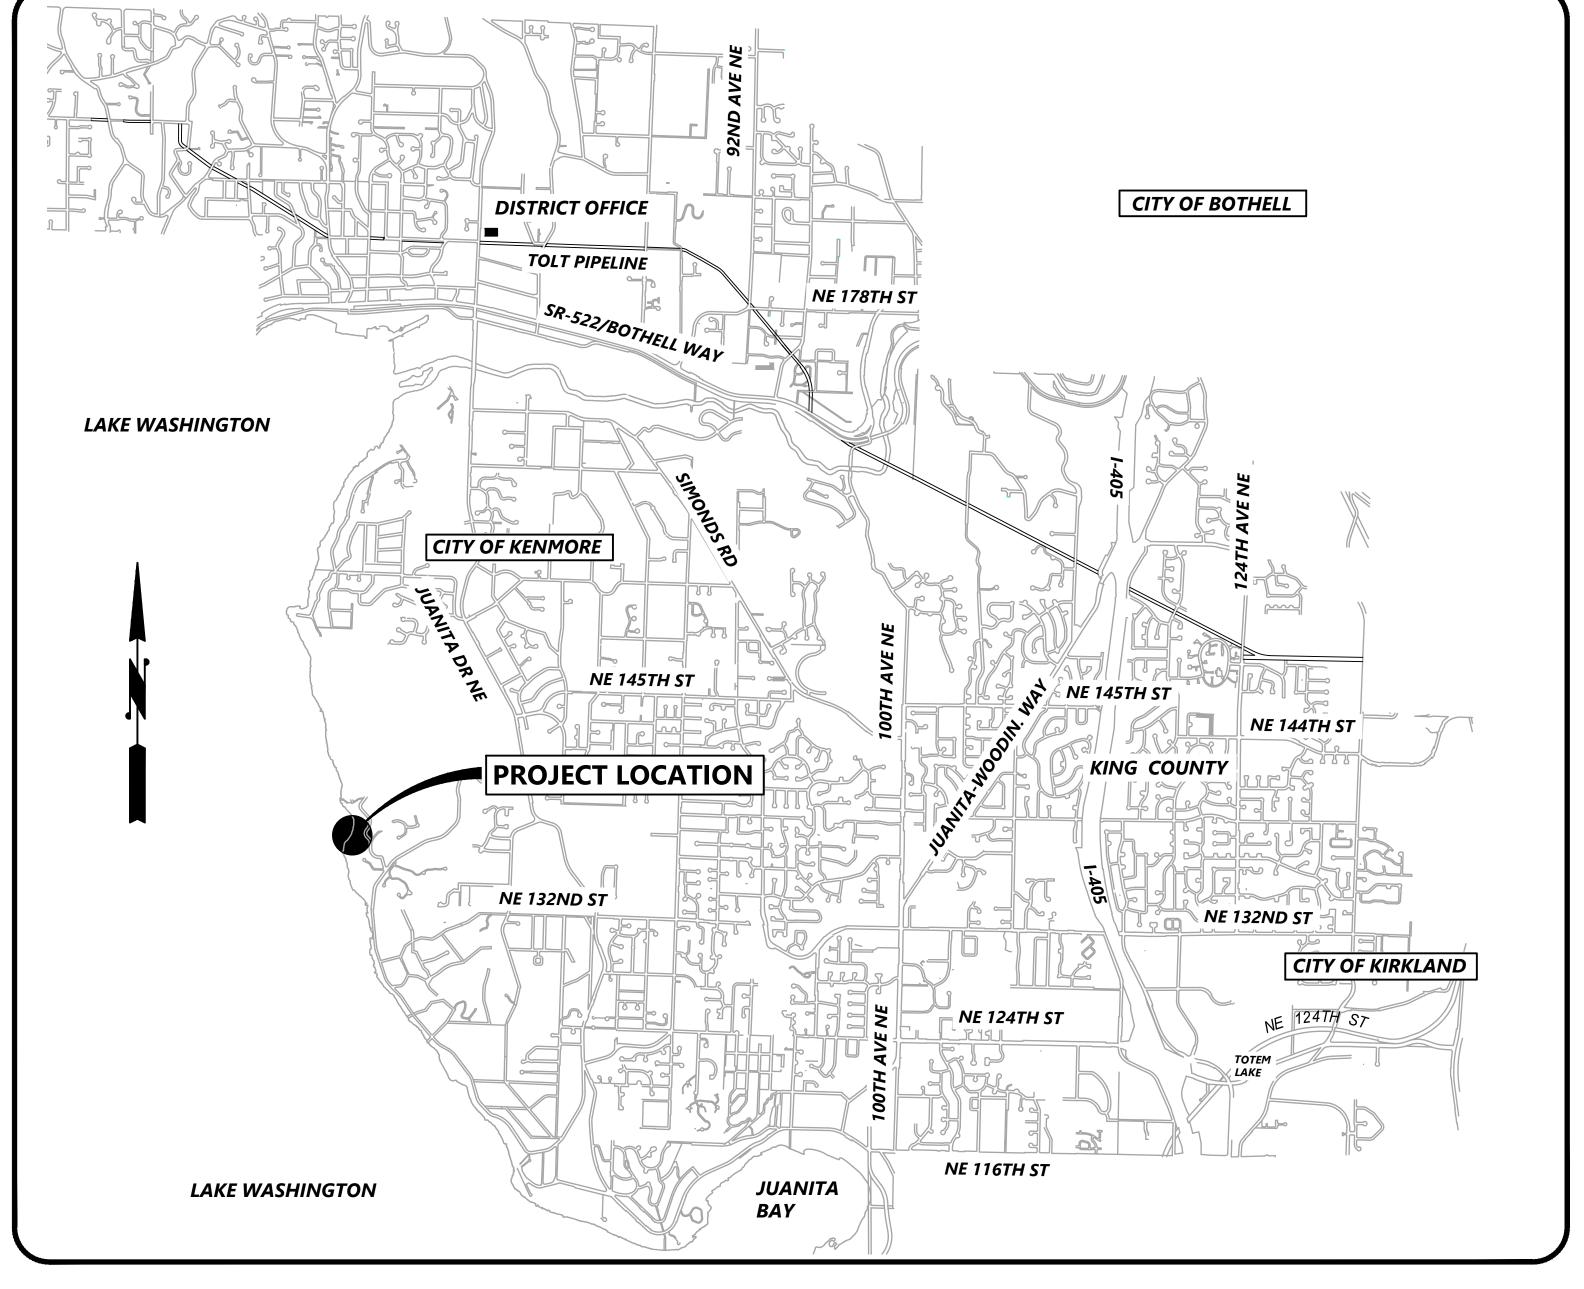

C2003


SHEET

1 OF 31

VICINITY MAP

NOT TO SCALE

M:\Nshore\205.33.00 C2003 Grinder Stations Replacement\01 Desian\PI ANSFT\General\COVFR.dwa

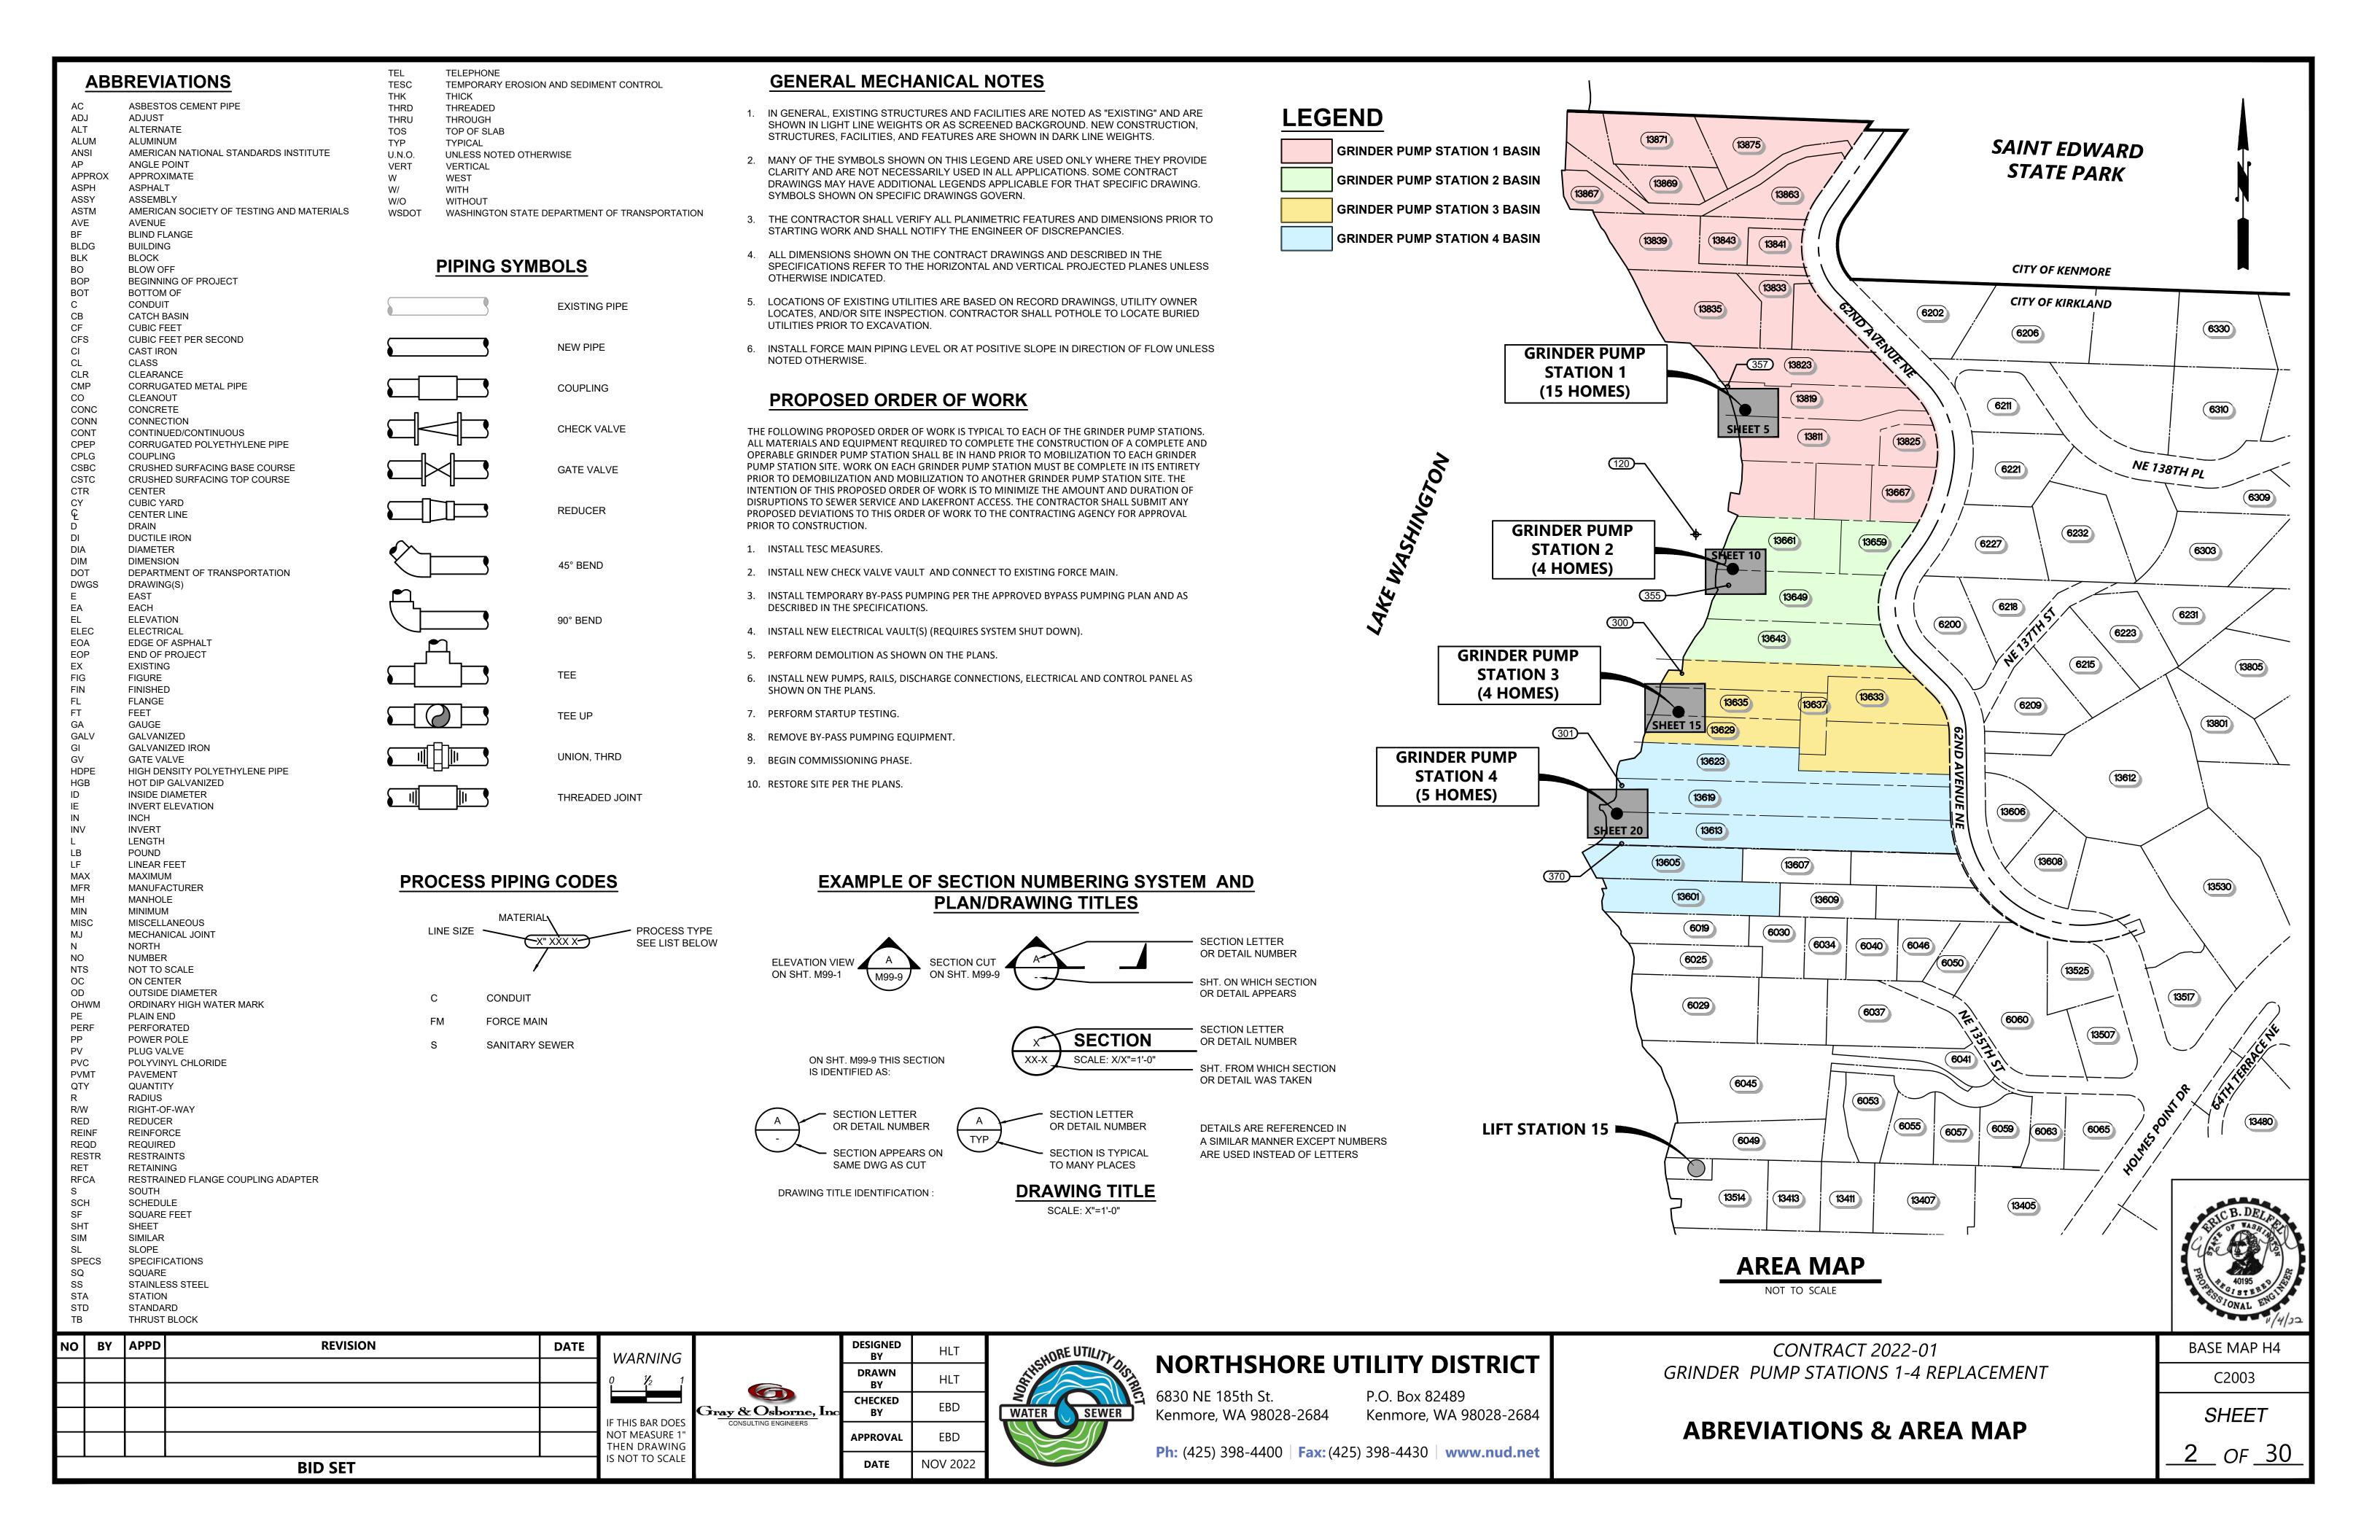

### **LEGEND**

EXISTING	PROPOSED	DESCRIPTION
		PROPERTY LINE
		RIGHT OF WAY LINE
·		EASEMENT
		CONSTRUCTION LIMITS
		ROOT BARRIER
		DITCH CENTERLINE
		SIDE SLOPE
8" DI W		WATER LINE
8" PVC SS		SANITARY SEWER LINE
		SEWER FORCE MAIN
		STORM DRAIN LINE
·		STORM DRAIN CULVERT
FL		SWALE OR DITCH
G		GAS LINE
PWR —		UNDERGROUND POWER LINE
OHP		OVERHEAD POWER LINE
тт		TELEPHONE LINE
c		CABLE LINE
F0		FIBER OPTIC LINE
и и и и и и		WIRE FENCE
		WOOD FENCE
		CHAIN LINK FENCE
<b>H</b>		WATER METER
- <u>©</u> -		FIRE HYDRANT
×		WATER VALVE
Å		BLOW OFF ASSEMBLY
0	•	CLEAN OUT
0		SANITARY MANHOLE
		STORM DRAIN MANHOLE
		STORM DRAIN CATCH BASIN
Ø		GAS VALVE
- <del>-</del>		POWER POLE
<del>(</del>		GUY ANCHOR
<b>←</b>		LIGHT POLE
(C) = >		SIGNAL POLE
P		ELECTRICAL VAULT
<u>_'</u>		ELECTRICAL HANDHOLE
		COMMUNICATIONS VAULT
		TELEPHONE HANDHOLE
		SIGN
•	~~~	MONUMENT
		ROCKERY/ROCK WALL
		MAIL BOX(ES)
		CONIFER TREE
<b>8</b>		DECORATIVE TREE
$\bigcirc$		DECIDUOUS TREE
9		SHRUB
		RETAINING WALL
· · · · · · · · · · · · · · · · · · ·		CEMENT CONCRETE PAVEMENT
		CEMENT CONCRETE CURB, GUTTER
		ASPHALT CONCRETE PAVEMENT
		SAND
		CDAVEL
		GRAVEL
		GRASS

#### **GENERAL NOTES:**

- 1. ALL CONSTRUCTION AND MATERIALS SHALL BE IN ACCORDANCE WITH THE REQUIREMENTS SPECIFIED IN THE CONTRACT SPECIFICATIONS.
- 2. THE APPROXIMATE LOCATIONS OF EXISTING UTILITIES ARE SHOWN ON THE PLANS FOR CONVENIENCE. THE CONTRACTOR SHALL BE RESPONSIBLE FOR VERIFICATION OF UTILITY LOCATIONS SHOWN, FOR THE PROTECTION AND REPAIR OF DAMAGED UTILITIES AND FOR THE DISCOVERY OF POSSIBLE ADDITIONAL UTILITIES NOT SHOWN ON THE PLANS. IT SHALL BE THE RESPONSIBILITY OF THE CONTRACTOR TO HAVE LOCATED, BY THE APPROPRIATE UTILITY DISTRICTS OR COMPANIES, ALL UNDERGROUND UTILITIES PRIOR TO BEGINNING CONSTRUCTION. FOR UTILITY LOCATES IN KING COUNTY, CALL 1-800-424-5555 PRIOR TO DIGGING.
- 3. A PRE-CONSTRUCTION CONFERENCE WILL BE HELD AT THE DISTRICT OFFICE PRIOR TO START OF CONSTRUCTION.
- 4. THE CONTRACTOR SHALL NOTIFY NORTHSHORE UTILITY DISTRICT A MINIMUM OF FIVE (5) DAYS IN ADVANCE OF BEGINNING CONSTRUCTION. CONSTRUCTION SHALL NOT BEGIN WITHOUT PRIOR WRITTEN NOTICE TO PROCEED BY THE DISTRICT.
- 5. THE CONTRACTOR SHALL NOT OPERATE ANY VALVES OR MAKE ANY CONNECTIONS TO THE EXISTING SYSTEM WITHOUT PRIOR APPROVAL FROM THE DISTRICT.
- 6. EACH GRINDER PUMP STATION SITE IS WITHIN AN EXISTING EASEMENT ON PRIVATE LAKEFRONT PROPERTY WITH LIMITED ACCESSIBILITY FOR LARGE EQUIPMENT AND MOTOR VEHICLES. THE MEANS AND METHODS FOR MOBILIZATION OF MATERIALS AND EQUIPMENT TO EACH SITE SHALL BE AT THE OPTION OF THE CONTRACTOR. HAND DIGGING AND/OR BARGING IN EQUIPMENT MAY BE NECESSARY FOR COMPLETION OF THE WORK SHOWN ON THE PLANS AND DESCRIBED IN THE SPECIFICATIONS.

#### SURVEY CONTROL DATA

HORIZONTAL DATUM:

WASHINGTON STATE COORDINATE SYSTEM, NORTH ZONE NAD83(91), US FEET UTILIZING RTK GPS FIELD PROCEDURES

<u>VERTICAL DATUM:</u> NAVD88, US FEET AS PRESCRIBED BY NORTHSHORE UTILITY DISTRICT.

**TOPOGRAPHIC MAPPING:** 

THE MAP SHOWN HEREON IS THE RESULT OF A TOPOGRAPHIC SURVEY BY DUANE HARTMAN & ASSOCIATES, INC. (DHA) COMPLETED ON JANUARY 20, 2010 AND SUPLEMENTED BY SURVEY PERFORMED BY GRAY & OSBORNE INC. (G&O) ON AUGUST 6, 2020. DHA ASSUMES NO LIABILITY, BEYOND SAID DATE, FOR ANY FUTURE SURFACE FEATURE MODIFICATIONS OR CONSTRUCTION ACTIVITIES THAT MAY OCCUR WITHIN OR ADJOINING THE PERIMETER OF THIS SURVEY.

#### BENCHMARKS:

CONTROL POINT TABLE							
POINT	POINT NORTHING EASTING ELEV. DESCRIPTION						
120	267491.59 1289078.46 20.20 JUST TACK ON D ONLY LIGHT IN N SW'LY END CTR		SSLT, *** TALK TO HOMEOWNER BEFORE USING POINT AGAIN*** JUST TACK ON DOCK. 3.4' SE OF W'LY DOCK EDGE. 4.7' W-SW OF ONLY LIGHT IN NE-SW MID POINT ON E'LY SIDE. 11.3' NE'LY OF SW'LY END CTR DOCK. TACK IS IN THE 6TH PLANK FROM W'LY SIDE & E'LY SIDE(CTR). 0.03 E'LY FROM W'LY EDGE OF CTR PLANK.				
300	267243.04	4 1289053.59 19.31 3.5' W-NW OF EDGE G AND GRASS. ~10' S O		SFR, 5/8" REBAR NO CAP. 0.25' DOWN IN SAND. NE'LY QUAD BEACH. 3.5' W-NW OF EDGE GRASS. ~7.25' S-SW OF ANGLE POINT DOCK AND GRASS. ~10' S OF SLIDING SIDE DOOR TO BOAT HOUSE. 10.6' S-SW OF SE BOAT HSE COR.			
301	267043.25	1288946.21	19.43	SFRC, 5/8" REBAR W/RED CAP "DHA CONT" IN W'LY EDGE GRASS PROP. N OF GRINDER #4. 1.2' E OF W EDGE GRASS @ BEACH. ~7.3' N-NW OF N'LY END BULK HEAD(UNDER GRASS). ~19' W-NW OF CENTER FIRE PIT. ~28' W OF CL W FACE CABANA.			
355	267400.73	1289136.83	21.71	SFRC 5/8" REBAR RED CAP "DHA CONT" 0.2' DOWN. 1.15' W OF W FACE WOOD RET WALL. ~3.1' S-SW OF NW COR RET WALL. ~15' NE OF NW COR DECK.			
357	267755.62	1289135.01	19.53	SFRC, 21.2' N15E OF CTR N'LY DOCK LIGHT ON E SIDE(SHORE) OF DOCK IN BEACH.			
370	266939.29	1288945.82	23.94	SFRC, 5/8" REBAR W/RED CAP "DHA CONT" 0.1' DOWN IN GRASS. 1' N OF WOOD FENCE. ~4.9' SW OF SW'LY BC. ~5.4' E-NE OF W END WOOD FENCE.			

#### SURVEY SYMBOLS

WARNING

DATE


EXISTING	PROPOSED	DESCRIPTION
+		BENCH MARK
٥		IRON PIPE/REBAR


DESIGNED BY

NOV 2022

#### TEMPORARY EROSION AND SEDIMENTATION CONTROL NOTES

- 1. THE TEMPORARY EROSION AND SEDIMENTATION CONTROL (TESC) FACILITIES SHALL BE IMPLEMENTED PRIOR TO THE START OF ANY CONSTRUCTION ACTIVITIES. AND IN SUCH A MANNER AS TO ENSURE THAT SEDIMENT WATER DOES NOT ENTER THE DRAINAGE SYSTEM OR VIOLATE APPLICABLE WATER STANDARDS. MAINTENANCE, REPLACEMENT, AND UPGRADING OF THESE TESC FACILITIES IS THE RESPONSIBILITY OF THE CONTRACTOR UNTIL ALL CONSTRUCTION IS APPROVED.
- 2. THE STORM DRAIN INLET PROTECTION DEVICE SHALL BE SILT SACK OR EQUAL. ALL CATCH BASINS WITHIN THE VICINITY OF THE CONSTRUCTION SHALL HAVE INLET PROTECTION MEASURES.
- 3. CONTRACTOR SHALL MAINTAIN ALL EXISTING DRAINAGE CHANNELS, CULVERTS, SWALES AND STRUCTURES. WHENEVER EXISTING DRAINAGE FACILITIES ARE DISTURBED, THE CONTRACTOR SHALL PROVIDE SUITABLE MEANS FOR DIVERTING AND MAINTAINING ALL FLOWS DURING CONSTRUCTION IN THAT AREA AT ITS EXPENSE. AFTER CONSTRUCTION HAS BEEN COMPLETED, ALL DRAINAGE CHANNELS, CULVERTS, SWALES AND STRUCTURES DISTURBED SHALL BE RETURNED TO THEIR ORIGINAL CONDITIONS.
- 4. THE TESC FACILITIES SHOWN ON THIS PLAN ARE THE MINIMUM REQUIREMENTS FOR ANTICIPATED SITE CONDITIONS. DURING THE CONSTRUCTION PERIOD, TESC FACILITIES SHALL BE MAINTAINED AND UPGRADED AS NECESSARY BY THE CONTRACTOR.
- 5. CONTRACTOR SHALL INSPECT THE TESC FACILITIES AT THE END OF EACH WORKING DAY TO ASSURE ITSELF THAT THEY ARE IN GOOD CONDITIONS. IF TESC FACILITIES REQUIRE REPAIR/MAINTENANCE, IT SHALL BE PERFORMED PRIOR TO THE END OF THE WORKING DAY. ALL DISTURBED AREAS SHALL BE PROMPTLY AND THOROUGHLY STABILIZED AGAINST EROSION DURING PERIODS OF WET WEATHER WHEN WORK IS NOT BEING PERFORMED AT THE SITE.
- 6. ALL UNSUITABLE OR SURPLUS EXCAVATED OR CLEARED MATERIAL SHALL BE REMOVED FROM THE SITE AND DISPOSED OF IN AN APPROVED, LEGAL FILL SITE. IT SHALL BE THE CONTRACTOR'S RESPONSIBILITY TO LOCATE ACCEPTABLE DISPOSAL SITES AND ASSURE THAT ALL SURPLUS MATERIAL IS DISPOSED OF IN SAME.
- 7. CONTRACTOR SHALL BE RESPONSIBLE FOR IMPLEMENTING ALL APPROPRIATE MEASURES NEEDED (STREET SWEEPERS, WATER TRUCKS, ETC.) TO KEEP STREETS AND ROADS USED AS HAUL ROUTES FOR EXPORT OR IMPORT OF MATERIAL CLEAN AND FREE FROM DEBRIS, MUD, ETC.. ADDITIONAL MEASURES MAY BE REQUIRED TO ENSURE THAT ALL PAVED AREAS ARE KEPT CLEAN FOR THE DURATION OF THE PROJECT.

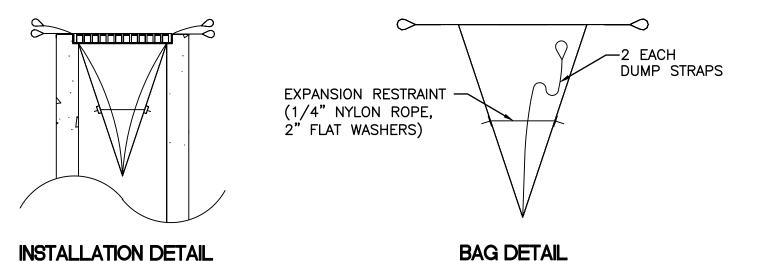


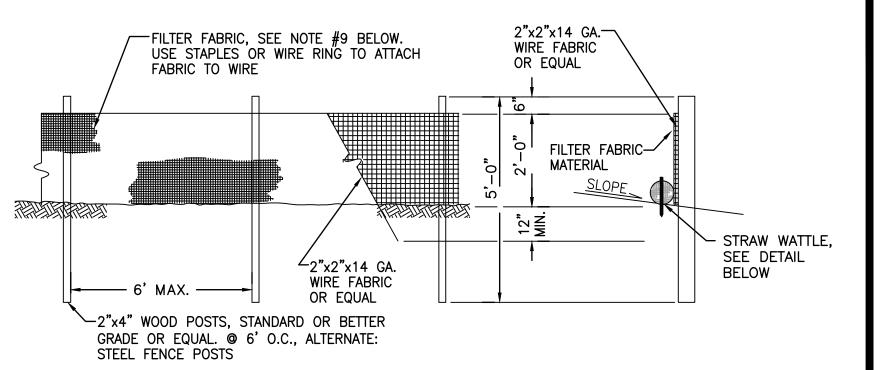


#### NOTES

- 1. THE FILTER FABRIC SHALL BE PURCHASED IN A CONTINUOUS ROLL CUT TO THE LENGTH OF THE BARRIER TO AVOID USE OF JOINTS. WHEN JOINTS ARE NECESSARY, FILTER CLOTH SHALL BE SPLICED TOGETHER ONLY AT A SUPPORT POST, WITH A MINIMUM 6-INCH OVERLAP AND BOTH ENDS SECURELY FASTENED TO THE POST.
- 2. THE FILTER FABRIC FENCE SHALL BE INSTALLED TO FOLLOW THE CONTOURS (WHERE FEASIBLE). THE FENCE POSTS SHALL BE SPACED A MAXIMUM OF 6 FEET APART AND DRIVEN SECURELY INTO THE GROUND (MINIMUM OF 30 INCHES).
- WHEN STANDARD STRENGTH FILTER FABRIC IS USED, A WIRE MESH SUPPORT FENCE SHALL BE FASTENED SECURELY TO THE UPSLOPE SIDE OF THE POSTS USING HEAVY-DUTY WIRE STAPLES AT LEAST 1 INCH LONG. TIE WIRE OR HOG RINGS.
- 4. THE STANDARD STRENGTH FILTER FABRIC SHALL BE STAPLED OR WIRED TO THE FENCE, AND 20 INCHES OF THE FABRIC SHALL BE EXTENDED ACROSS THE GROUND, UPSLOPE AND ADJACENT TO THE WOOD POST. THE FABRIC SHALL NOT EXTEND MORE THAN 30 INCHES ABOVE THE ORIGINAL GROUND SURFACE. FILTER FABRIC SHALL NOT BE STAPLED TO EXISTING TREES.
- WHEN EXTRA FILTER FABRIC AND CLOSER POST SPACING ARE USED, THE WIRE MESH SUPPORT FENCE MAY BE ELIMINATED. IN SUCH A CASE, THE FILTER FABRIC IS STAPLED OR WIRED DIRECTLY TO THE POSTS WITH ALL OTHER PROVISIONS OF STANDARD NOTE 3 APPLYING.
- 6. FABRIC SHALL BE SECURED AT THE BASE BY PEA-ROCK FILLED SANDBAGS OR STRAW WATTLES PLACED END TO END.
- FILTER FABRIC FENCES SHALL BE REMOVED WHEN THEY HAVE SERVED THEIR USEFUL PURPOSE, BUT NOT BEFORE THE UPSLOPE AREA HAS BEEN PERMANENTLY STABILIZED.
- FILTER FABRIC FENCES SHALL BE INSPECTED IMMEDIATELY AFTER EACH RAINFALL AND AT LEAST DAILY DURING PROLONGED RAINFALL. ANY REQUIRED REPAIRS SHALL BE MADE IMMEDIATELY.
- 9. FILTER FABRIC SHALL BE PER CURRENT GEOTEXTILE FABRIC STANDARDS FOR SILT FENCE IN THE DEPARTMENT OF ECOLOGY STORMWATER MANAGEMENT MANUAL FOR WESTERN WASHINGTON.

# HIGH VISIBILITY FILTER FABRIC FENCE

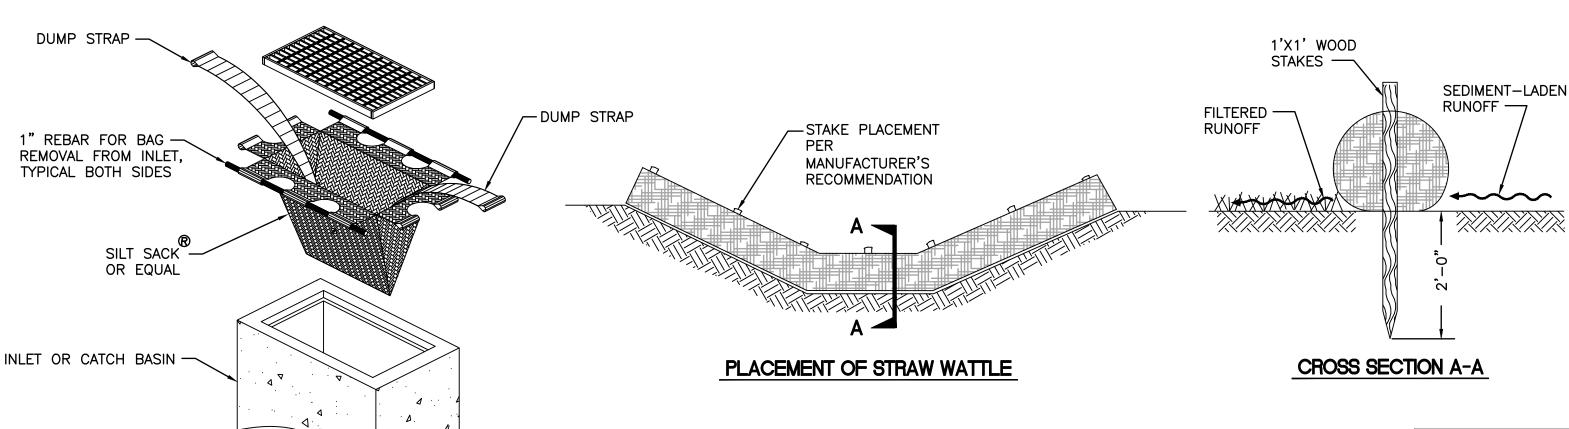

STRAW WATTLE DAM NOT TO SCALE

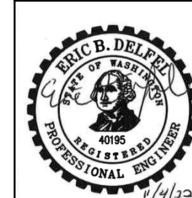

STORM DRAIL	N INLE	T PROT	ECTION
	NOT TO SO	CALE	

**CONTRACT 2022-01** GRINDER PUMP STATIONS 1-4 REPLACEMENT

**GENERAL NOTES, LEGEND, & TESC** 

BASE MAP H4 C2003 SHEET

<u>3</u> of <u>30</u>

NORTHSHORE	UTILITY DISTRICT
5830 NF 185th St	P.O. Box 82489

Kenmore, WA 98028-2684

Kenmore, WA 98028-2684


Ph: (425) 398-4400 | Fax: (425) 398-4430 | www.nud.net


**BID SET** 

**REVISION** 

BY APPD

1/2 1		DRAWN BY
	Gr <u>ay &amp; Osborne,</u> Inc	CHECKED BY
THIS BAR DOES OT MEASURE 1" HEN DRAWING	CONSULTING ENGINEERS	APPROVAL
NOT TO SCALE		DATE

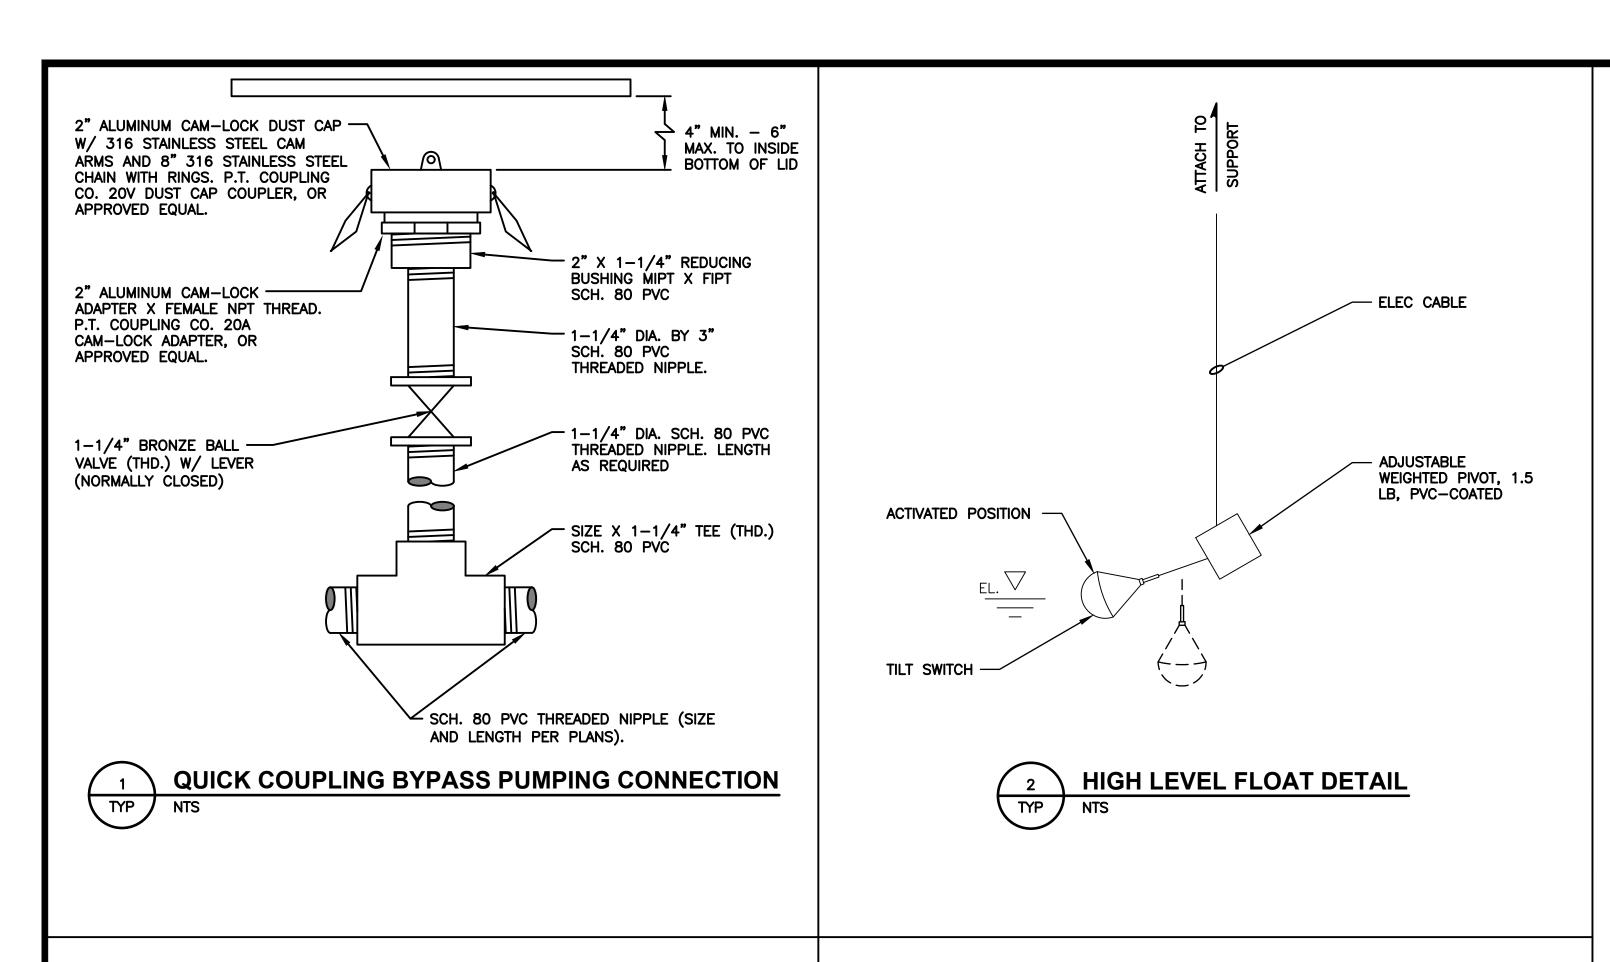


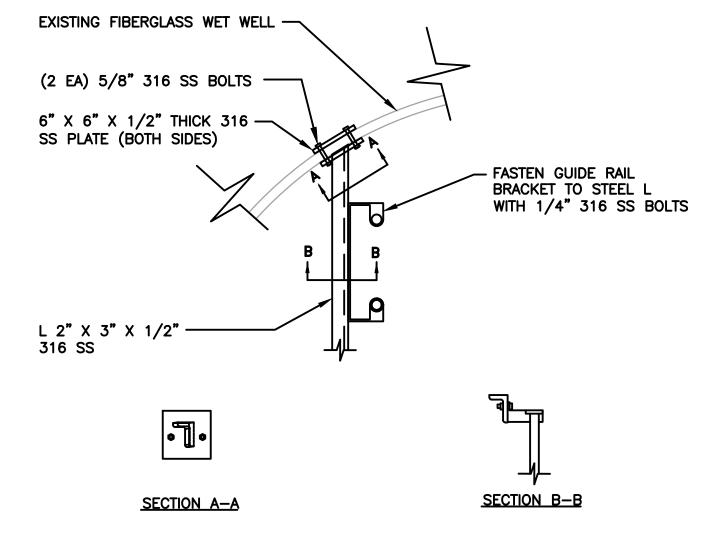


- 1. MOUNT GUIDE RAIL BRACKET SUPPORT 6" BELOW RIM ELEVATION OF EXISTING WET WELL
- 2. ALL HARDWARE AND ACCESSORIES SHALL BE 316 SS UNLESS NOTED OTHERWISE.





**BID SET** 

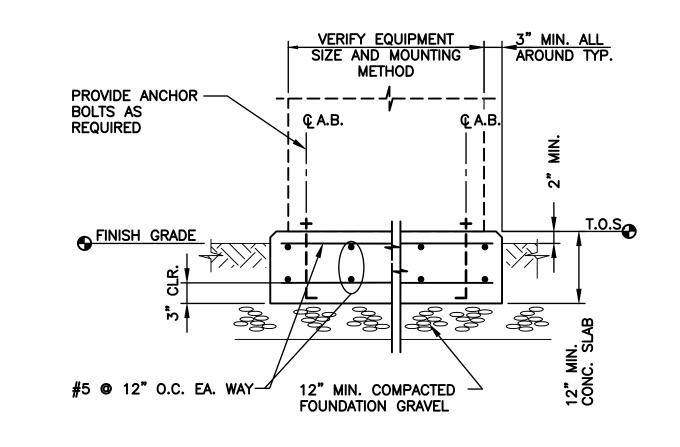




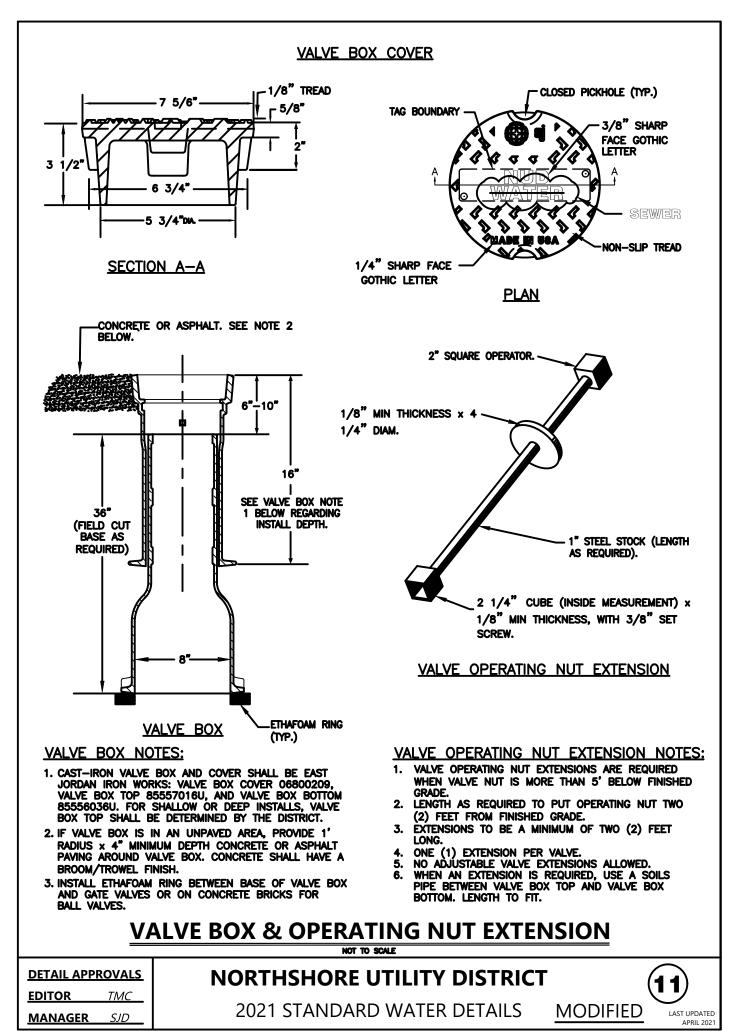

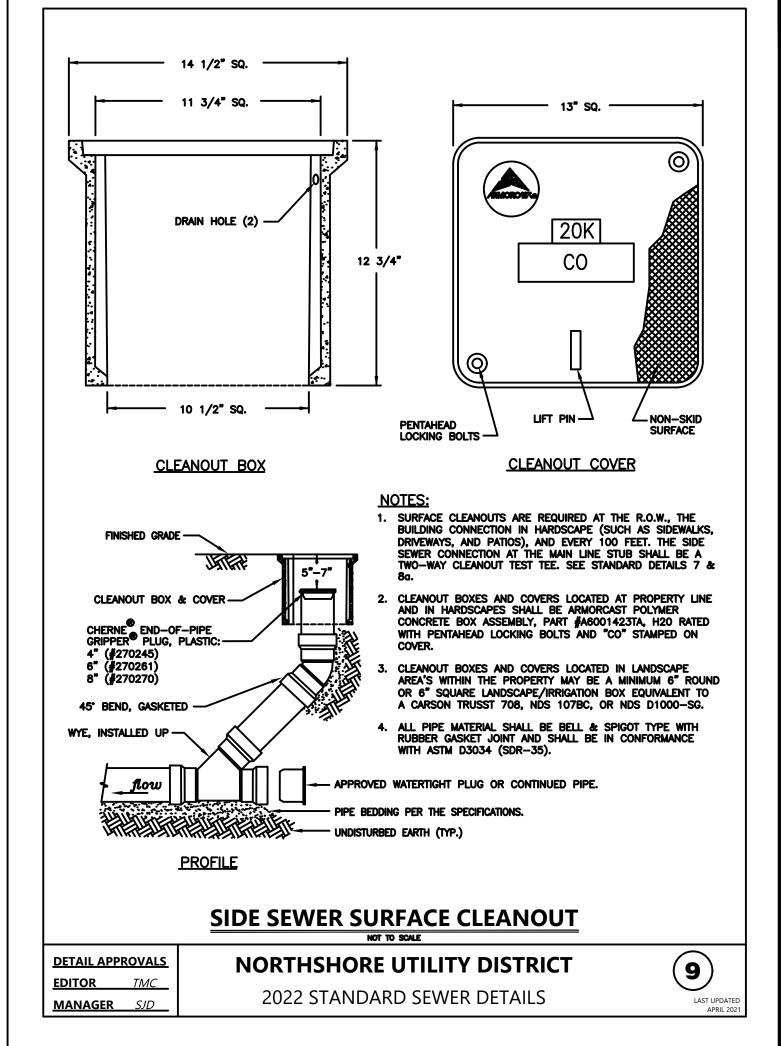

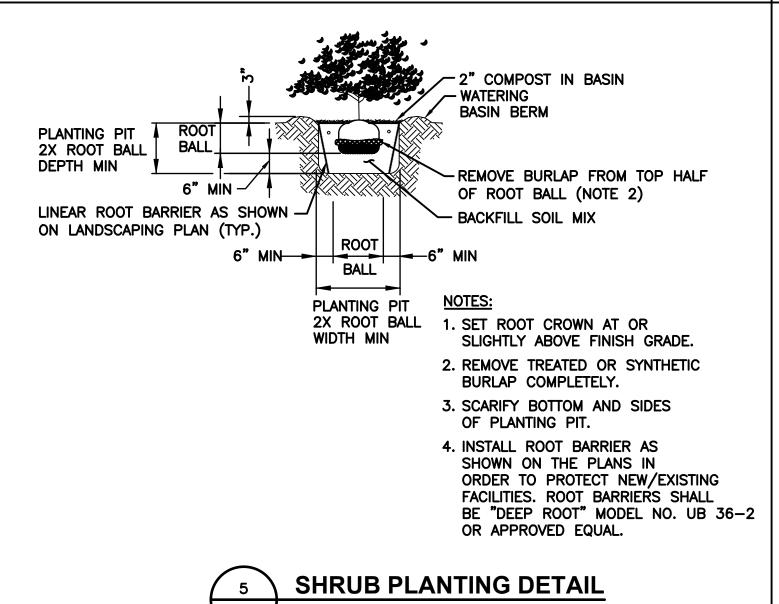

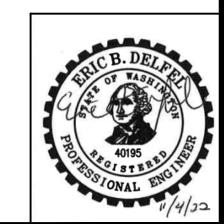


BASE MAP H4

M/A DAIII	DATE	REVISION	APPD	ВҮ	10
WARNII					
THIS BAR [					

NOT MEASURE 1' THEN DRAWING IS NOT TO SCALE

Gray & Osborne, In



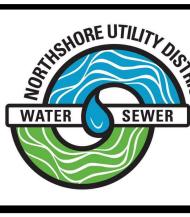

# **NORTHSHORE UTILITY DISTRICT**

6830 NE 185th St. Kenmore, WA 98028-2684


P.O. Box 82489 Kenmore, WA 98028-2684


Ph: (425) 398-4400 | Fax: (425) 398-4430 | www.nud.net


**CONTRACT 2022-01** GRINDER PUMP STATIONS 1-4 REPLACEMENT

C2003 SHEET <u>4</u> *OF* <u>30</u>

**GENERAL DETAILS** 

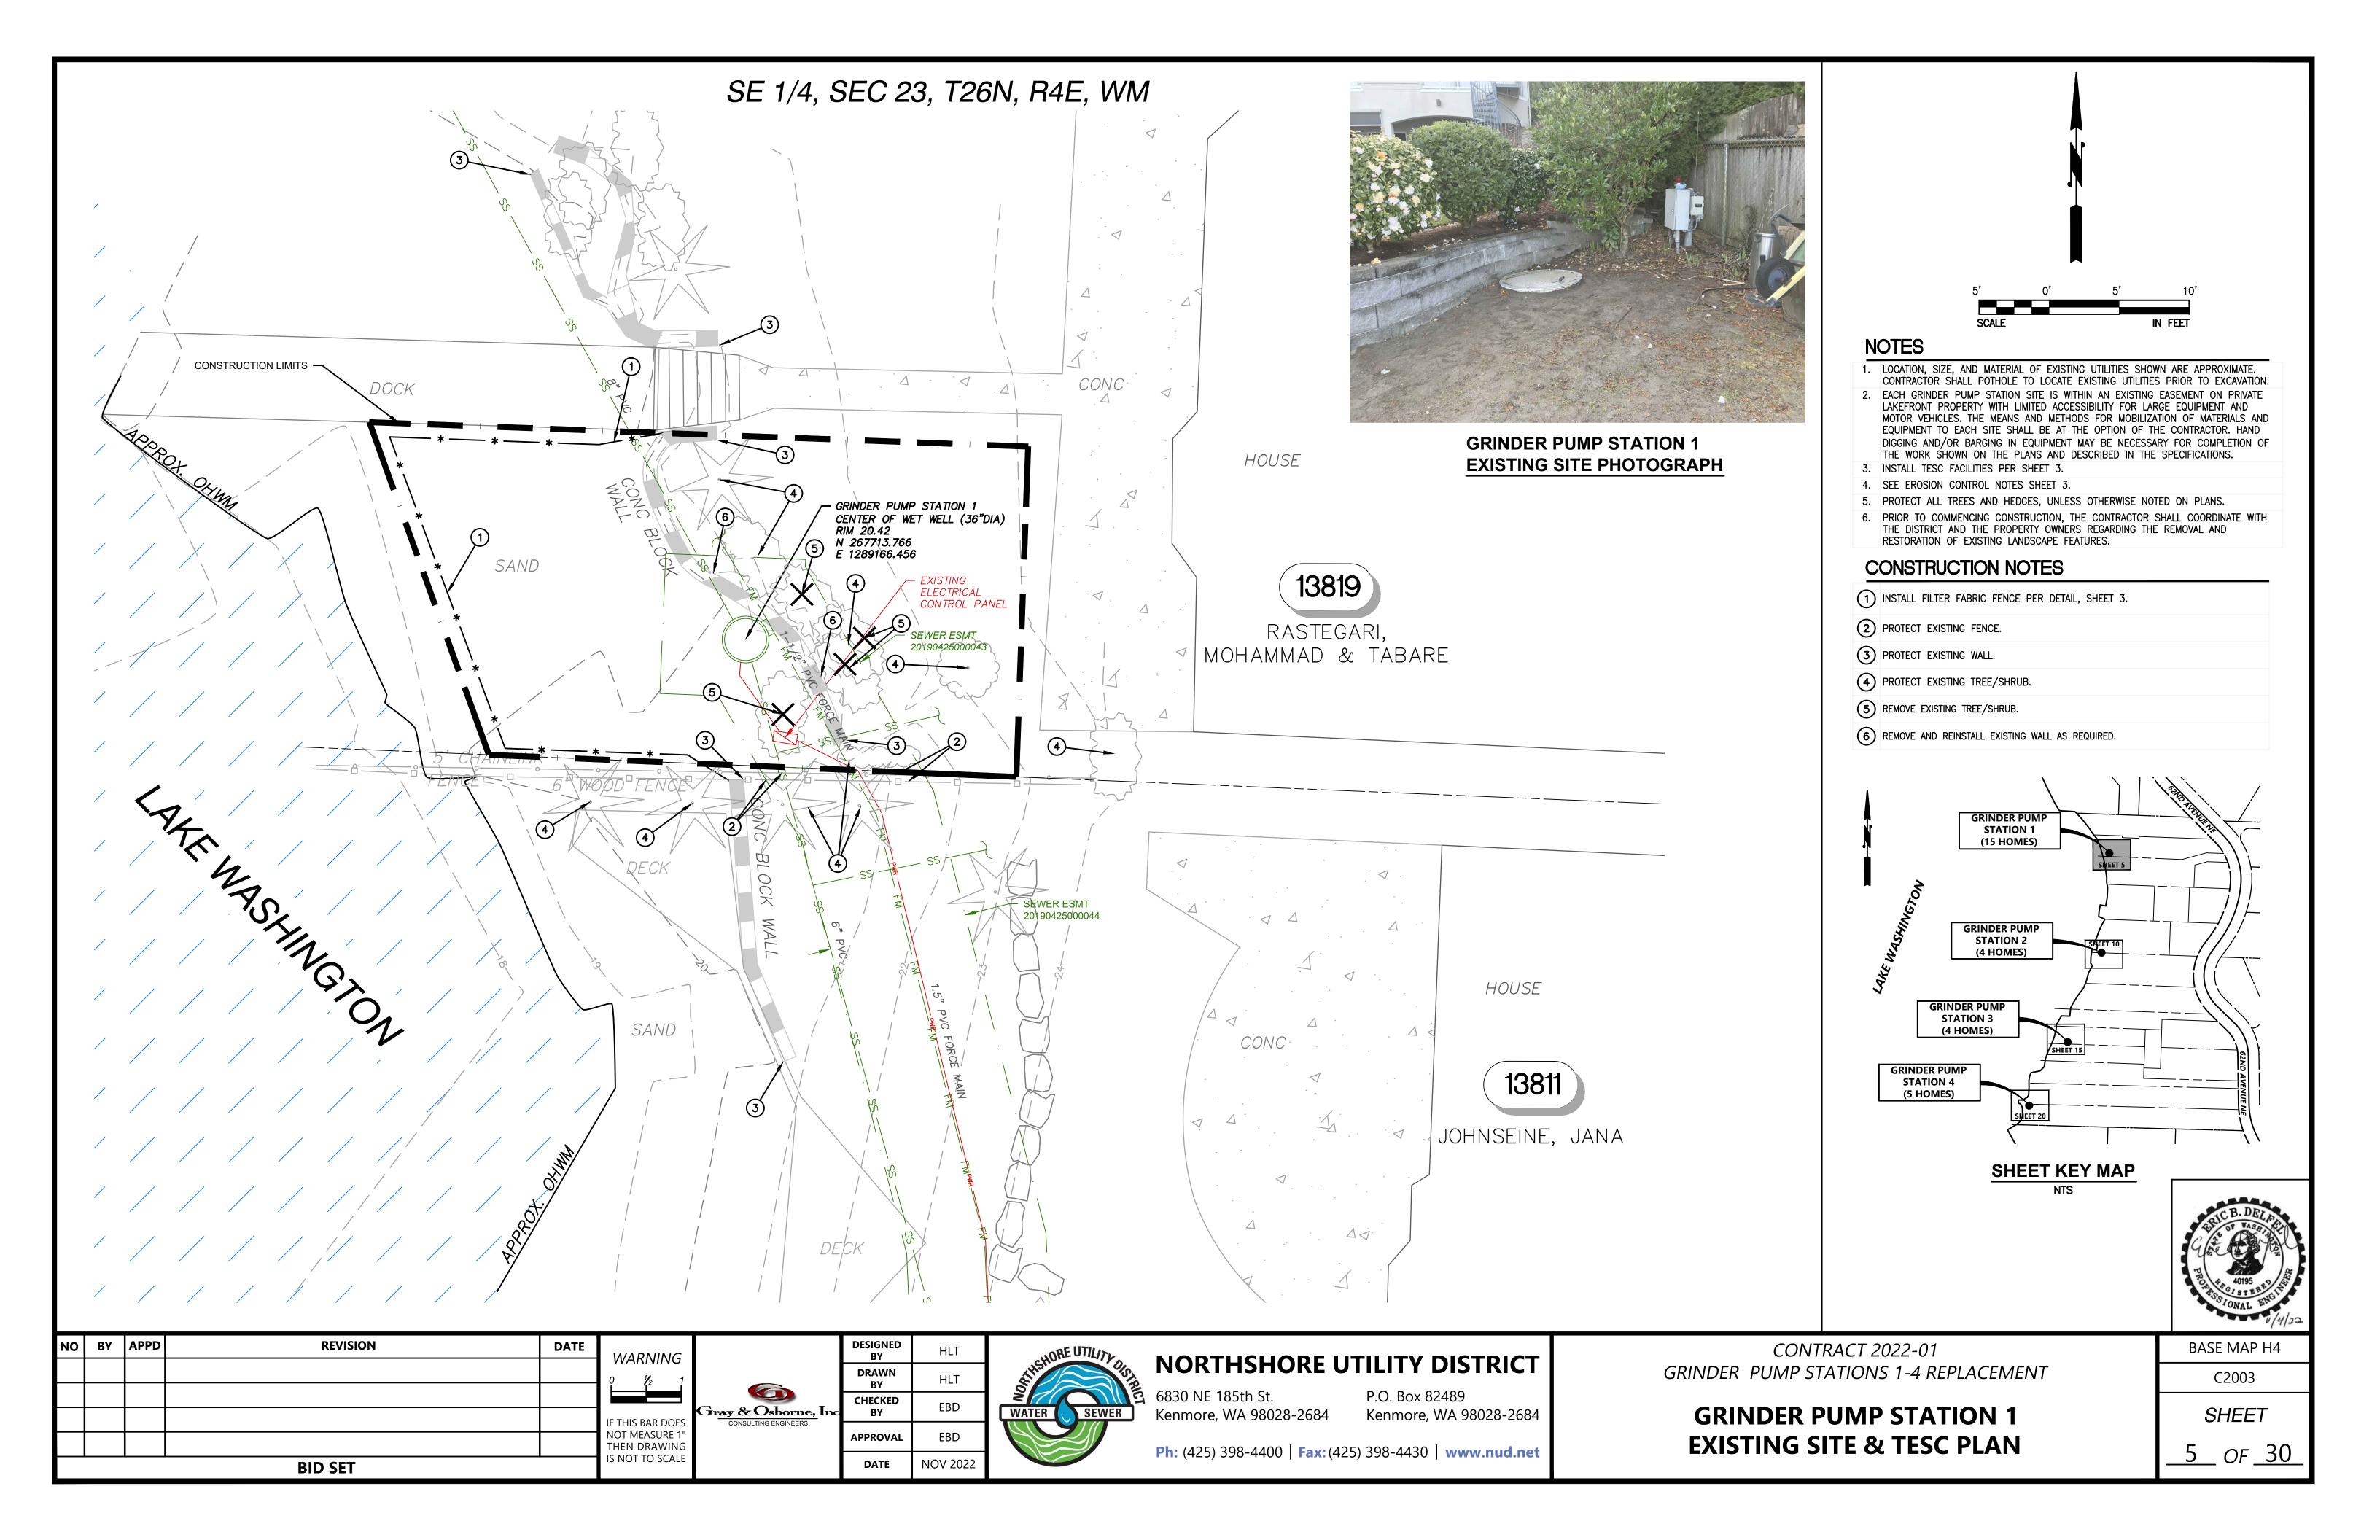

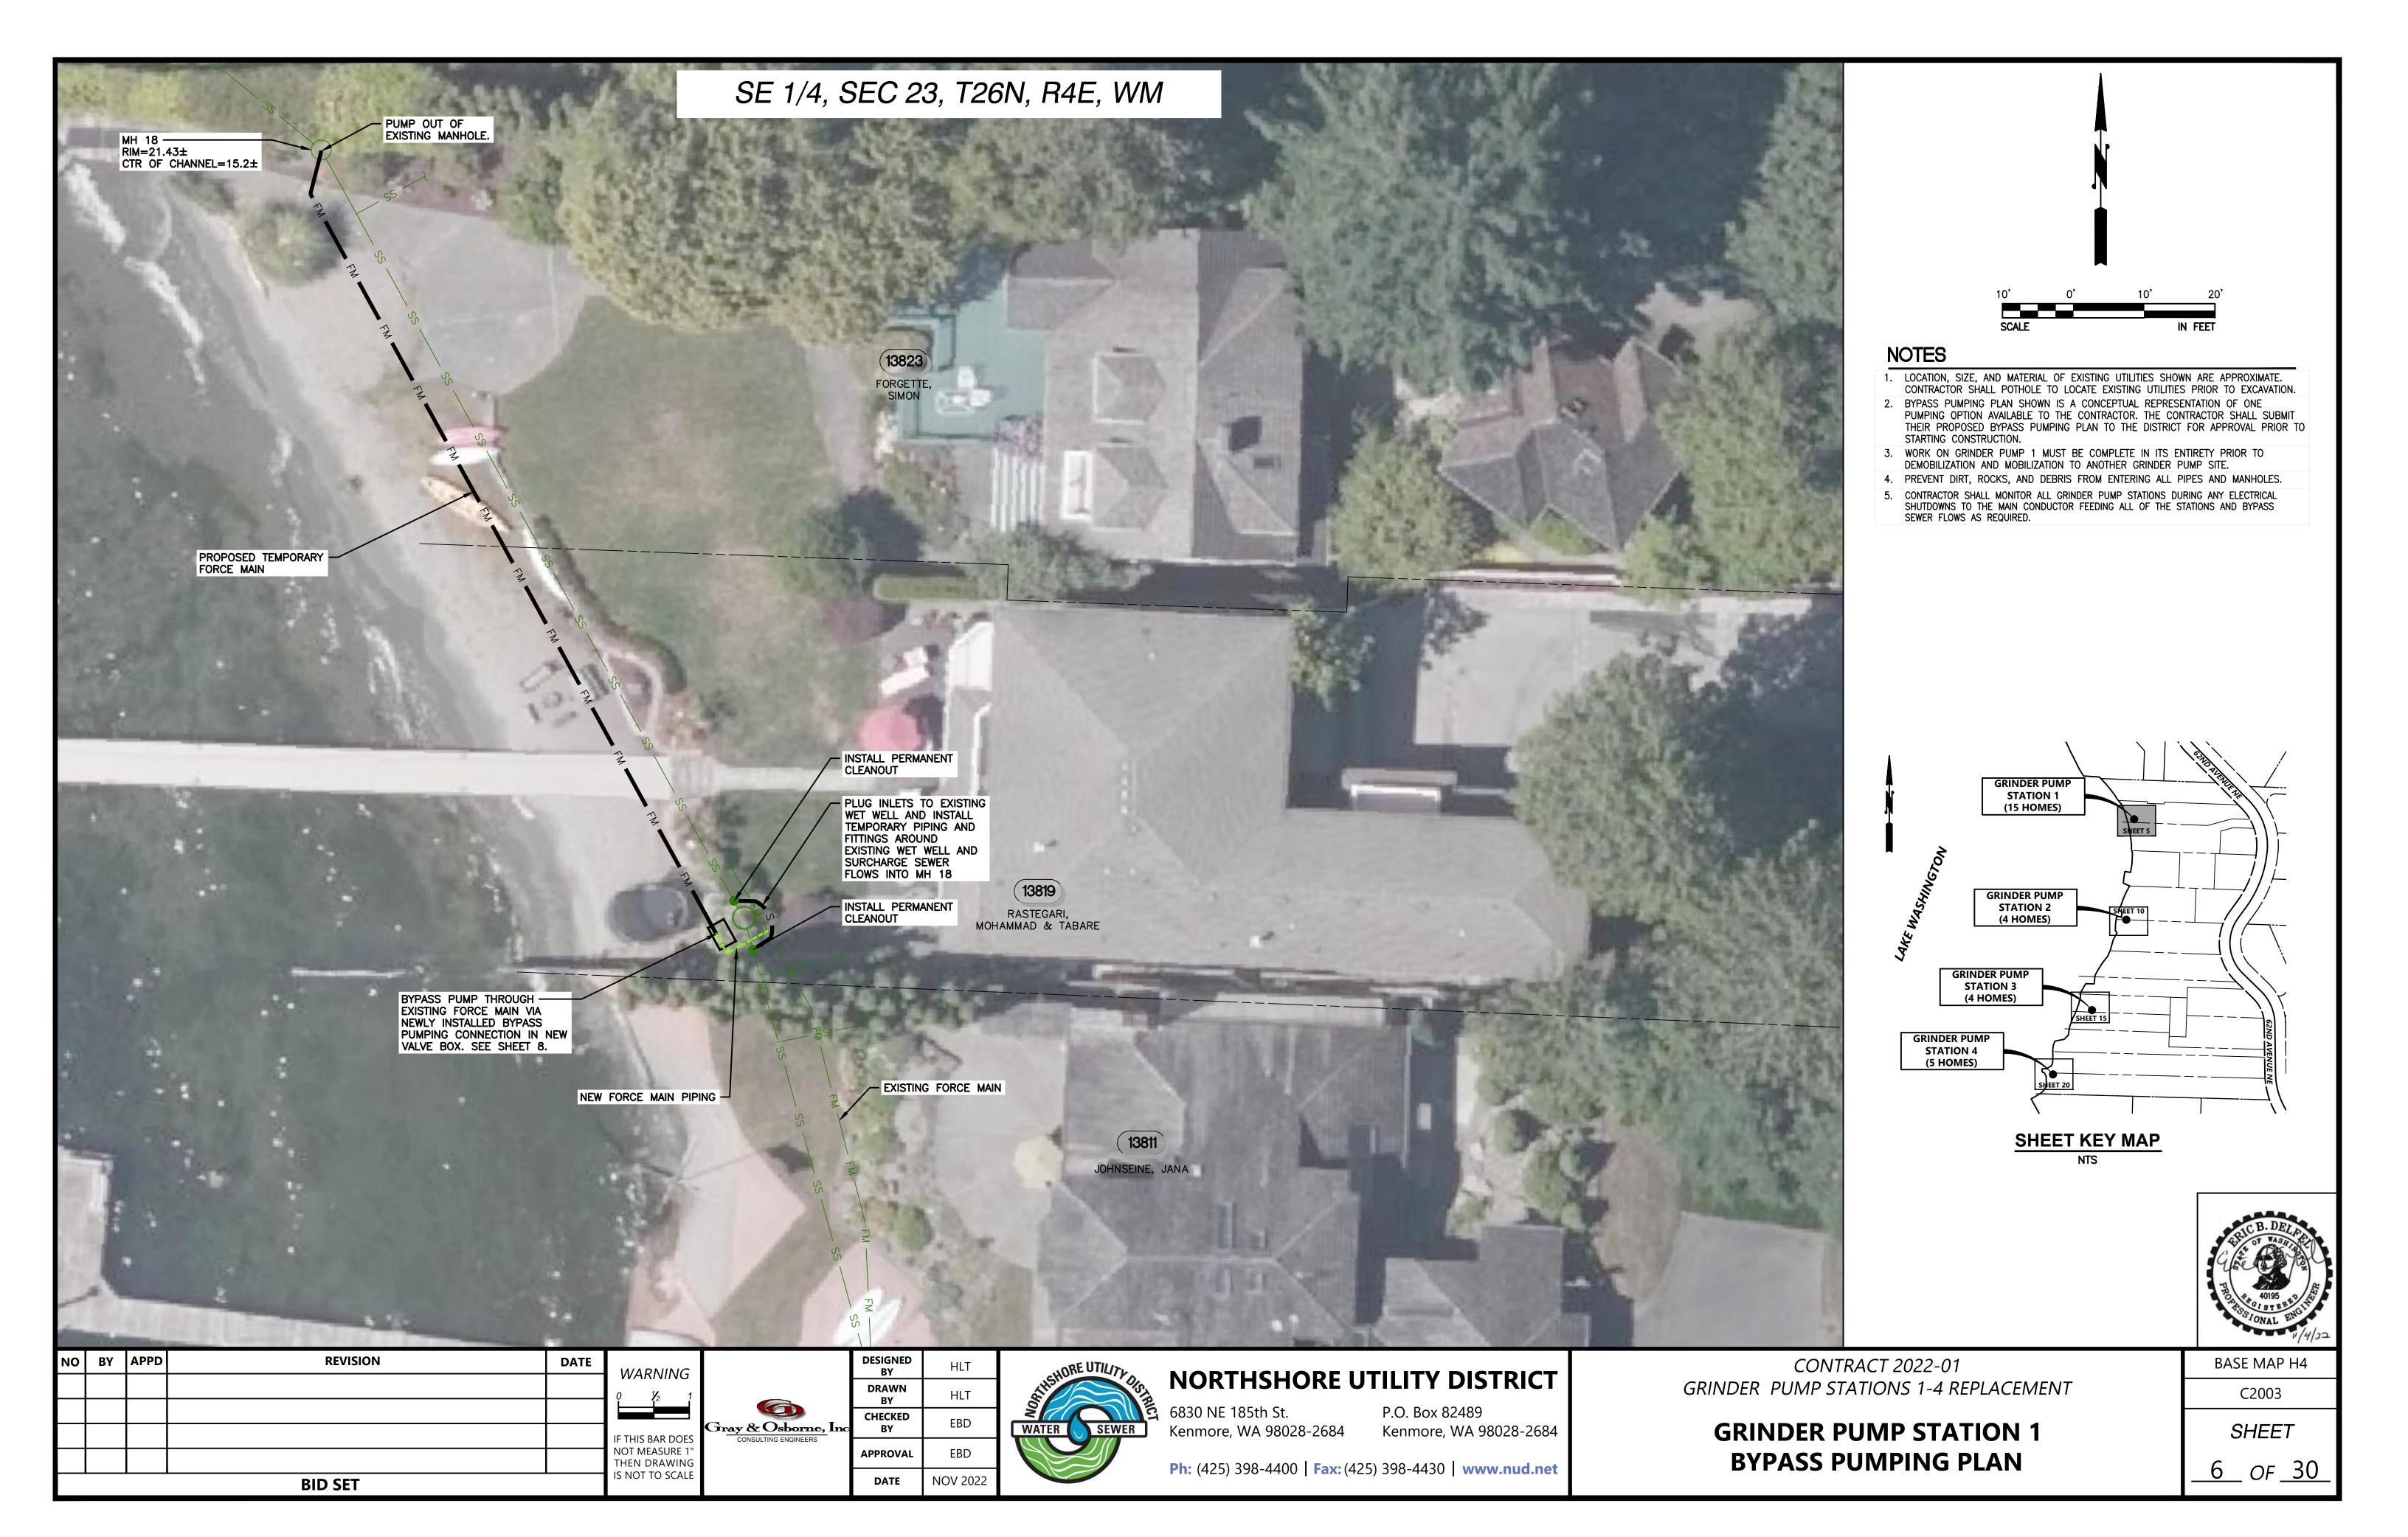

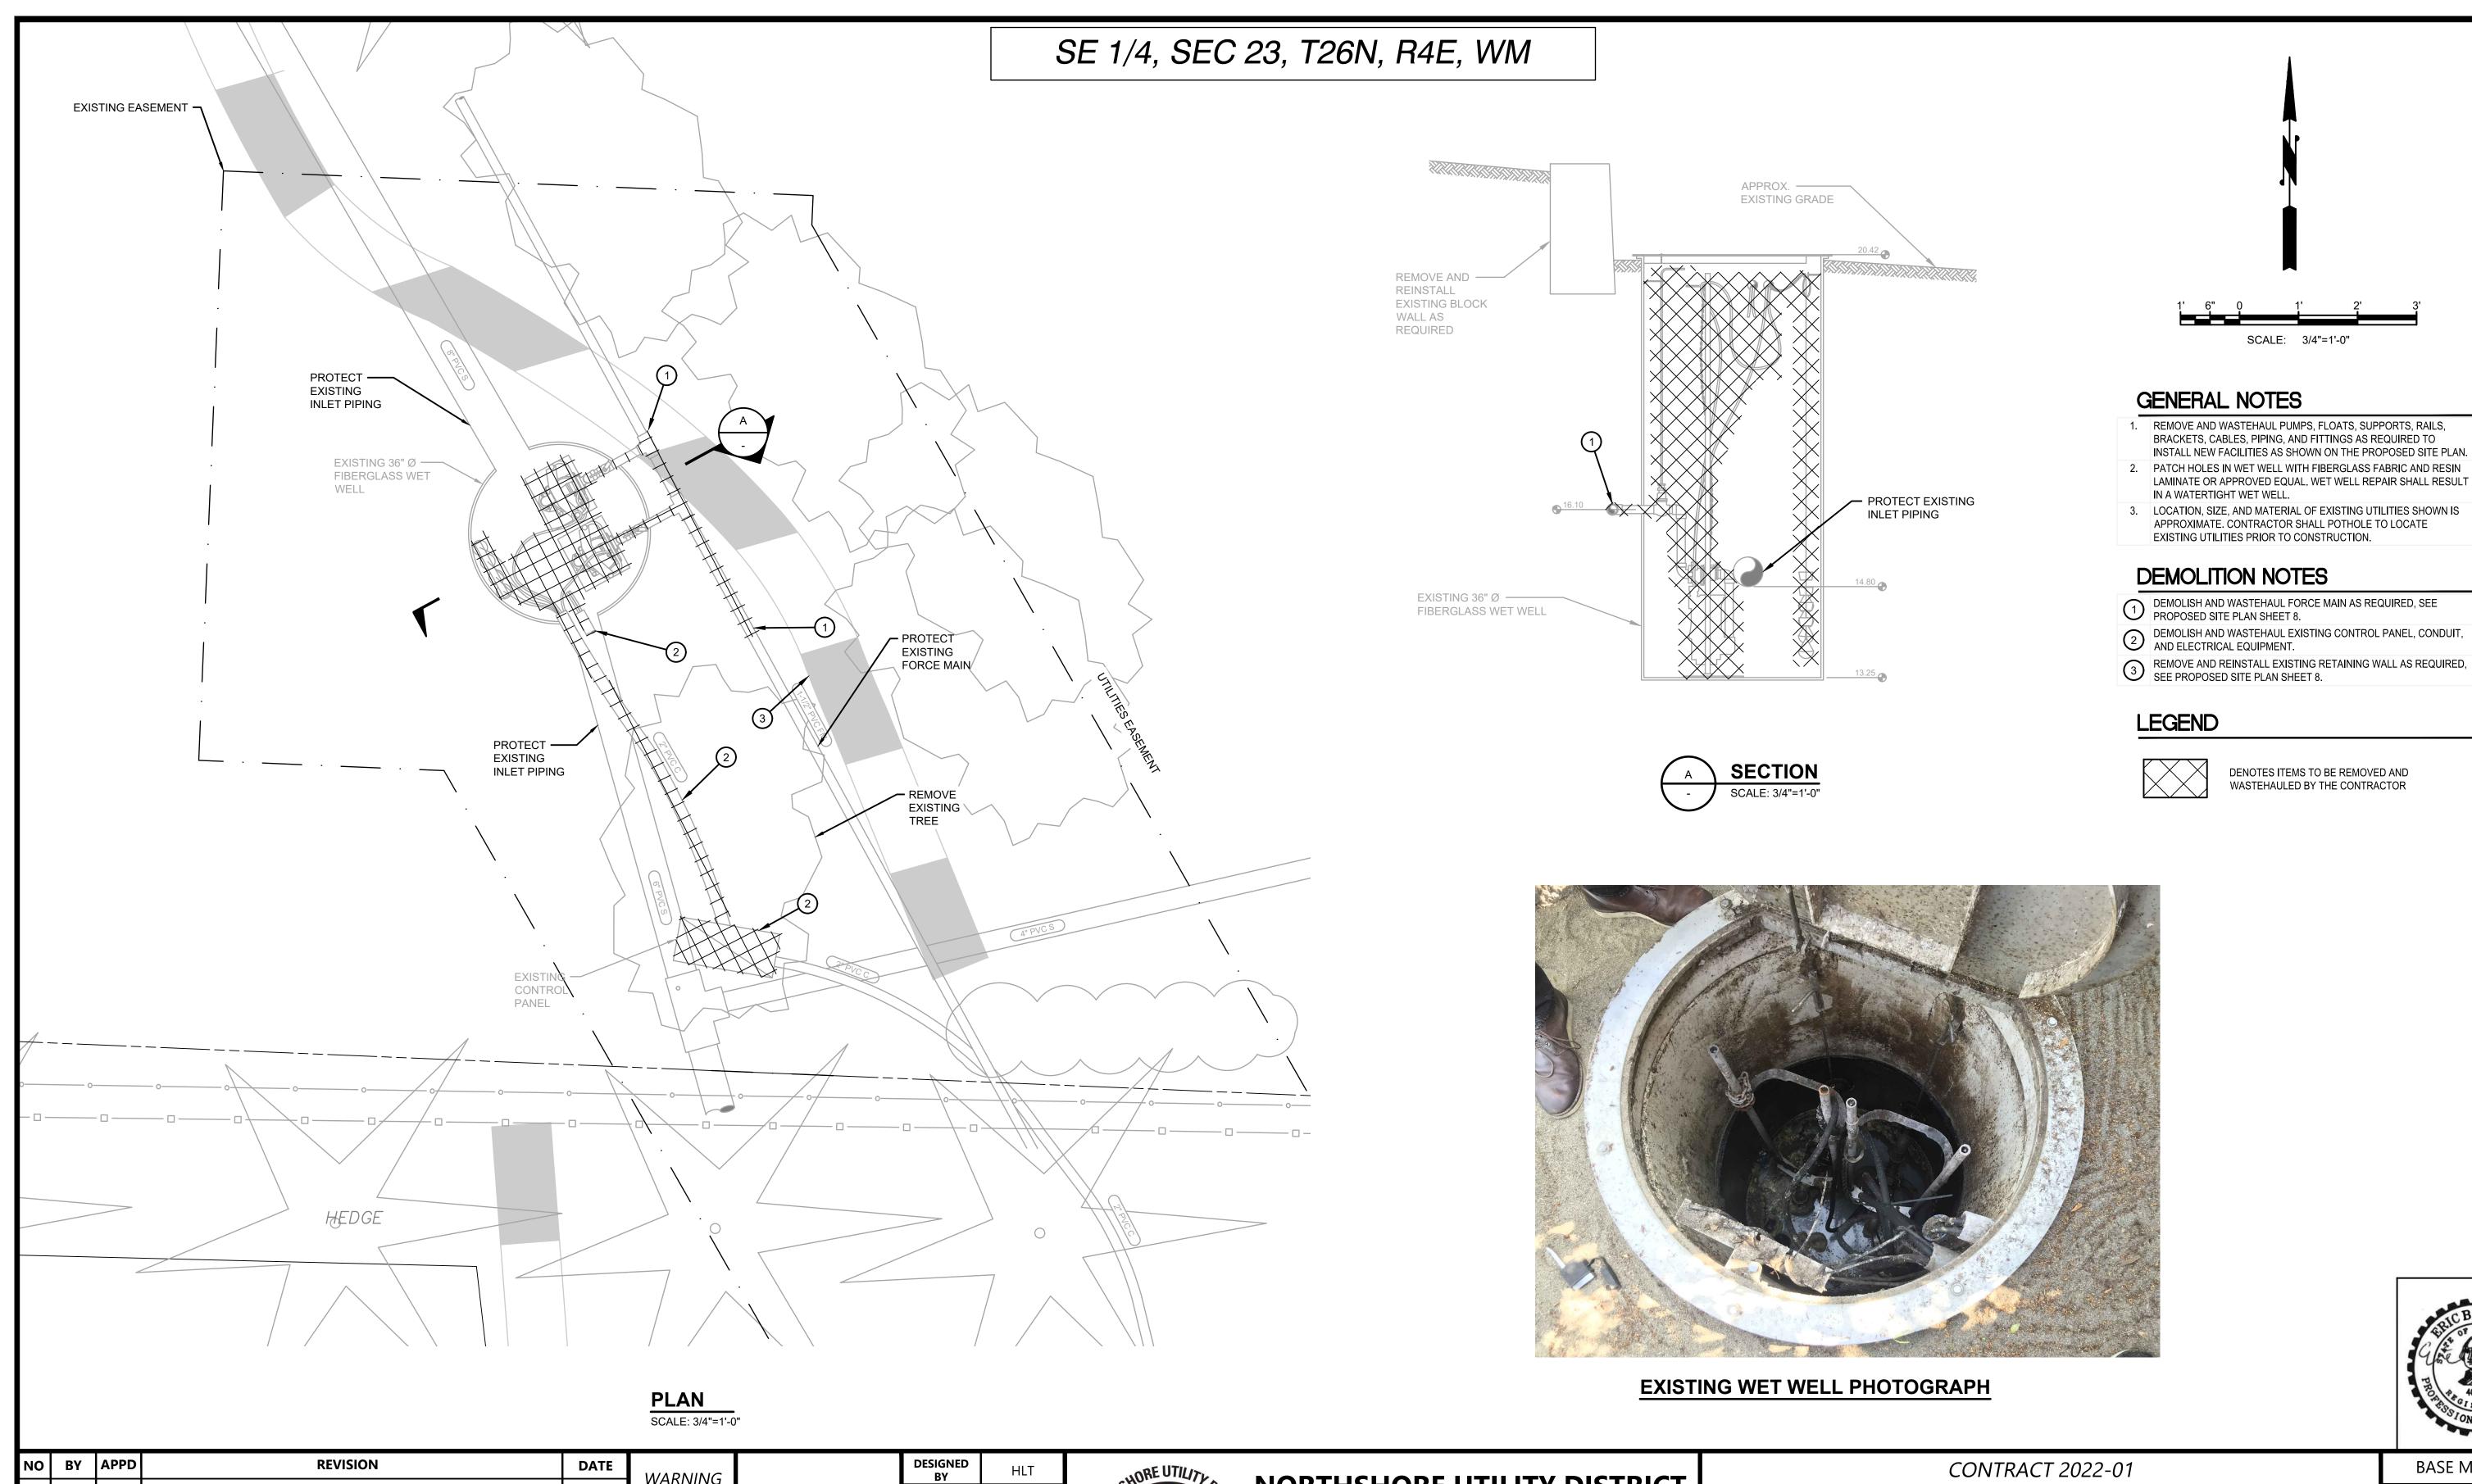

WARNING

IF THIS BAR DOES NOT MEASURE 1" THEN DRAWING IS NOT TO SCALE

**BID SET** 

DRAWN

CHECKED

DATE

NOV 2022

Gray & Osborne, Inc



Kenmore, WA 98028-2684 Kenmore, WA 98028-2684

Ph: (425) 398-4400 | Fax: (425) 398-4430 | www.nud.net

**CONTRACT 2022-01** GRINDER PUMP STATIONS 1-4 REPLACEMENT


**GRINDER PUMP STATION 1 DEMOLITION** 

ONAL ENGIN
BASE MAP H4

C2003

SHEET

7 OF <u>30</u>

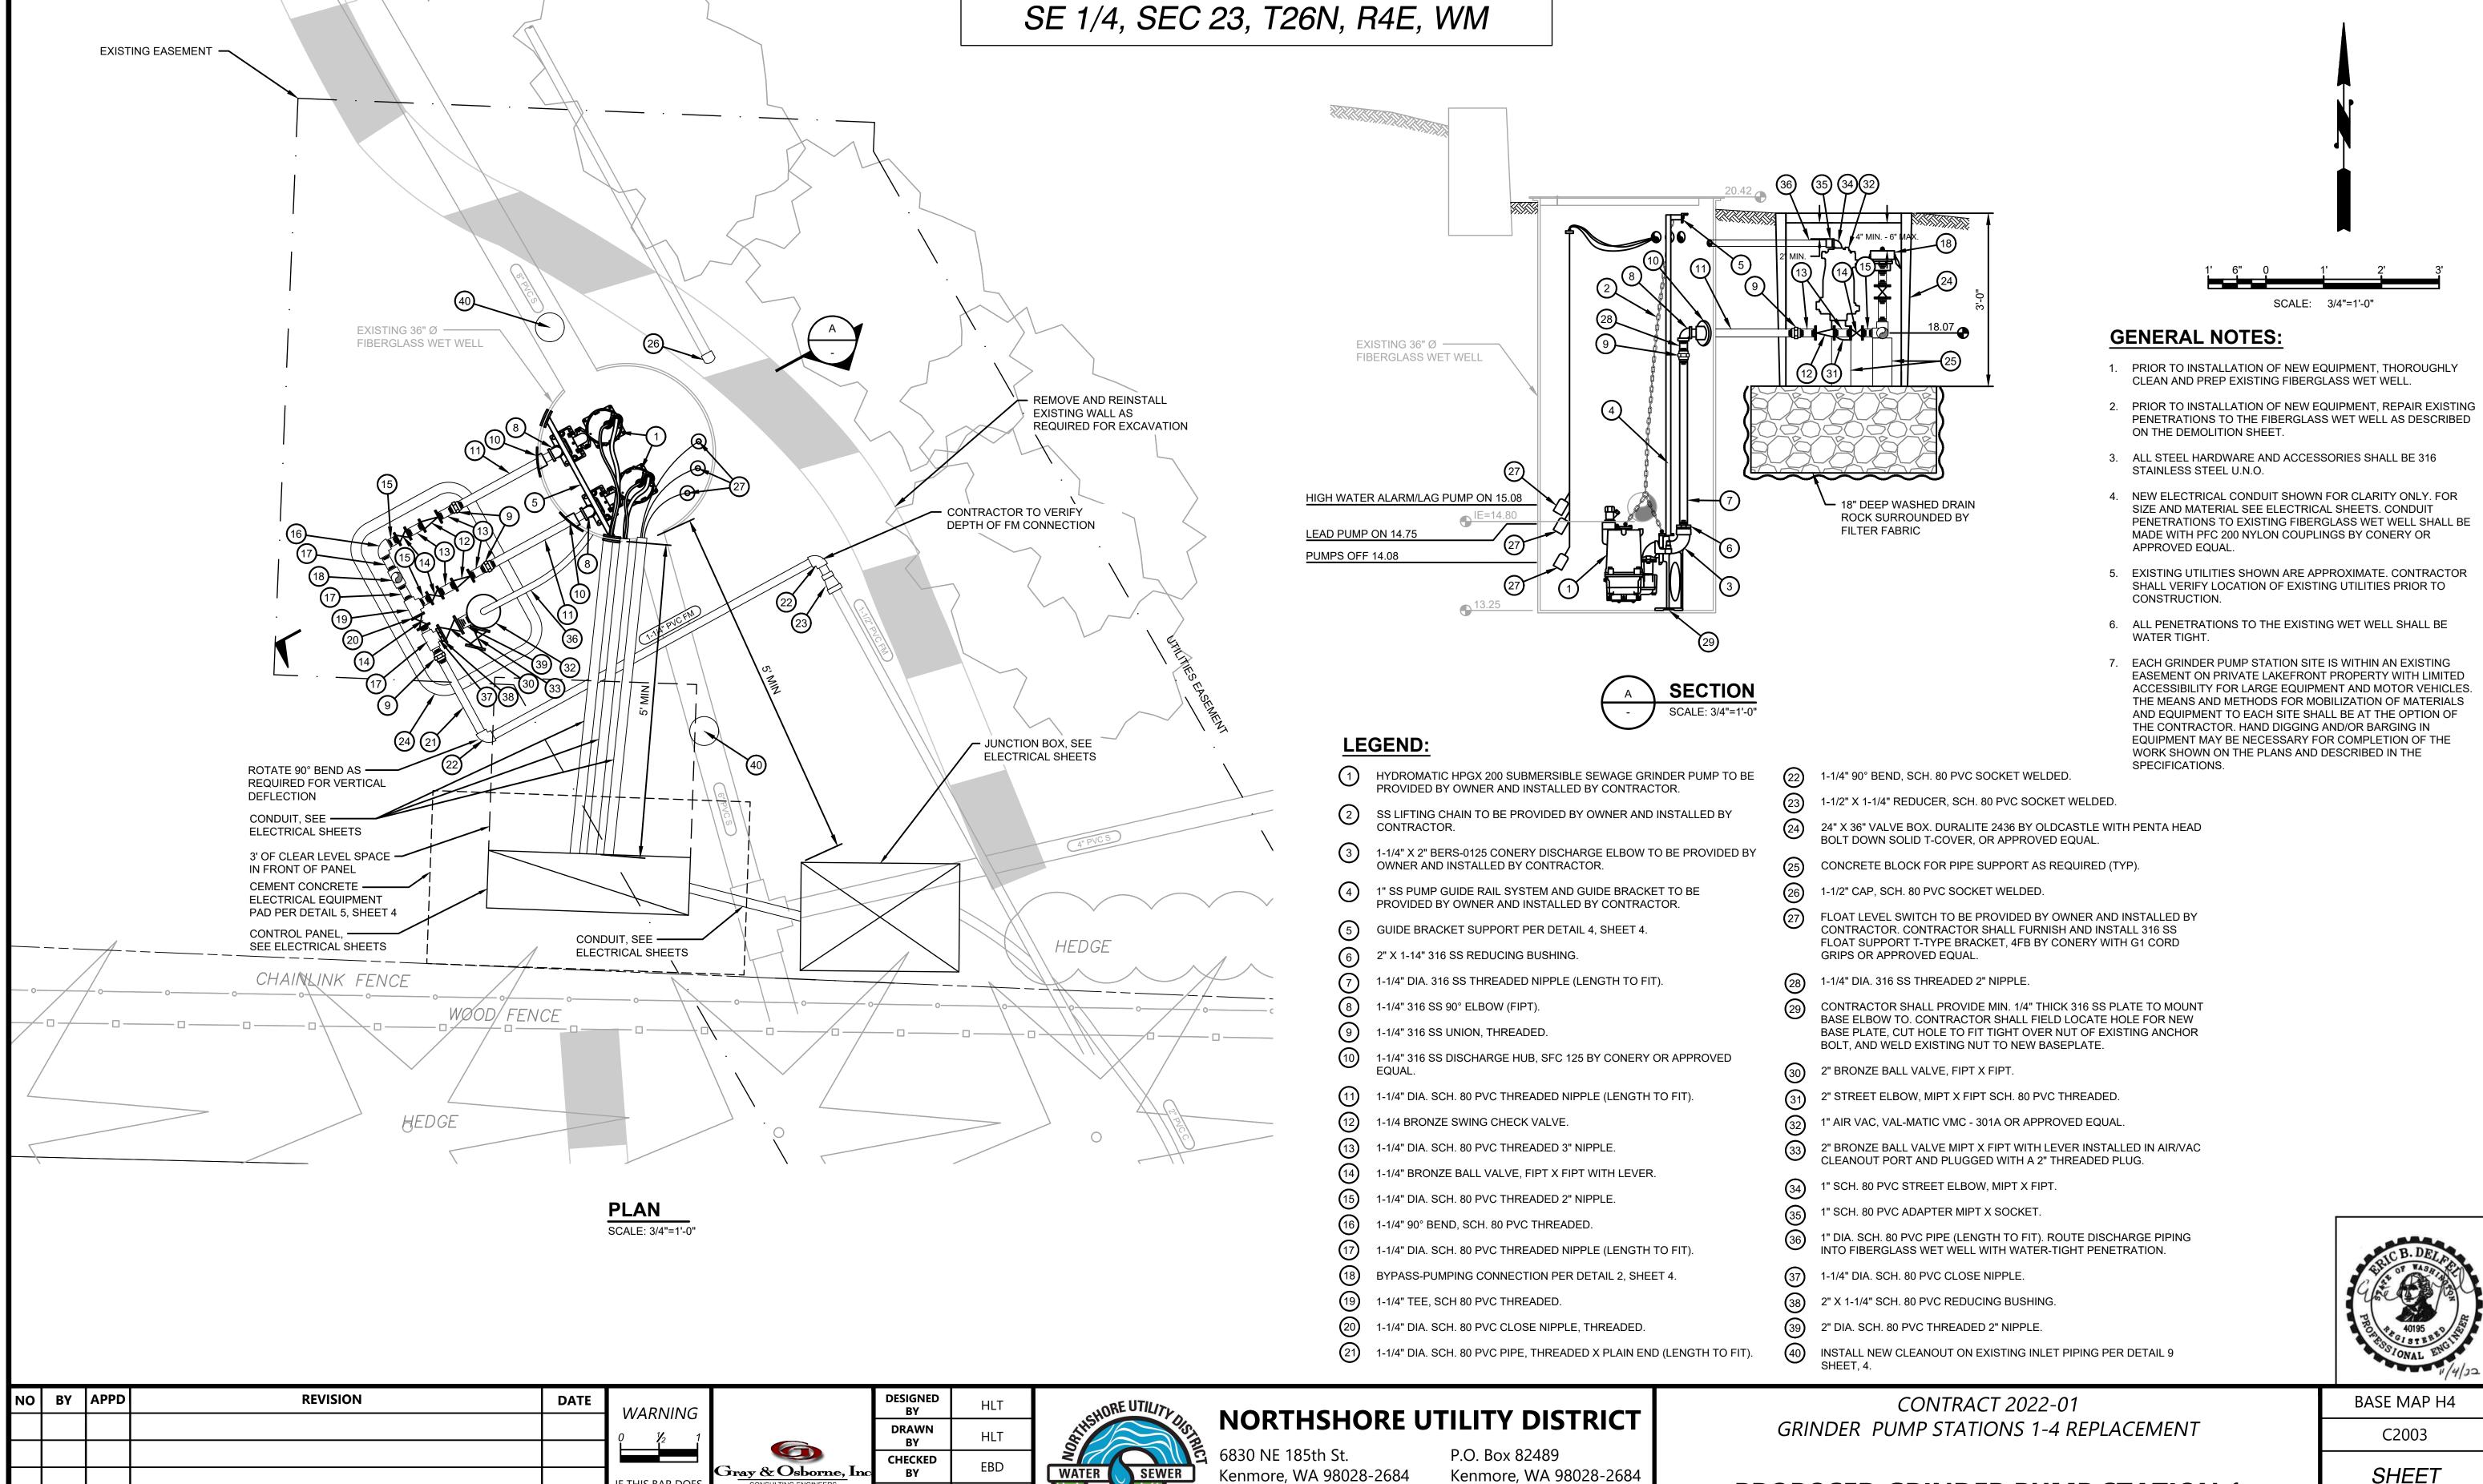

Ph: (425) 398-4400 | Fax: (425) 398-4430 | www.nud.net

F THIS BAR DOES

APPROVAL

DATE

NOV 2022

NOT MEASURE 1

THEN DRAWING


IS NOT TO SCALE


**BID SET** 

PROPOSED GRINDER PUMP STATION 1

SHEET

<u>8</u> of <u>30</u>

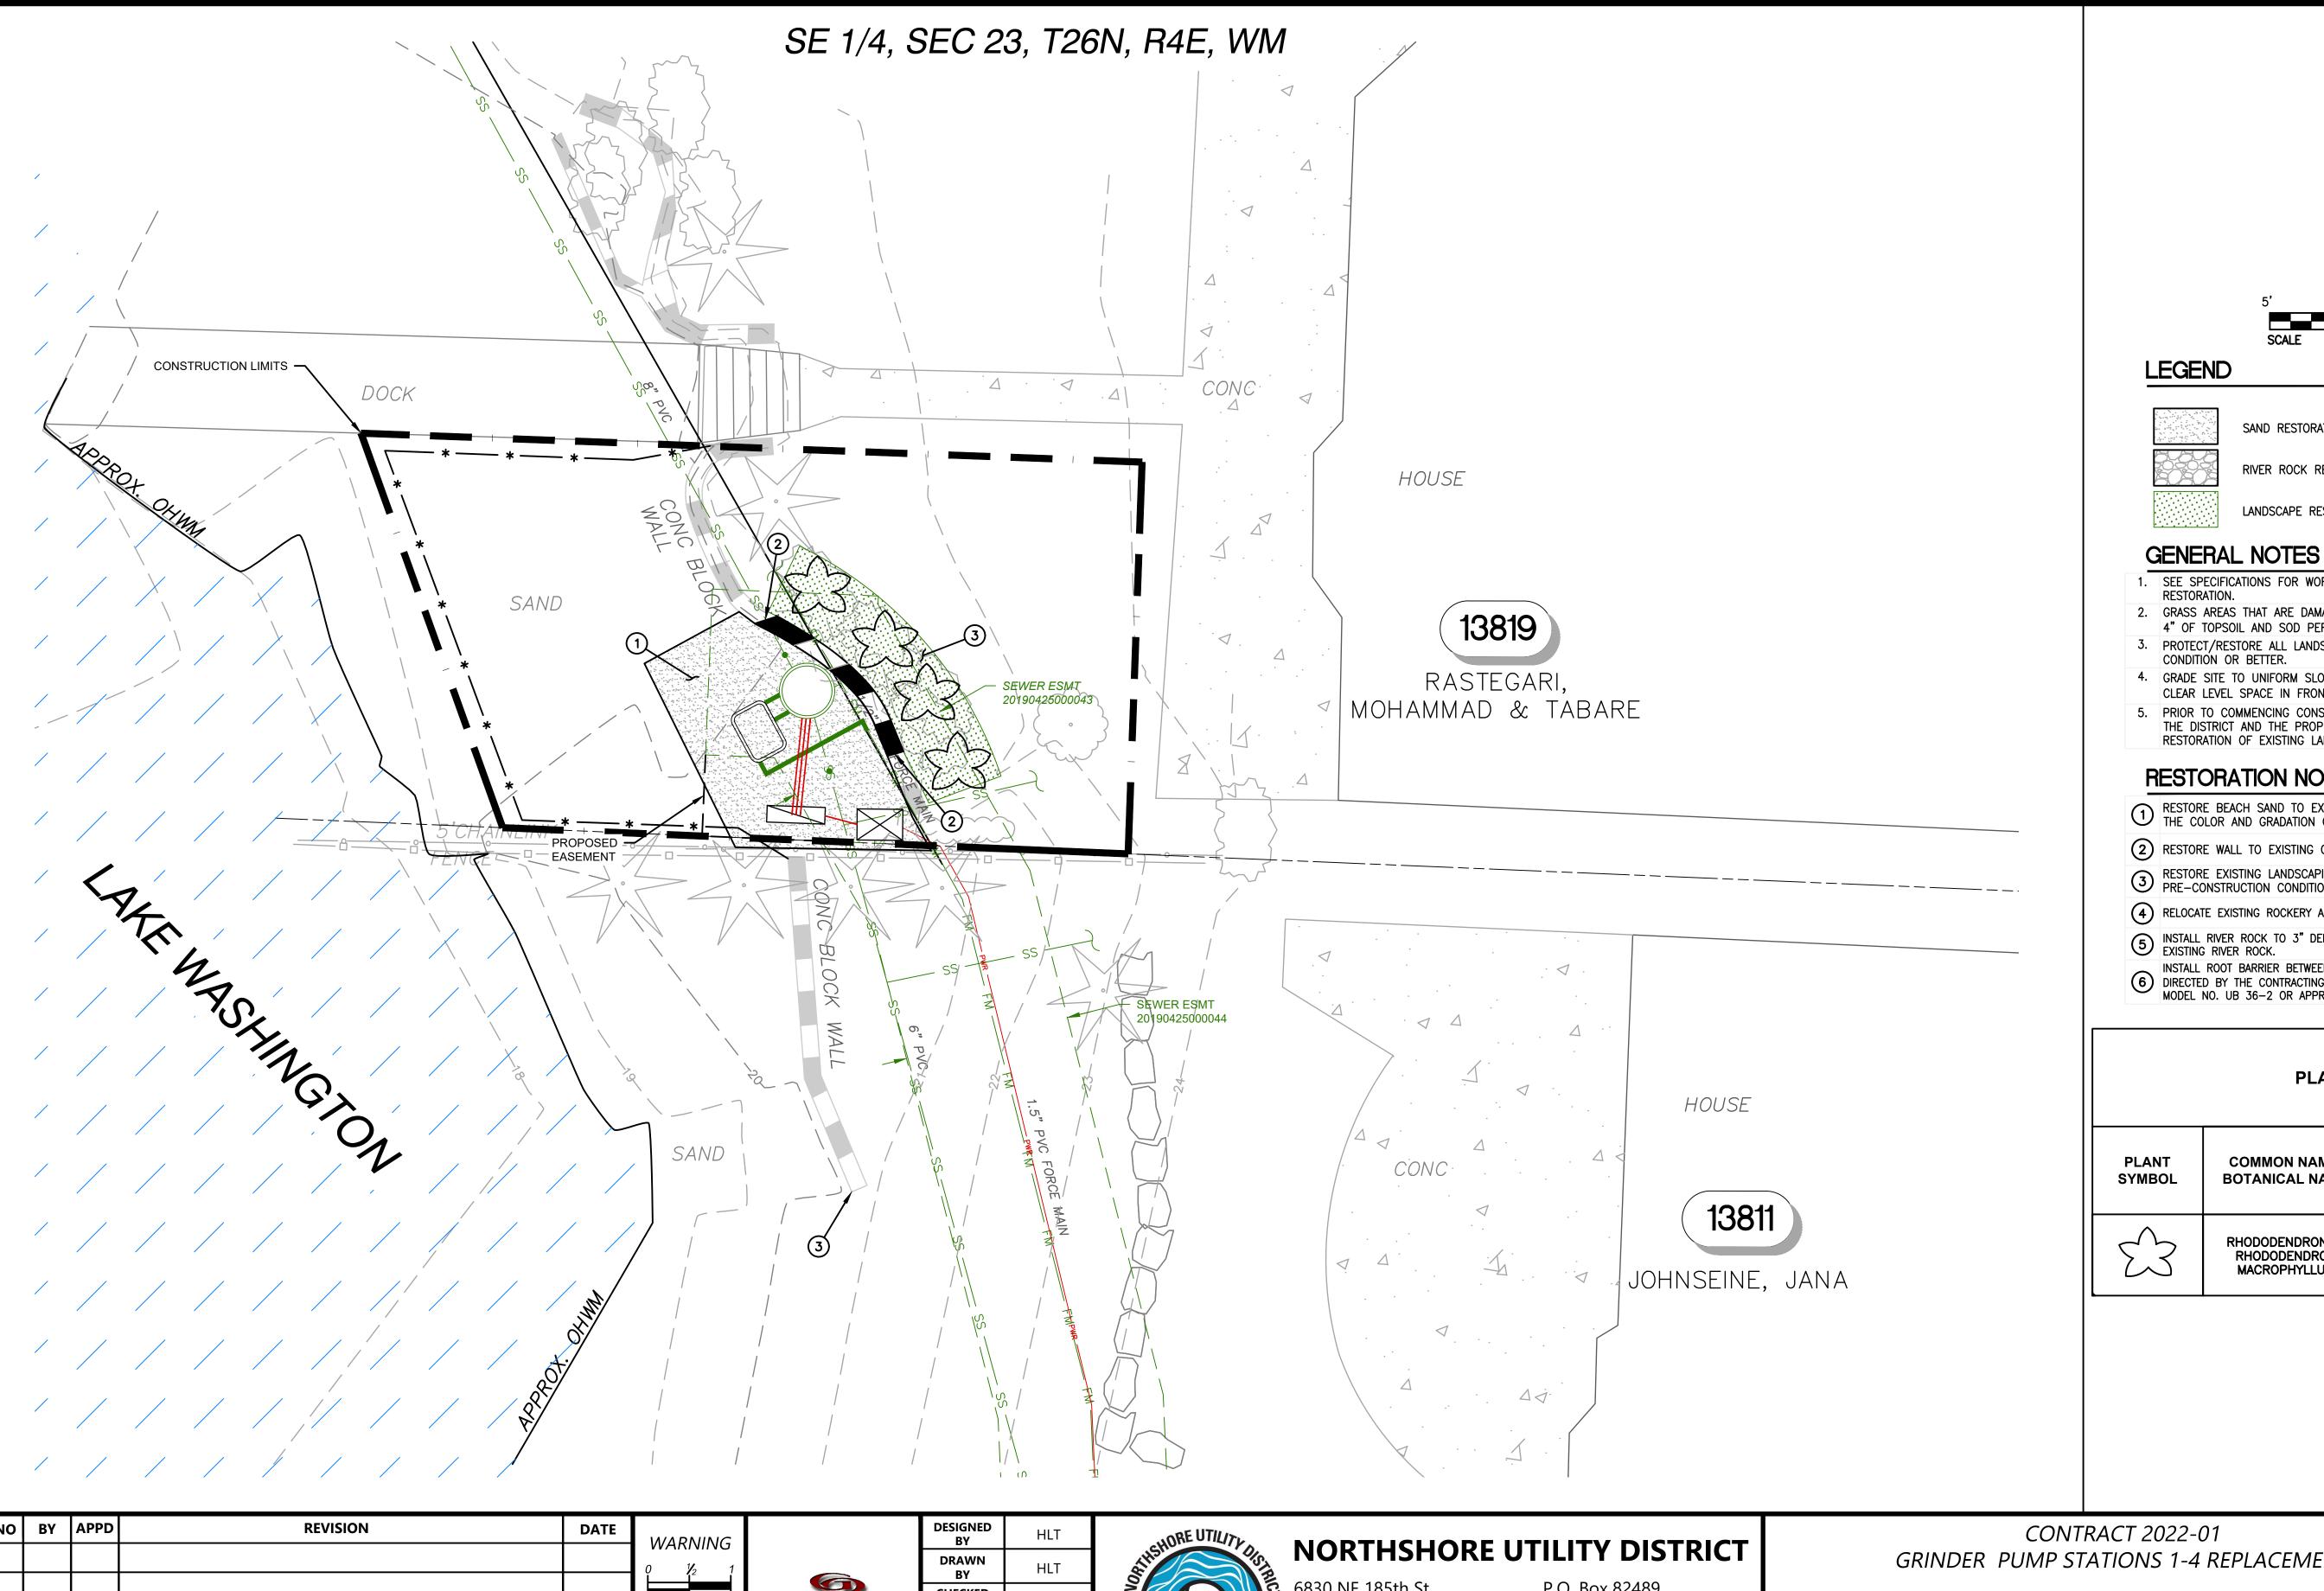

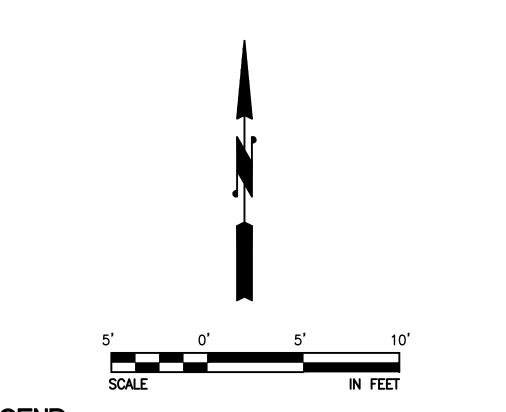

#### **LEGEND**



SAND RESTORATION



RIVER ROCK REPAIR

LANDSCAPE RESTORATION

- 1. SEE SPECIFICATIONS FOR WORK AND PAYMENT INCLUDED IN GENERAL
- 2. GRASS AREAS THAT ARE DAMAGED BY THE CONTRACTOR SHALL BE RESTORED WITH 4" OF TOPSOIL AND SOD PER THE SPECIFICATIONS.
- 3. PROTECT/RESTORE ALL LANDSCAPING AND SURFACE FEATURES TO EXISTING
- 4. GRADE SITE TO UNIFORM SLOPE AROUND NEW UTILITY BOXES. PROVIDE 30" OF CLEAR LEVEL SPACE IN FRONT OF NEW CONTROL PANNEL(S).
- PRIOR TO COMMENCING CONSTRUCTION, THE CONTRACTOR SHALL COORDINATE WITH THE DISTRICT AND THE PROPERTY OWNERS REGARDING THE REMOVAL AND


### RESTORATION NOTES

RESTORATION OF EXISTING LANDSCAPE FEATURES.

- RESTORE BEACH SAND TO EXISTING CONDITION. ANY IMPORTED SAND SHALL MATCH THE COLOR AND GRADATION OF THE EXISTING SAND.
- RESTORE WALL TO EXISTING CONDITION.
- RESTORE EXISTING LANDSCAPING, TOPSOIL, AND SOD AS APPLICABLE TO PRE-CONSTRUCTION CONDITIONS, OR BETTER.
- RELOCATE EXISTING ROCKERY AS SHOWN TO ACCOMMODATE NEW FACILITIES.
- 5 INSTALL RIVER ROCK TO 3" DEPTH. ANY IMPORTED MATERIAL SHALL MATCH THE EXISTING RIVER ROCK.
- 6 DIRECTED BY THE CONTRACTING AGENCY. ROOT BARRIERS SHALL BE "DEEP ROOT" MODEL NO. UB 36-2 OR APPROVED EQUAL.

#### **PLANT SCHEDULE**

PLANT SYMBOL	COMMON NAME/ BOTANICAL NAME	MINIMUM SIZE	NO. OF PLANTS
$\mathcal{L}_{3}$	RHODODENDRON / RHODODENDRON MACROPHYLLUM	5 GAL	4

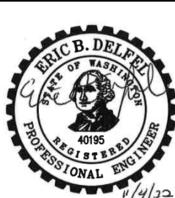

NO	ВҮ	APPD	REVISION	DATE	WARNING
					WARNING
					IF THIS BAR DOES
					NOT MEASURE 1" THEN DRAWING
			DID CET		IS NOT TO SCALE

**BID SET** 







6830 NE 185th St. Kenmore, WA 98028-2684 P.O. Box 82489 Kenmore, WA 98028-2684

Ph: (425) 398-4400 | Fax: (425) 398-4430 | www.nud.net


**CONTRACT 2022-01** GRINDER PUMP STATIONS 1-4 REPLACEMENT


**GRINDER PUMP STATION 1 RESTORATION PLAN** 

BASE MAP H4 C2003

SHEET

9 OF <u>30</u>

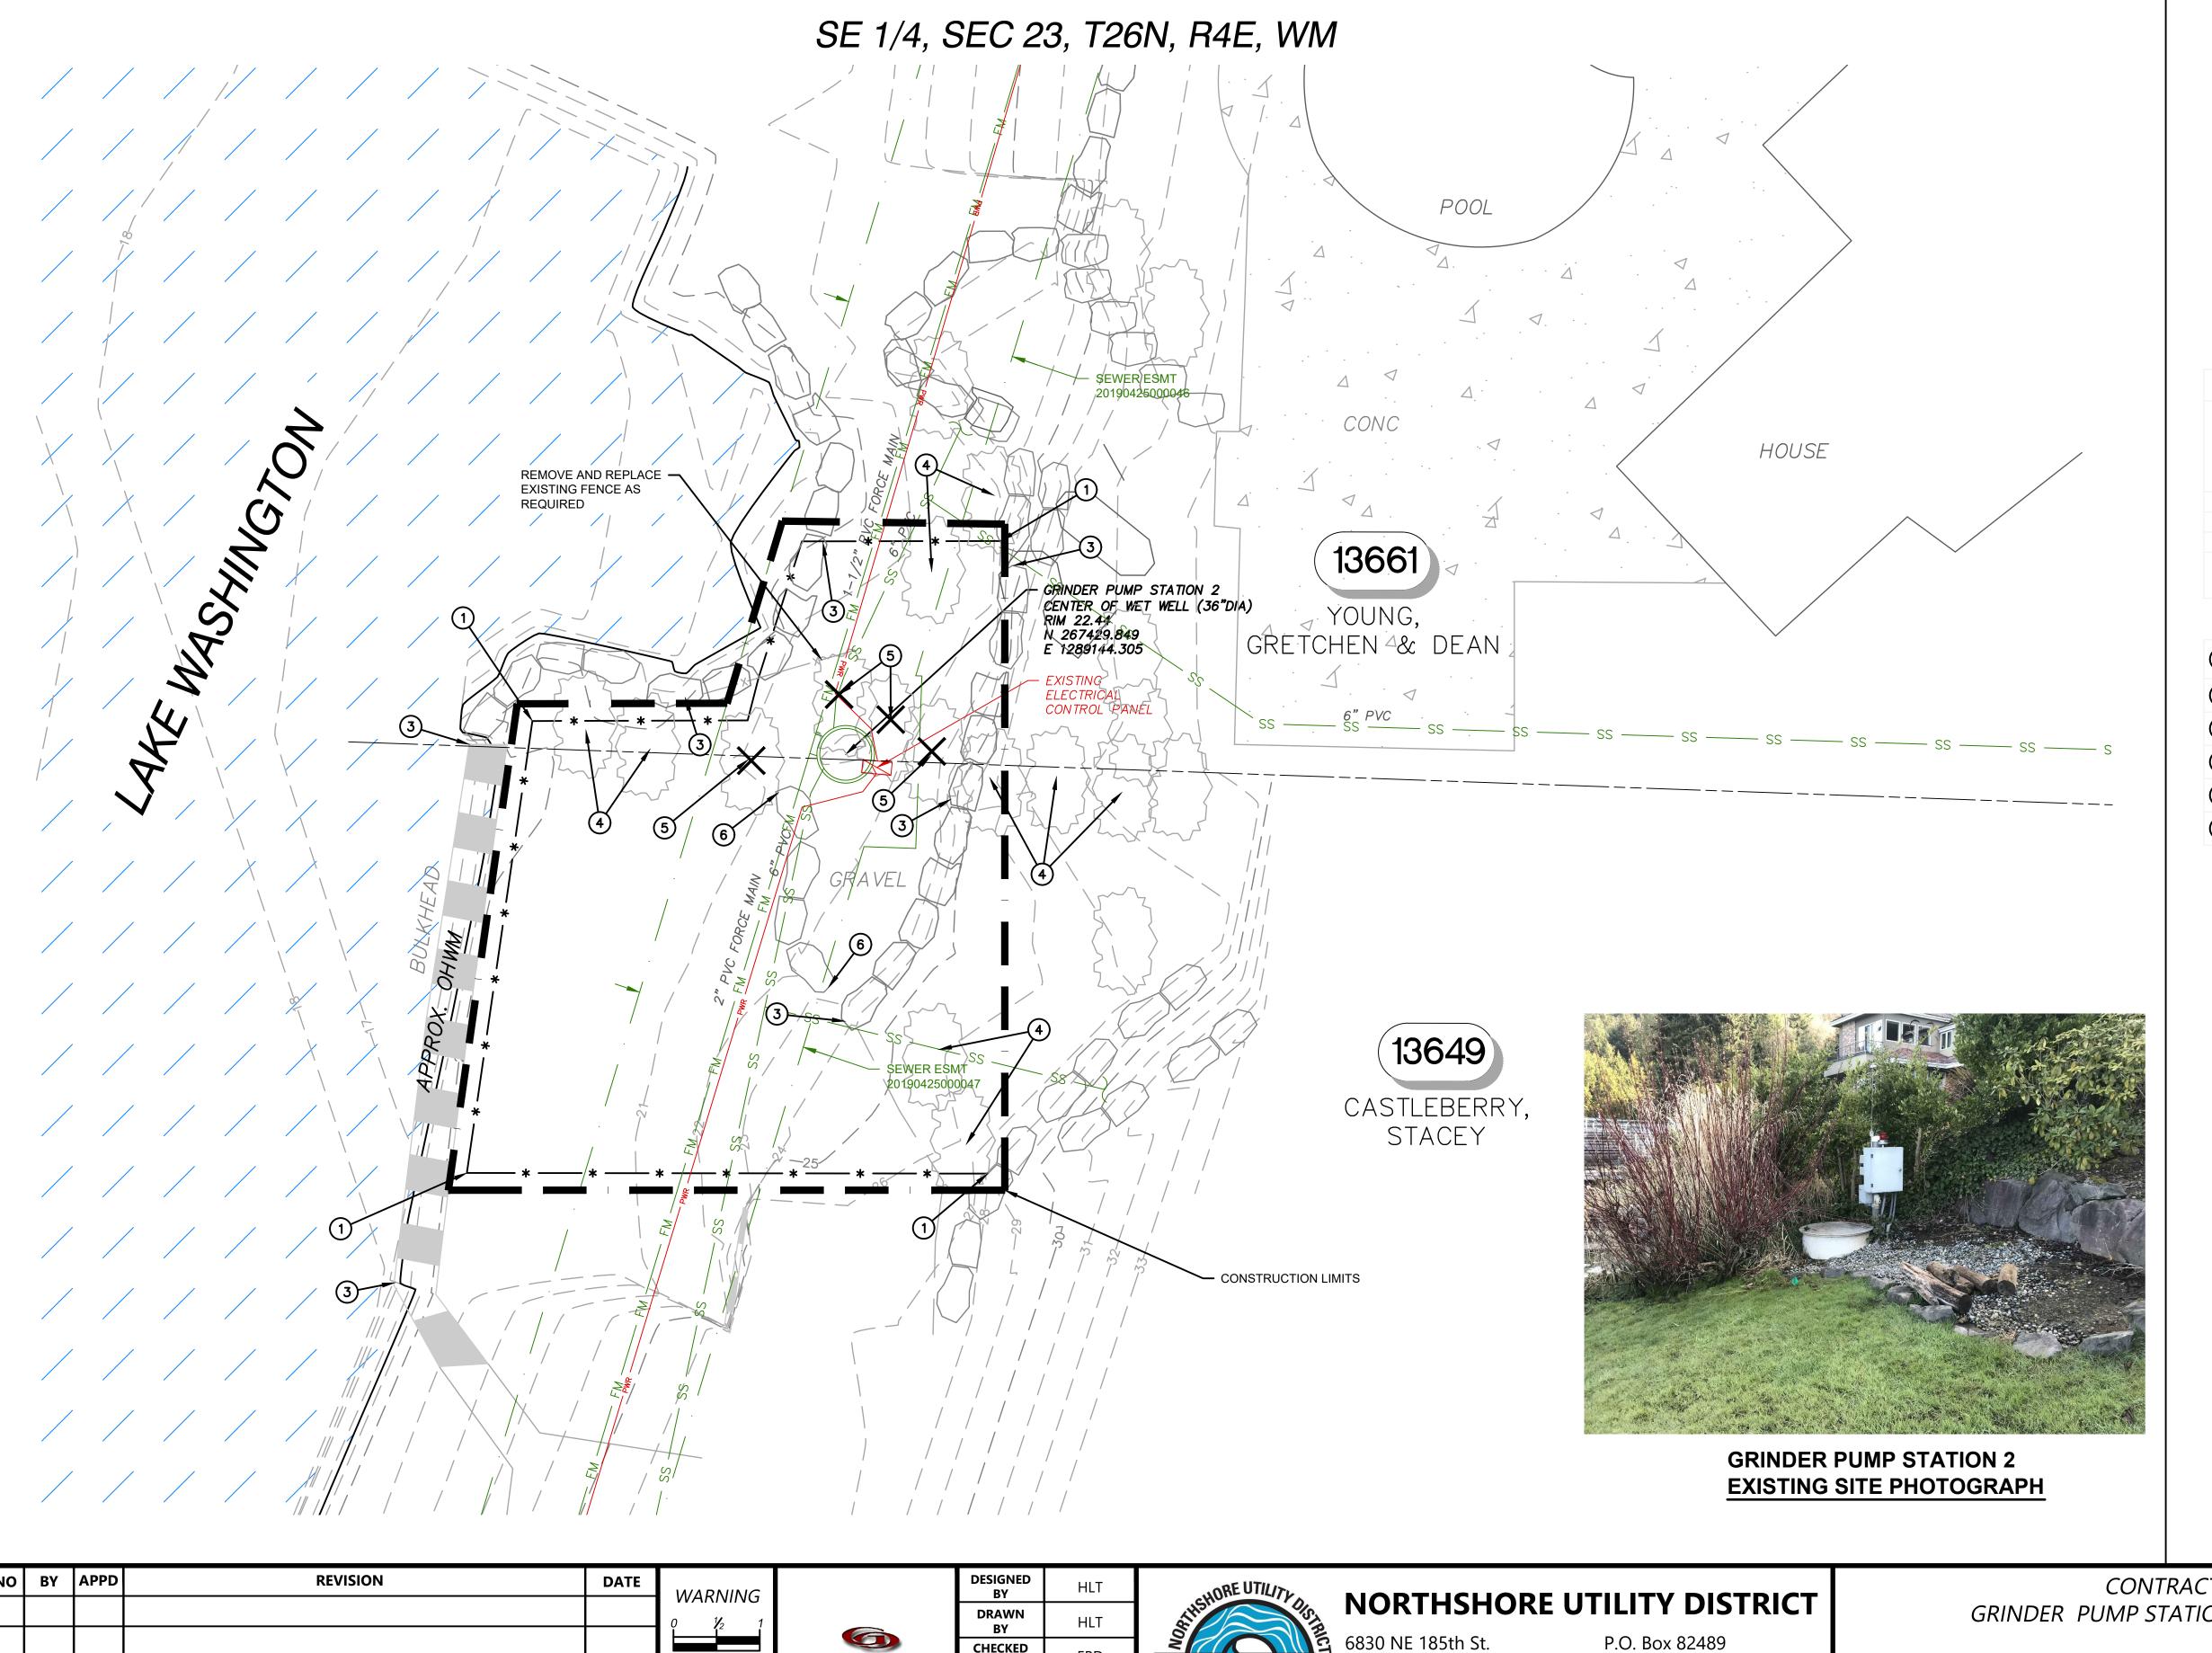


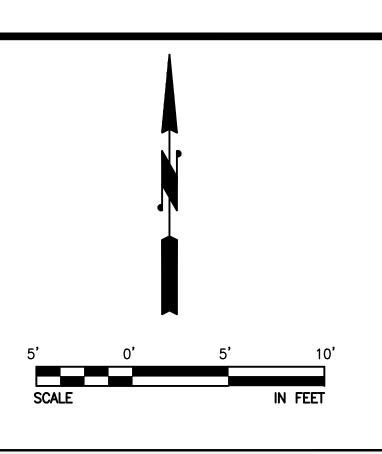

- 1. LOCATION, SIZE, AND MATERIAL OF EXISTING UTILITIES SHOWN ARE APPROXIMATE. CONTRACTOR SHALL POTHOLE TO LOCATE EXISTING UTILITIES PRIOR TO EXCAVATION.
- MOTOR VEHICLES. THE MEANS AND METHODS FOR MOBILIZATION OF MATERIALS AND EQUIPMENT TO EACH SITE SHALL BE AT THE OPTION OF THE CONTRACTOR. HAND DIGGING AND/OR BARGING IN EQUIPMENT MAY BE NECESSARY FOR COMPLETION OF THE WORK SHOWN ON THE PLANS AND DESCRIBED IN THE SPECIFICATIONS
- 3. INSTALL TESC FACILITIES PER SHEET 3.
- 4. SEE EROSION CONTROL NOTES SHEET 3.
- 5. PROTECT ALL TREES AND HEDGES, UNLESS OTHERWISE NOTED ON PLANS.
- 6. PRIOR TO COMMENCING CONSTRUCTION, THE CONTRACTOR SHALL COORDINATE WITH THE DISTRICT AND THE PROPERTY OWNERS REGARDING THE REMOVAL AND RESTORATION OF EXISTING LANDSCAPE FEATURES.

#### CONSTRUCTION NOTES

- 1) INSTALL FILTER FABRIC FENCE PER DETAIL, SHEET 3.
- 2 PROTECT EXISTING FENCE.
- 3 PROTECT EXISTING WALL/ROCKERY.
- 4 PROTECT EXISTING TREE/SHRUB.
- (5) REMOVE EXISTING TREE/SHRUB.
- (6) REMOVE EXISTING ROCKERY.

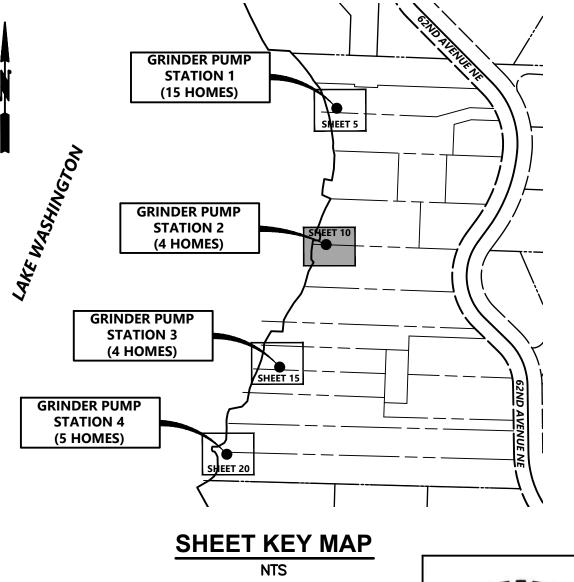


NO	ВҮ	APPD	REVISION	DATE	WARNING
					0 % 1
					IF THIS BAR DOES
					NOT MEASURE 1" THEN DRAWING

**BID SET** 

Gr<u>ay & Osborne,</u> In IS NOT TO SCALE

CHECKED DATE NOV 2022

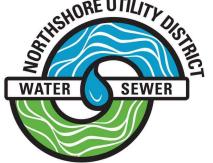

6830 NE 185th St. Kenmore, WA 98028-2684 Kenmore, WA 98028-2684


Ph: (425) 398-4400 | Fax: (425) 398-4430 | www.nud.net


**CONTRACT 2022-01** GRINDER PUMP STATIONS 1-4 REPLACEMENT

**GRINDER PUMP STATION 2 EXISTING SITE & TESC PLAN**  BASE MAP H4 C2003

SHEET

<u>10</u> of <u>30</u>

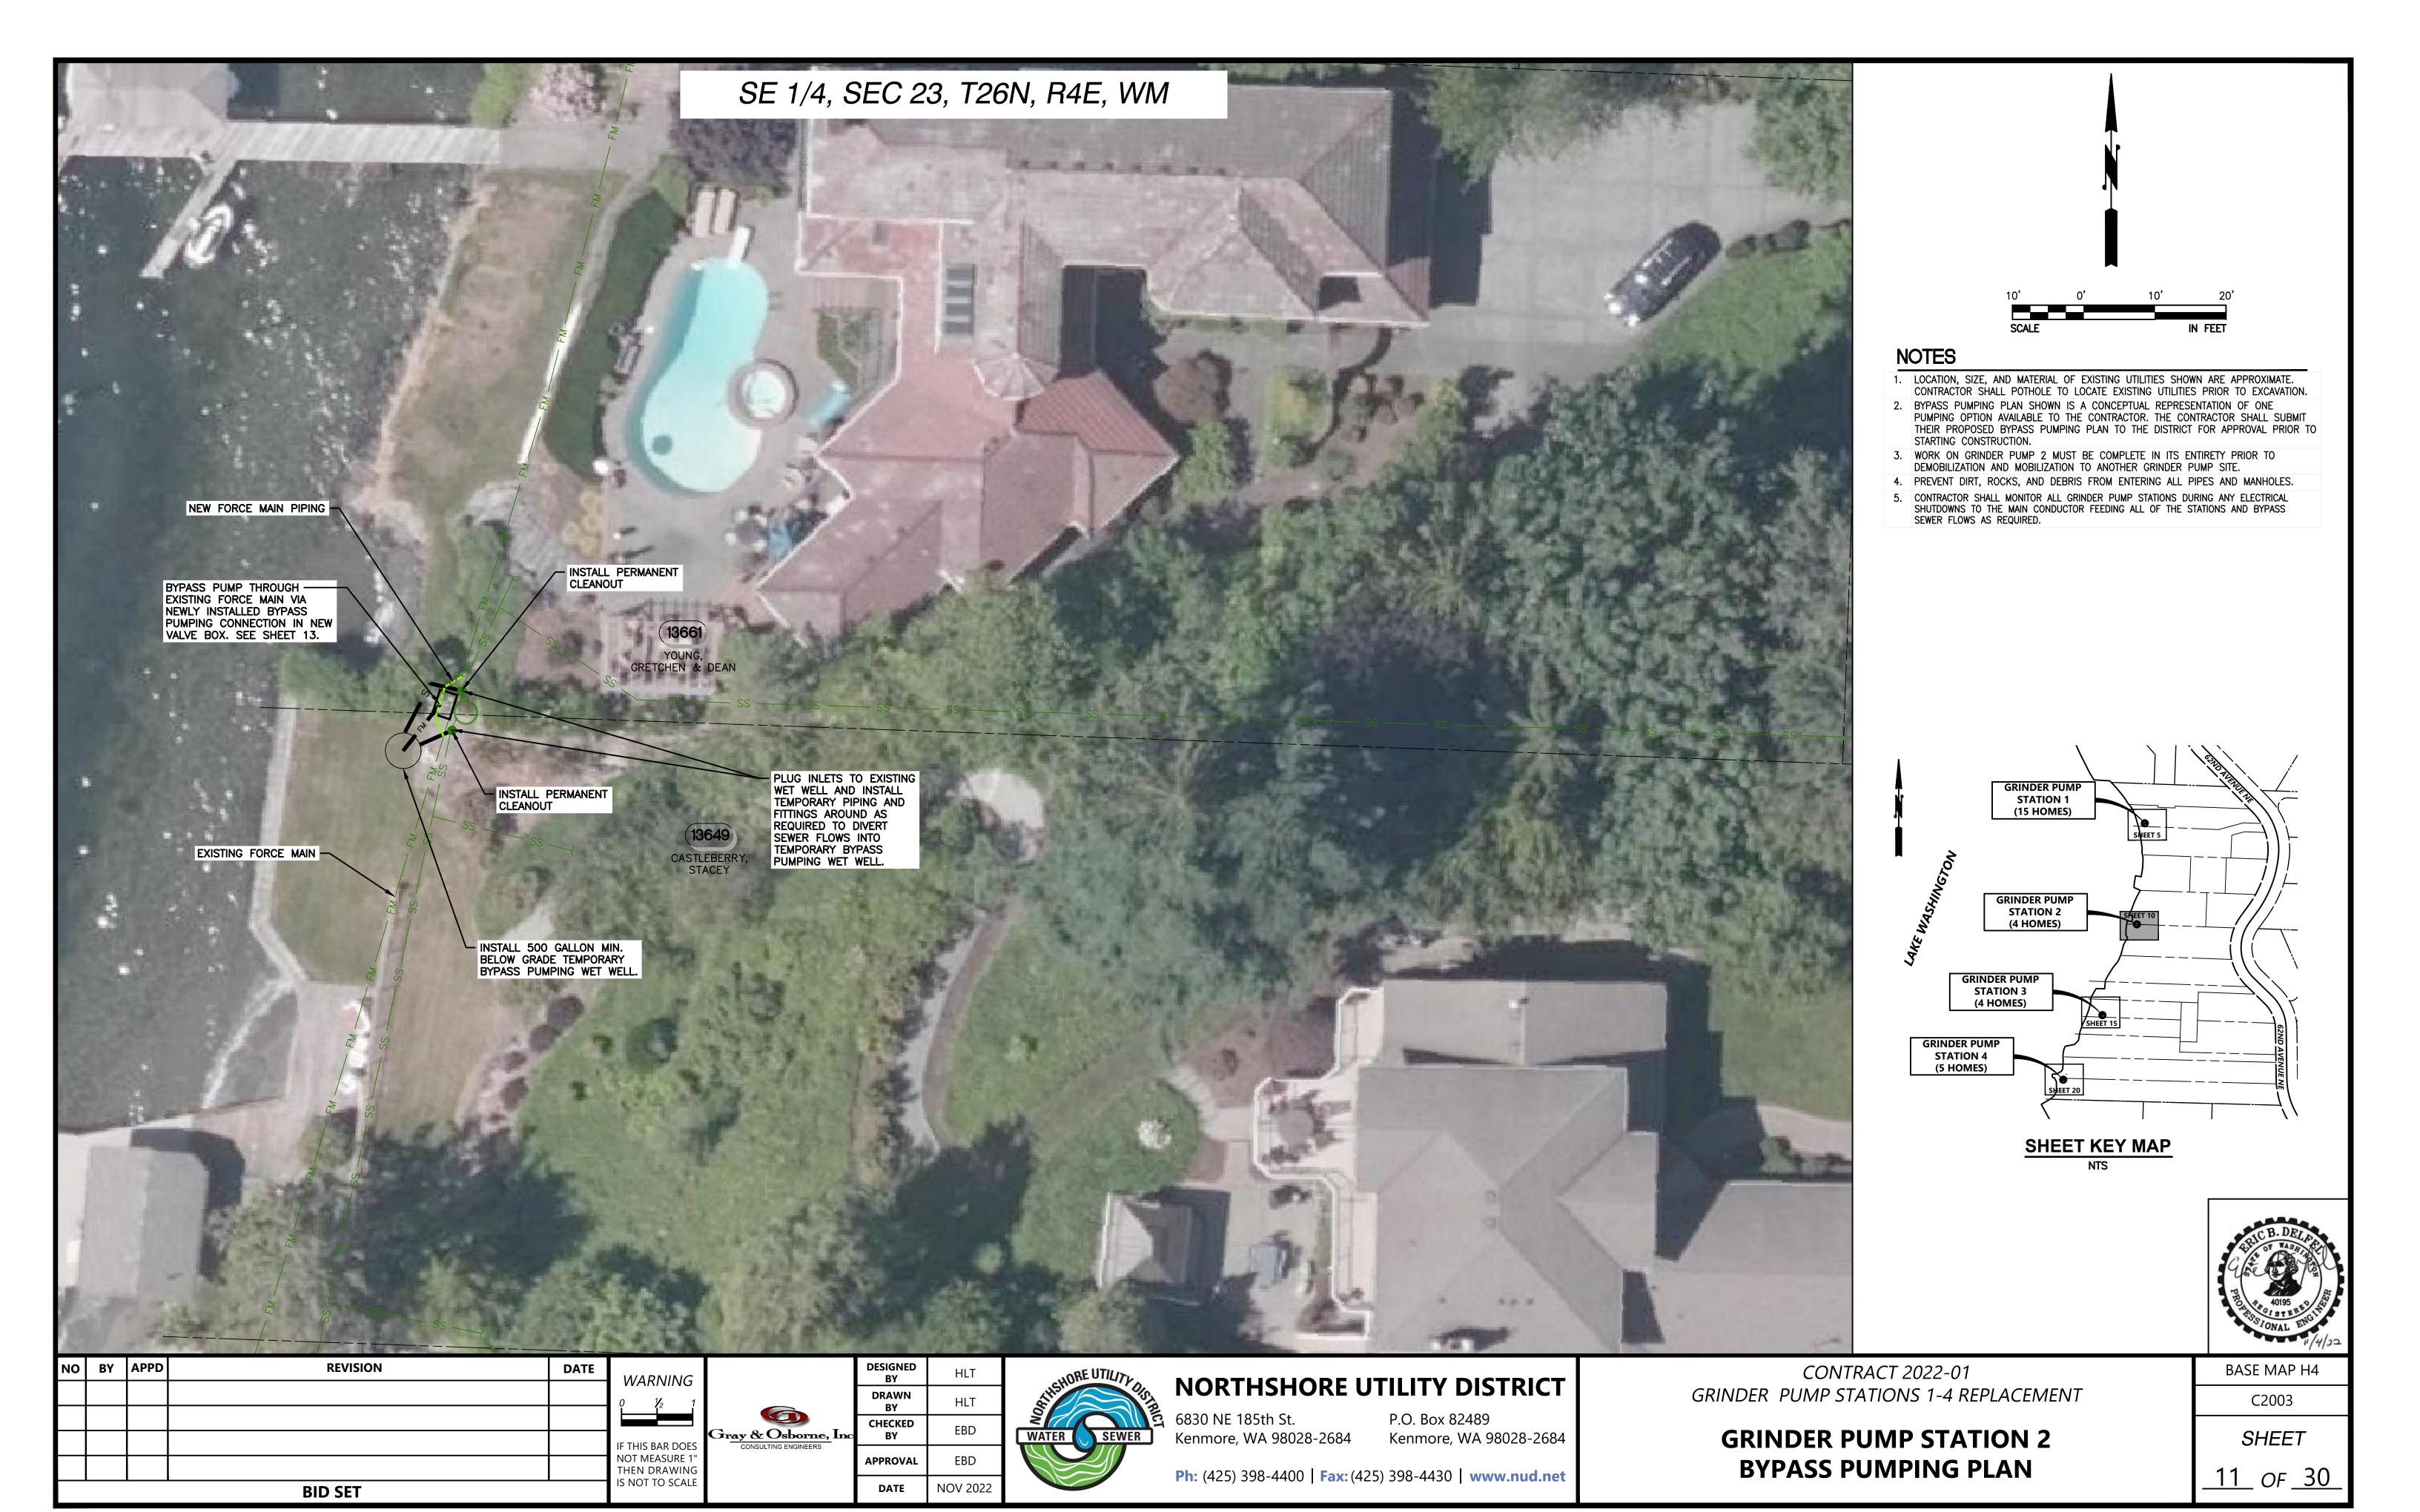

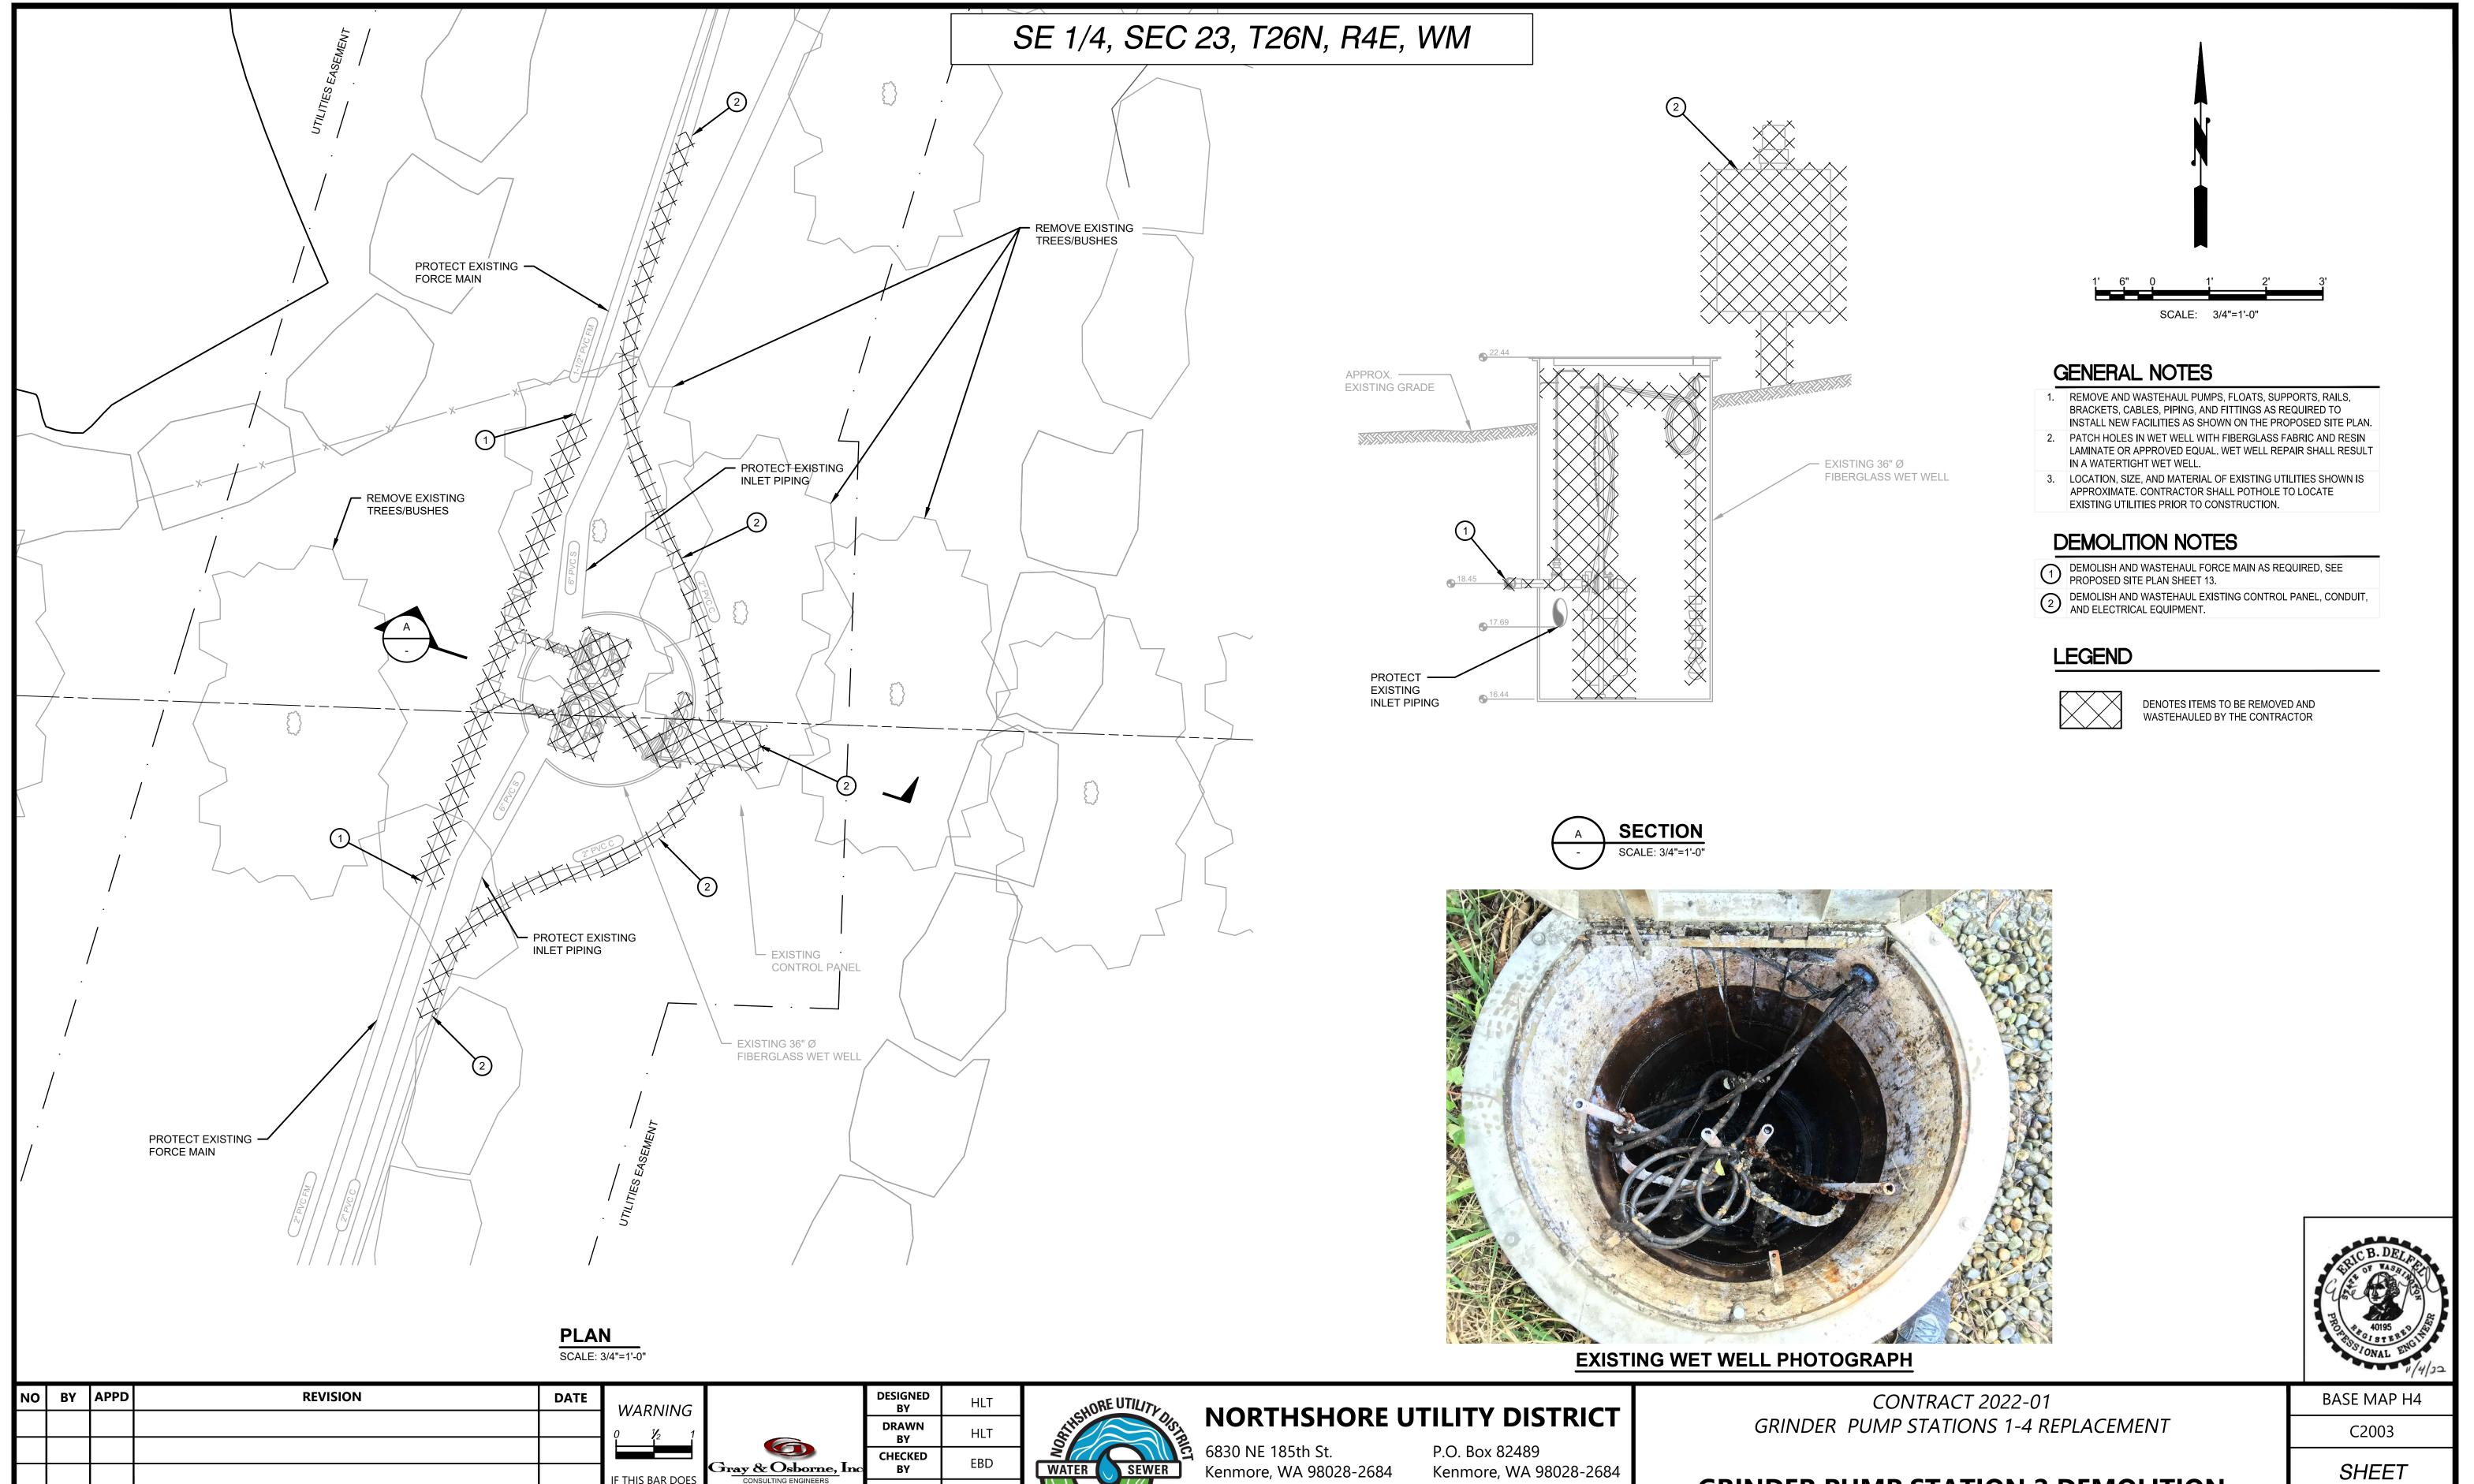

Kenmore, WA 98028-2684

Ph: (425) 398-4400 | Fax: (425) 398-4430 | www.nud.net

IF THIS BAR DOES NOT MEASURE 1" THEN DRAWING IS NOT TO SCALE

**BID SET** 

APPROVAL

DATE


NOV 2022

Kenmore, WA 98028-2684

**GRINDER PUMP STATION 2 DEMOLITION** 

SHEET

<u>12</u> of <u>30</u>

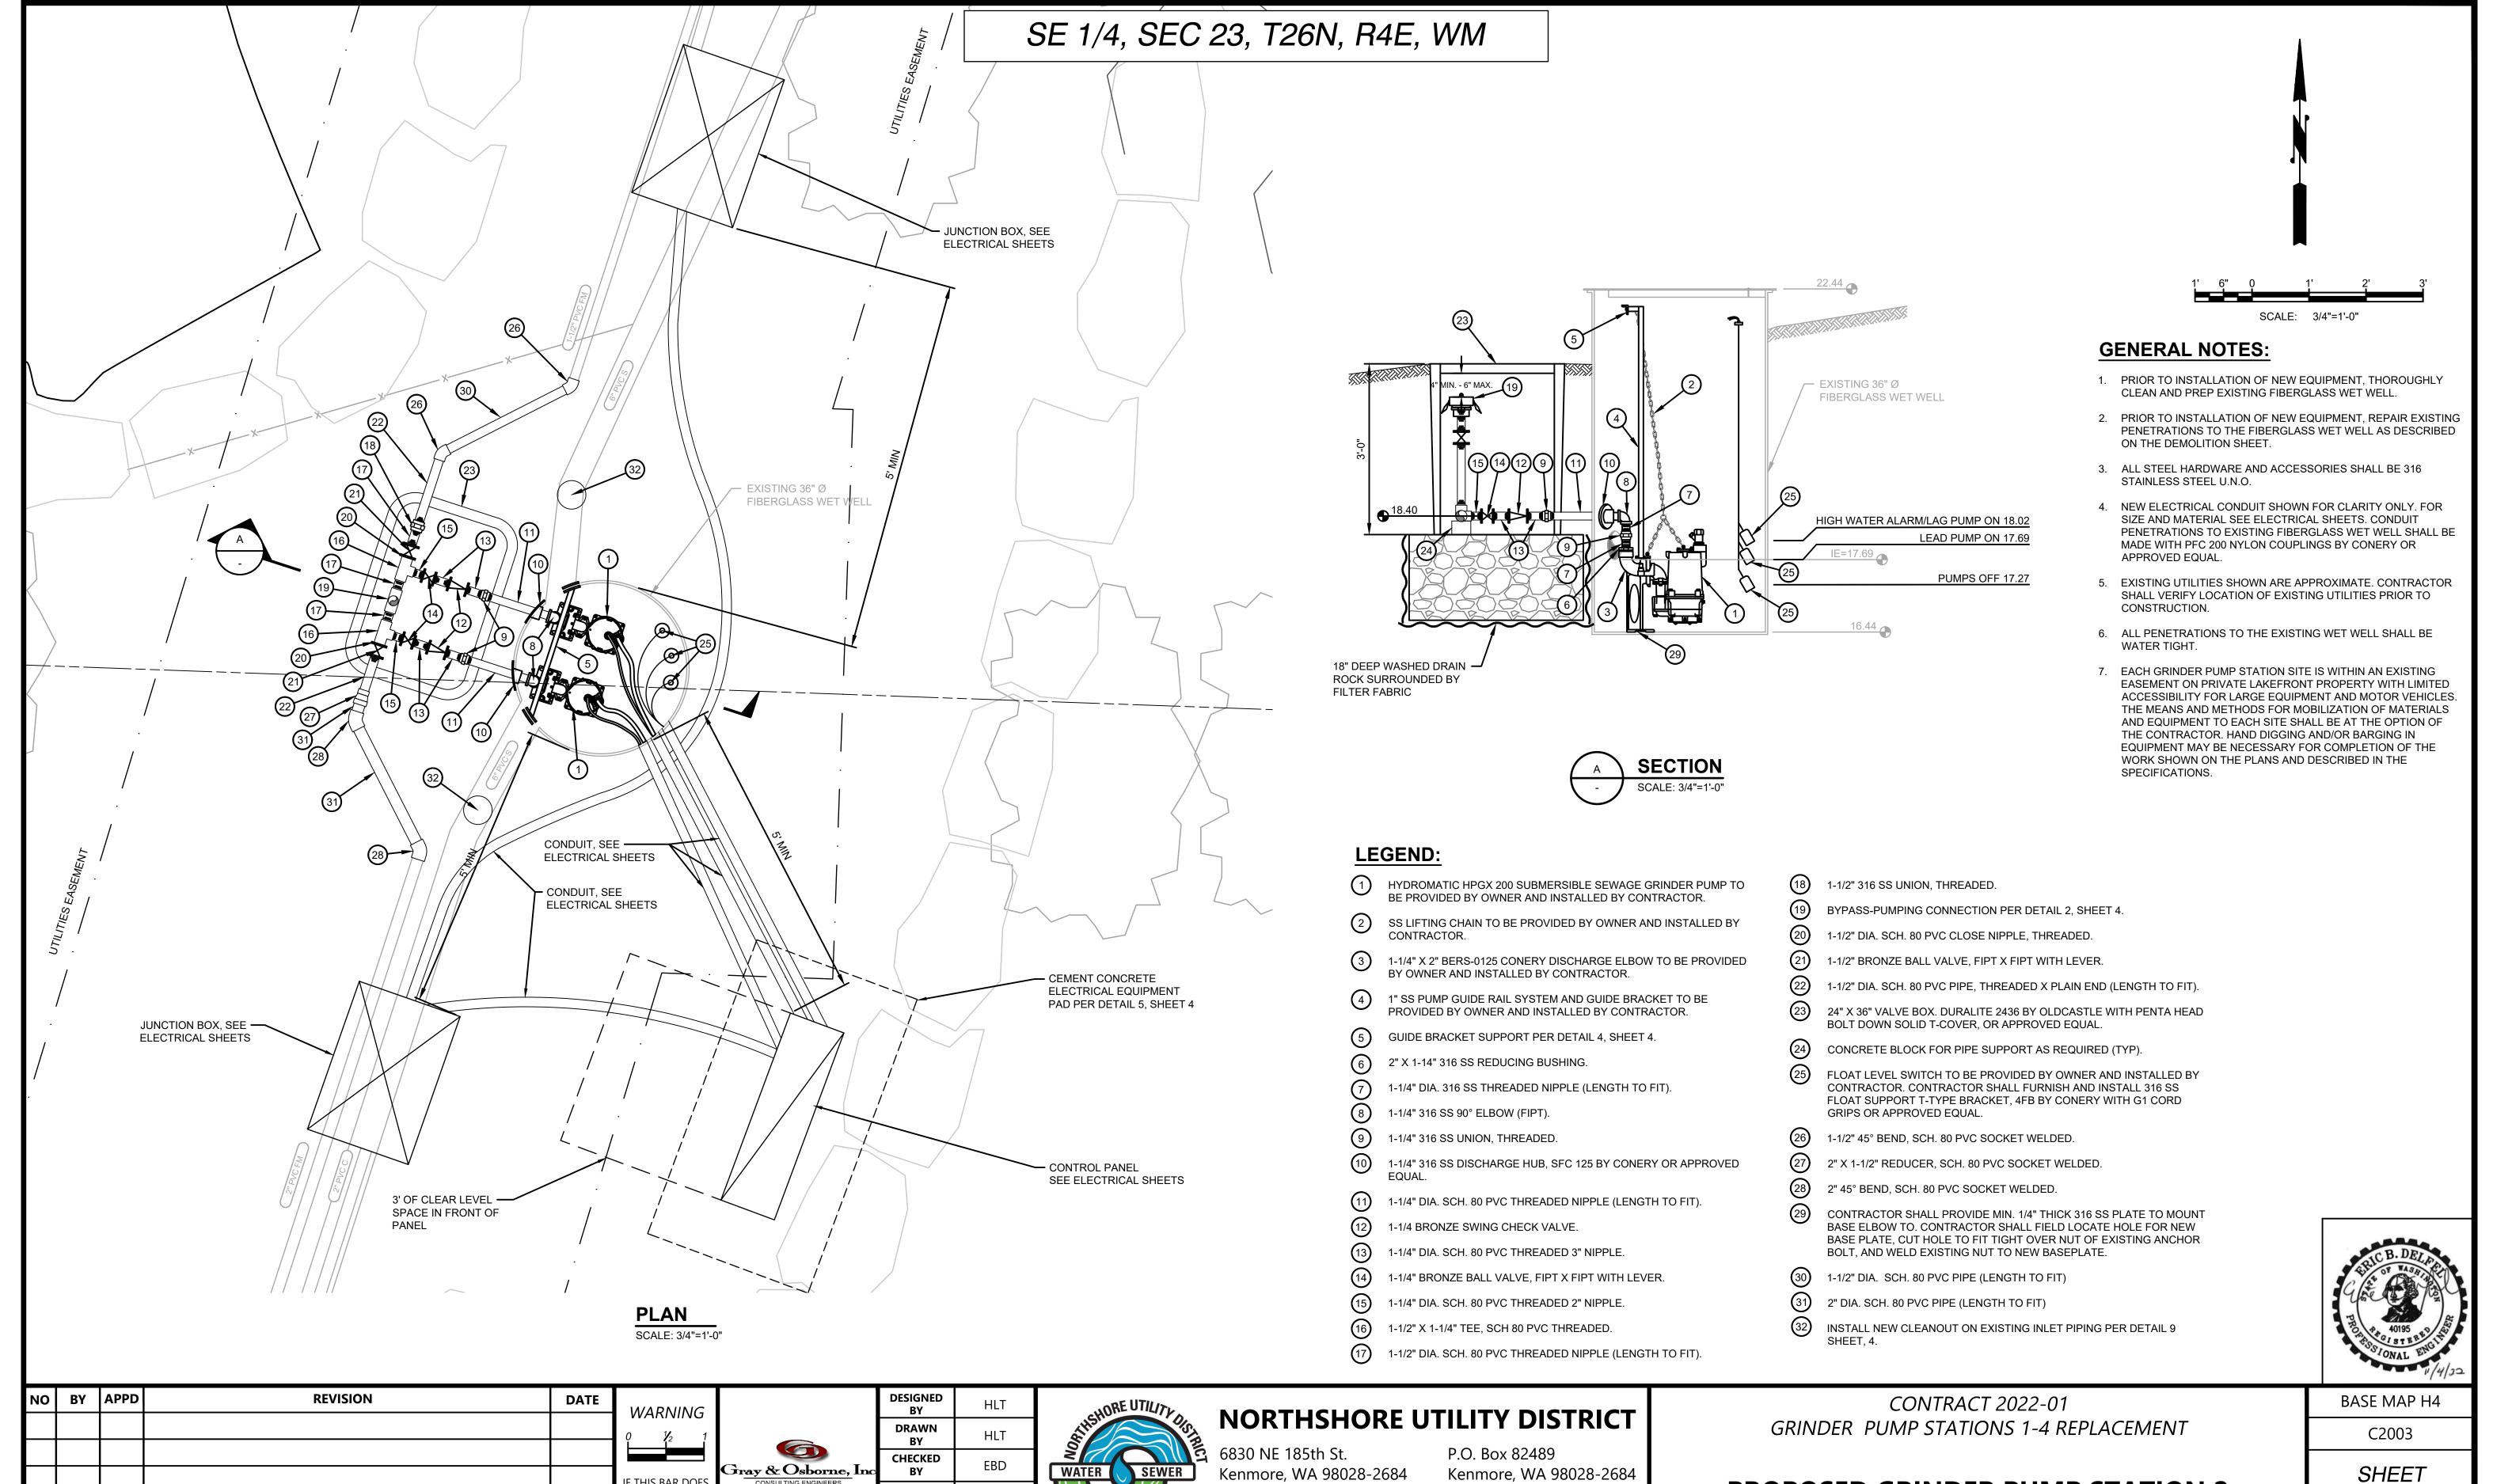

Ph: (425) 398-4400 | Fax: (425) 398-4430 | www.nud.net

F THIS BAR DOES

APPROVAL

DATE

NOV 2022

NOT MEASURE 1


THEN DRAWING

IS NOT TO SCALE

**BID SET** 

**PROPOSED GRINDER PUMP STATION 2** 

<u>13</u> of <u>30</u>

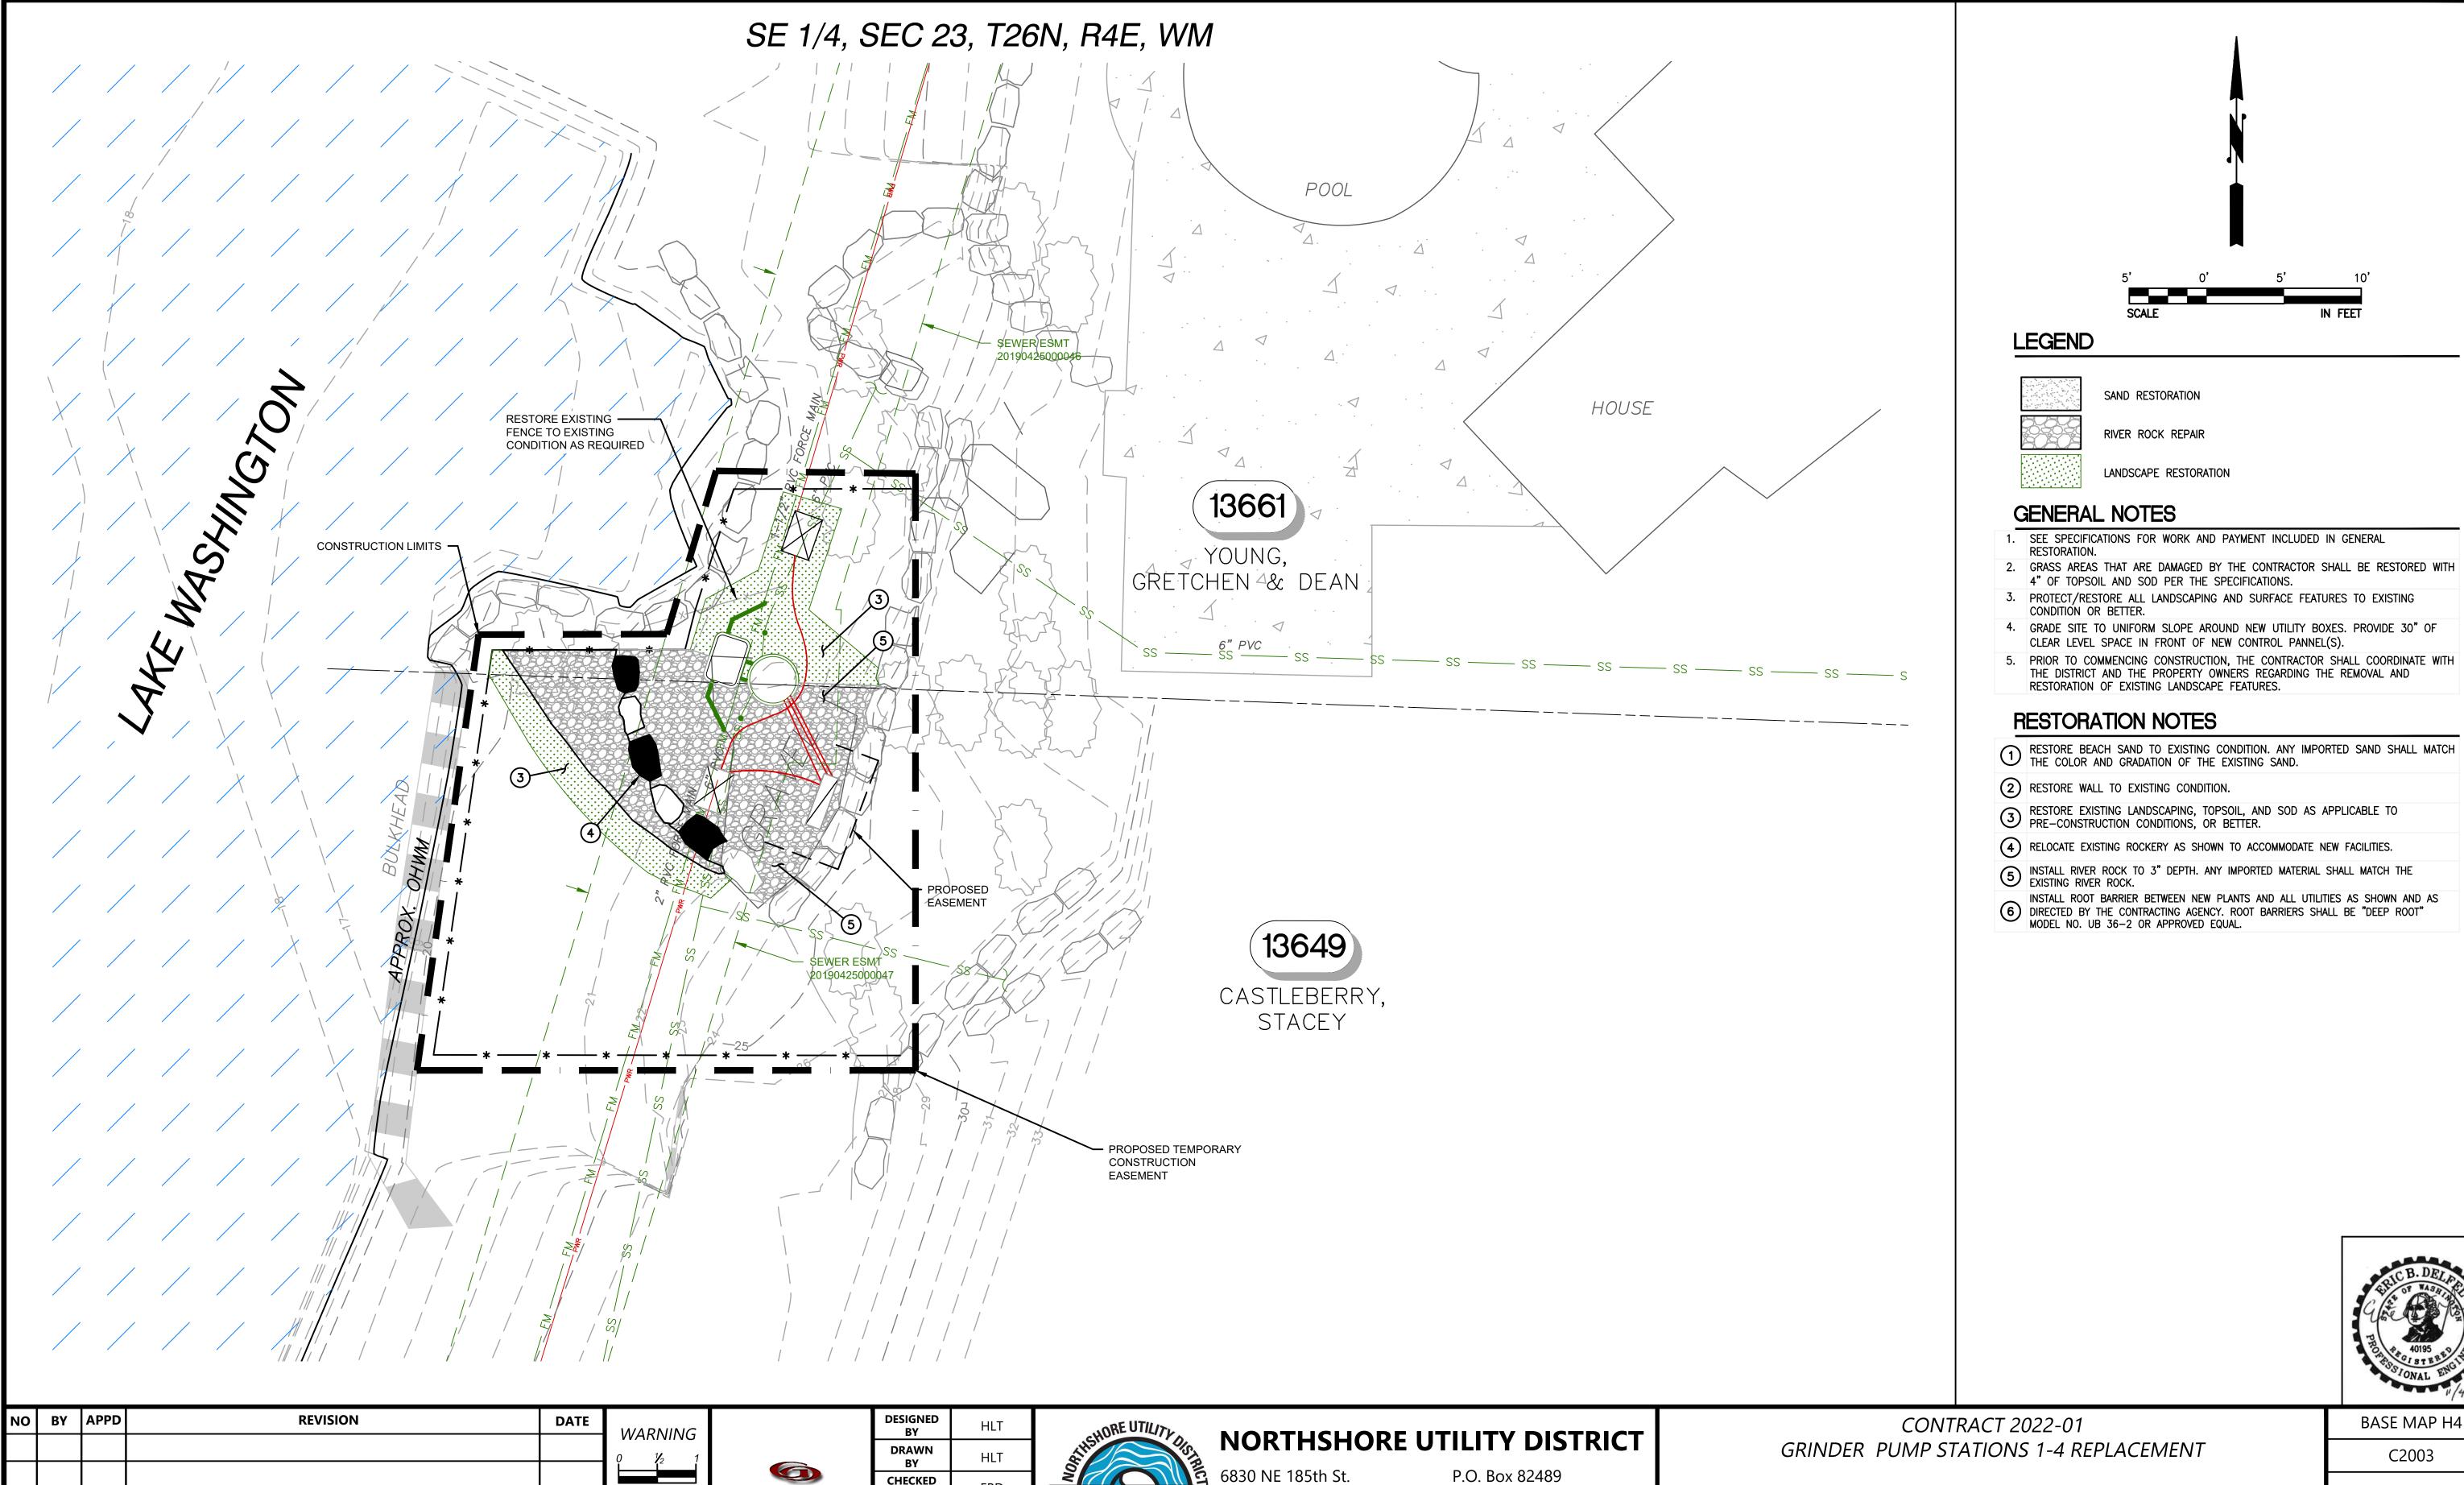

Kenmore, WA 98028-2684

Kenmore, WA 98028-2684

Ph: (425) 398-4400 | Fax: (425) 398-4430 | www.nud.net

CHECKED

**APPROVAL** 

DATE

NOV 2022

Gray & Osborne, In

F THIS BAR DOES NOT MEASURE 1

THEN DRAWING


IS NOT TO SCALE


**BID SET** 


**GRINDER PUMP STATION 2 RESTORATION PLAN** 


BASE MAP H4


SHEET <u> 14</u> of <u>30</u>

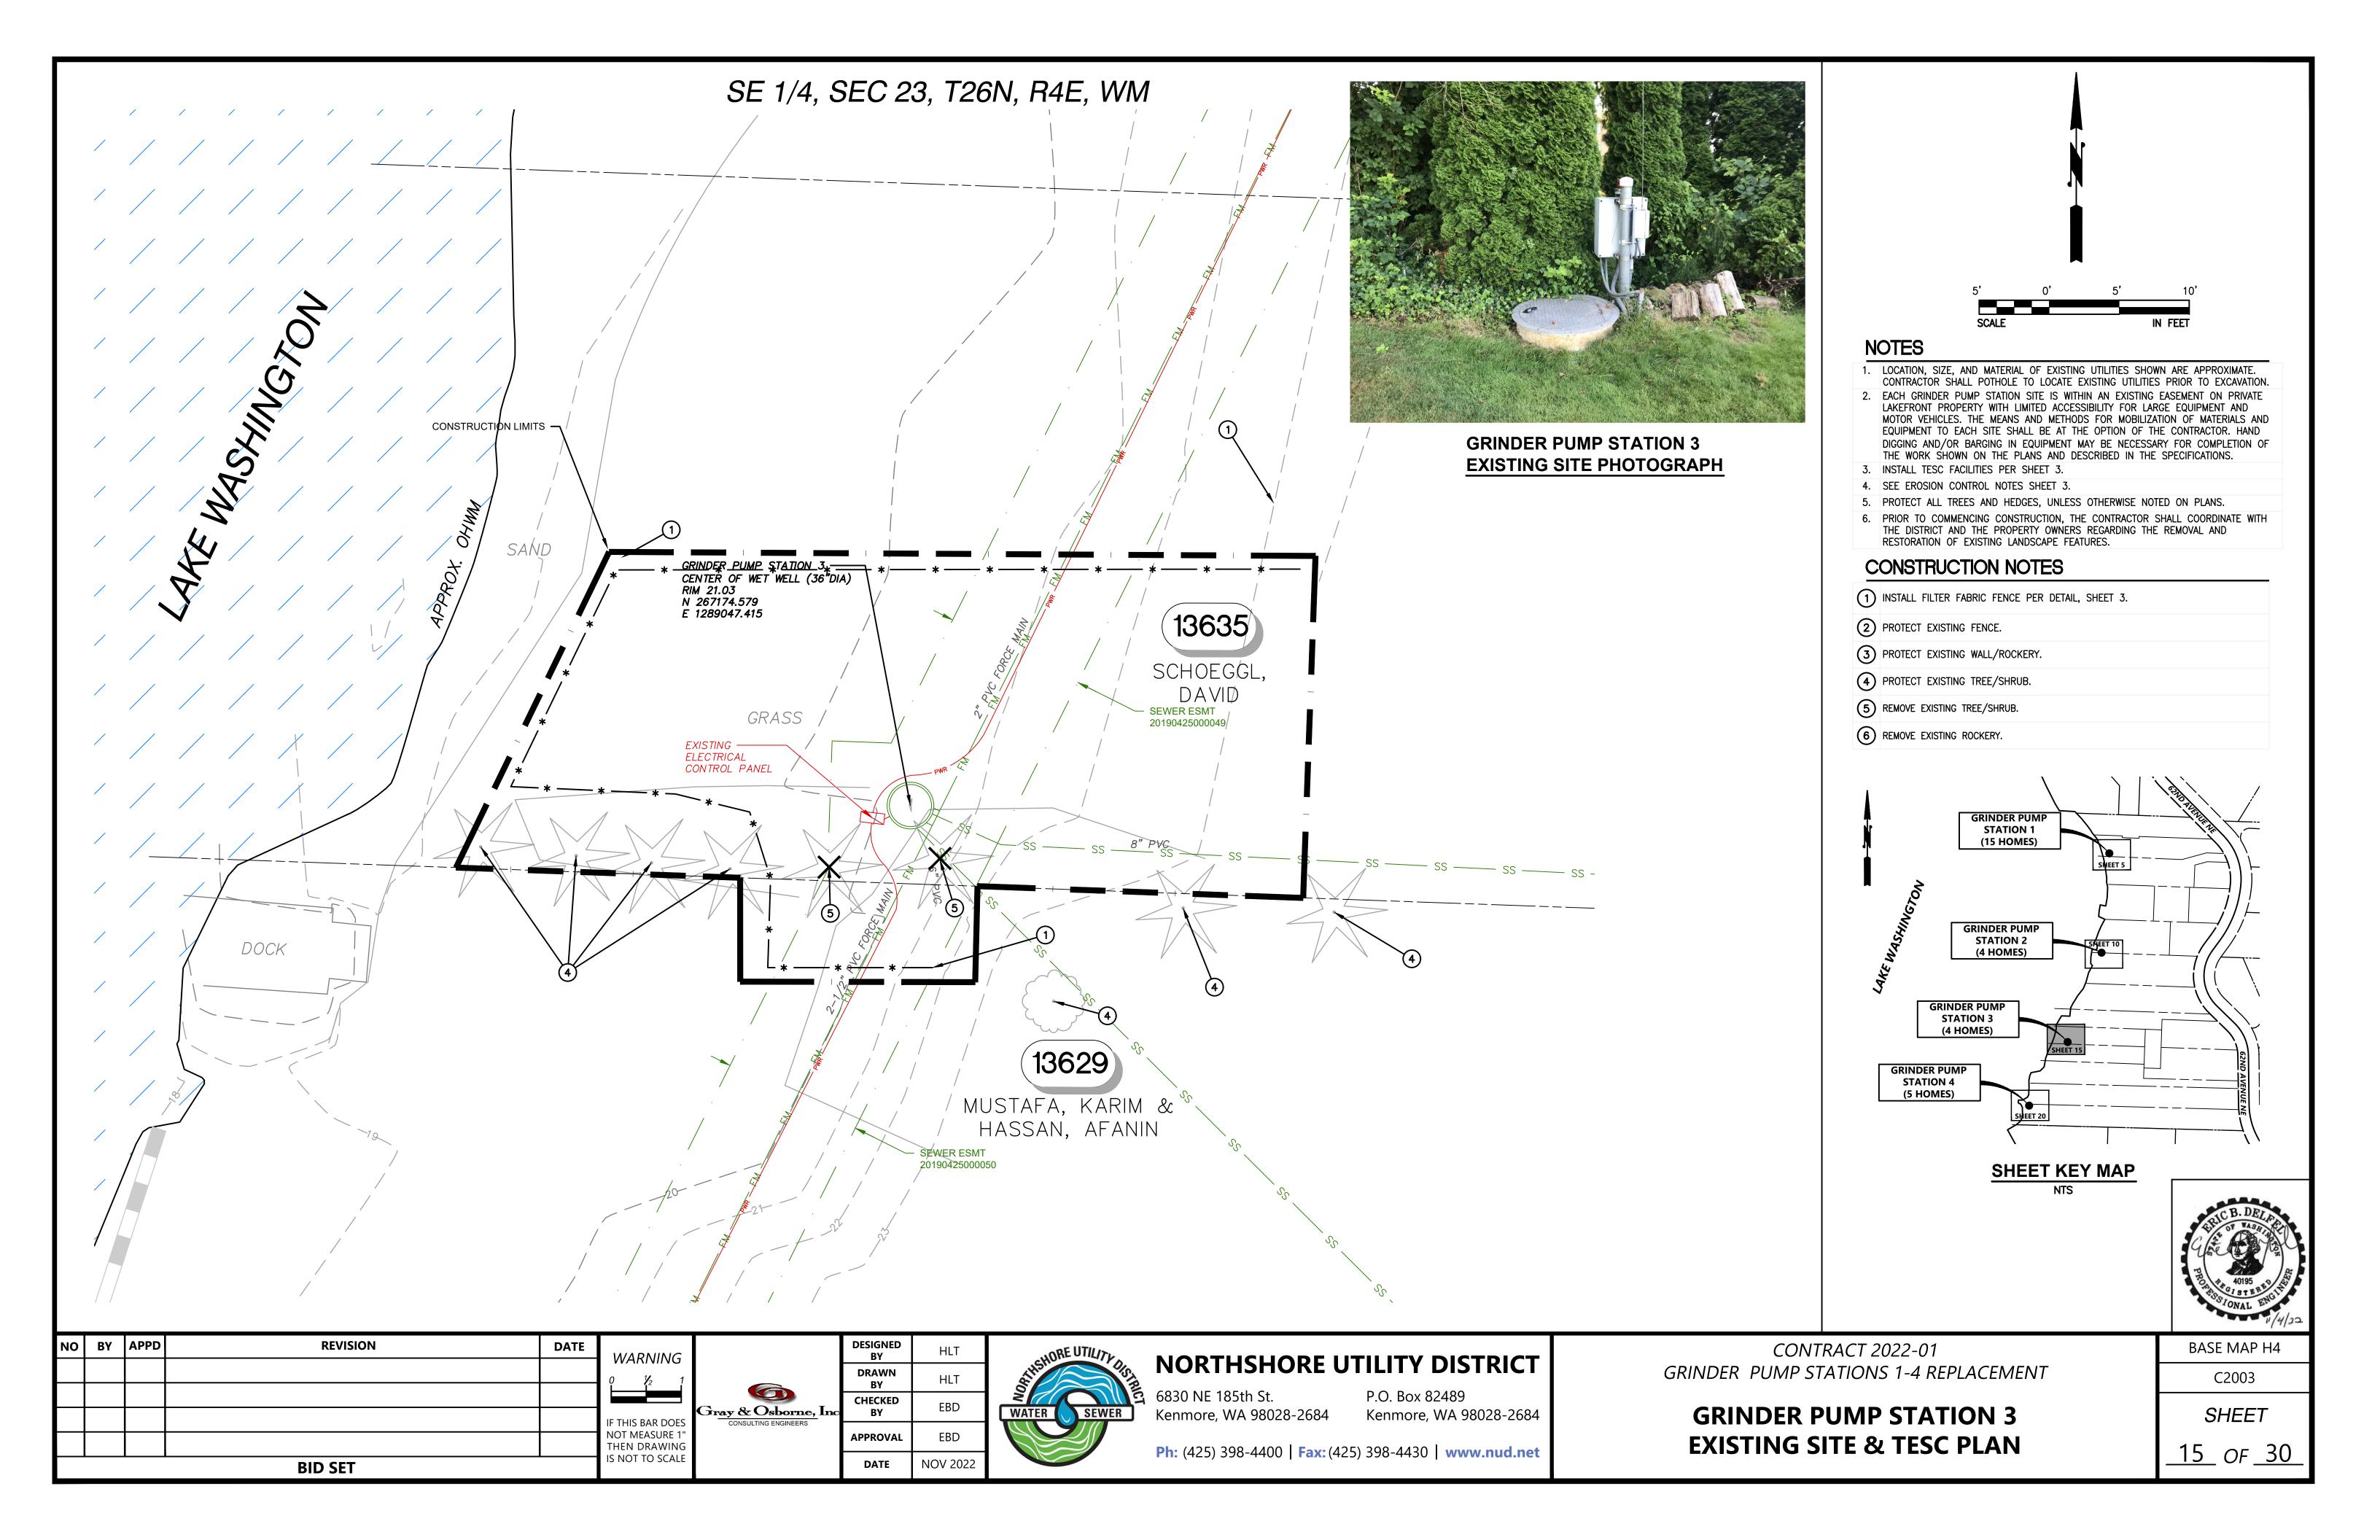

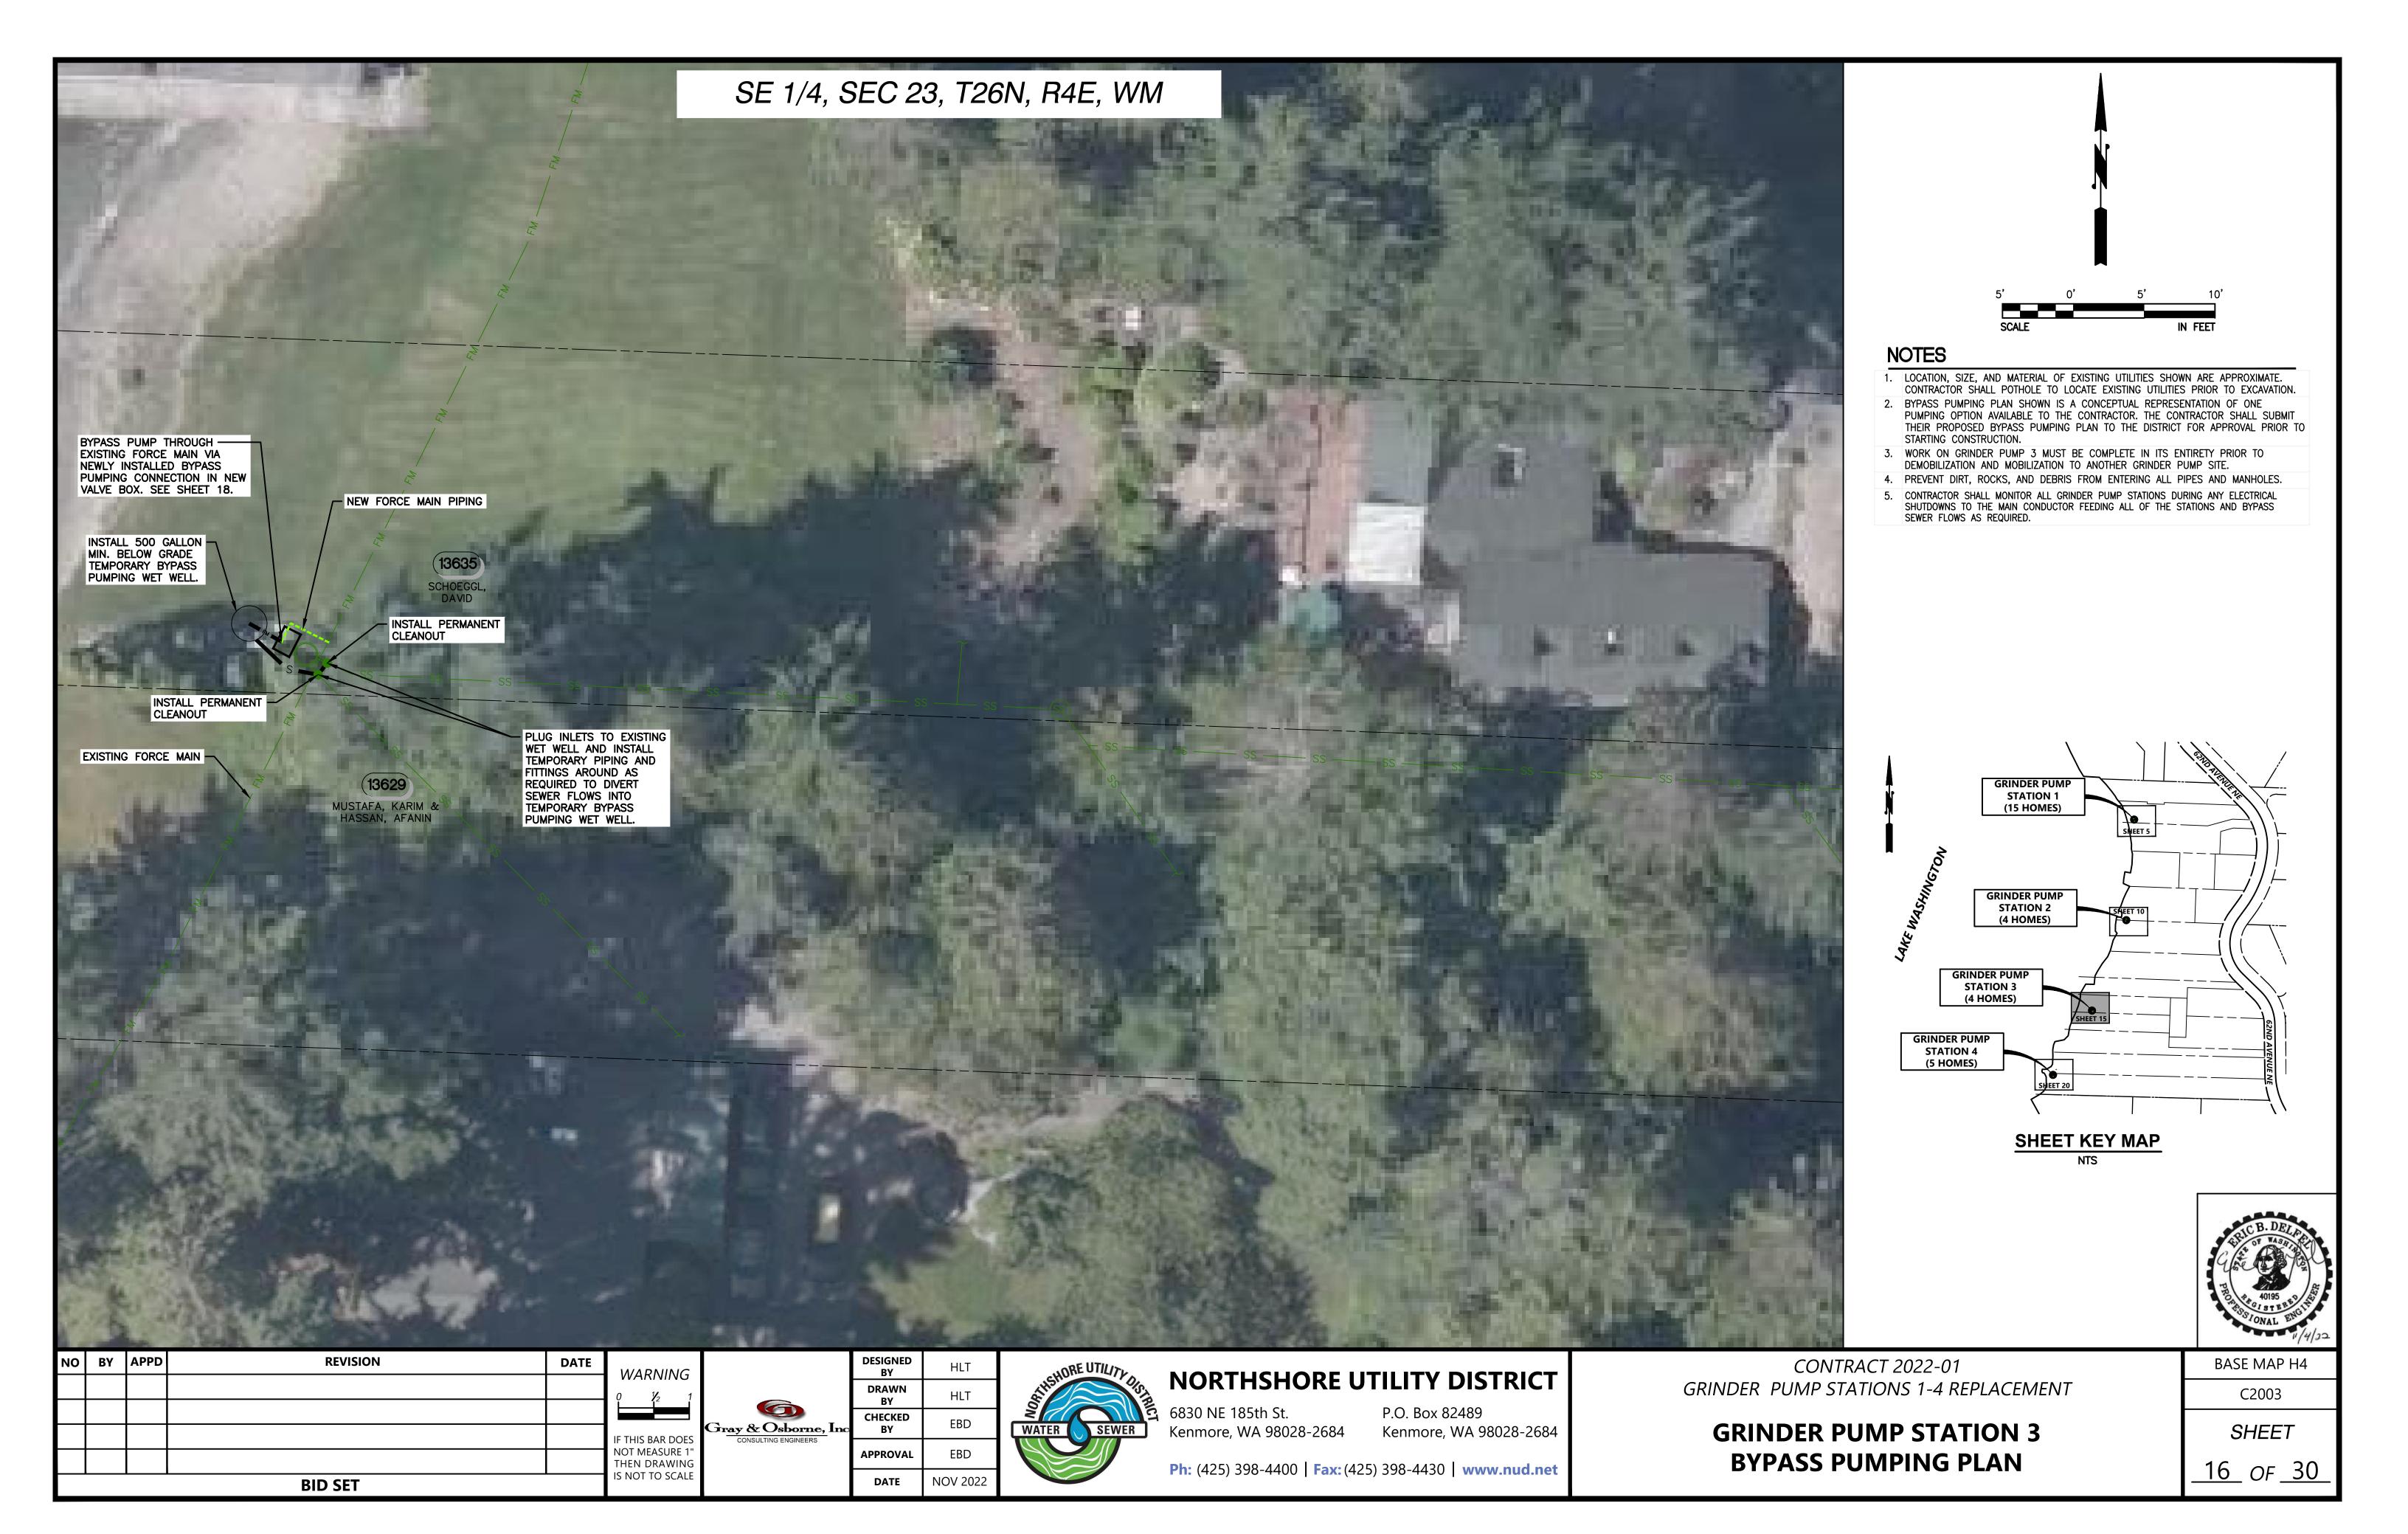

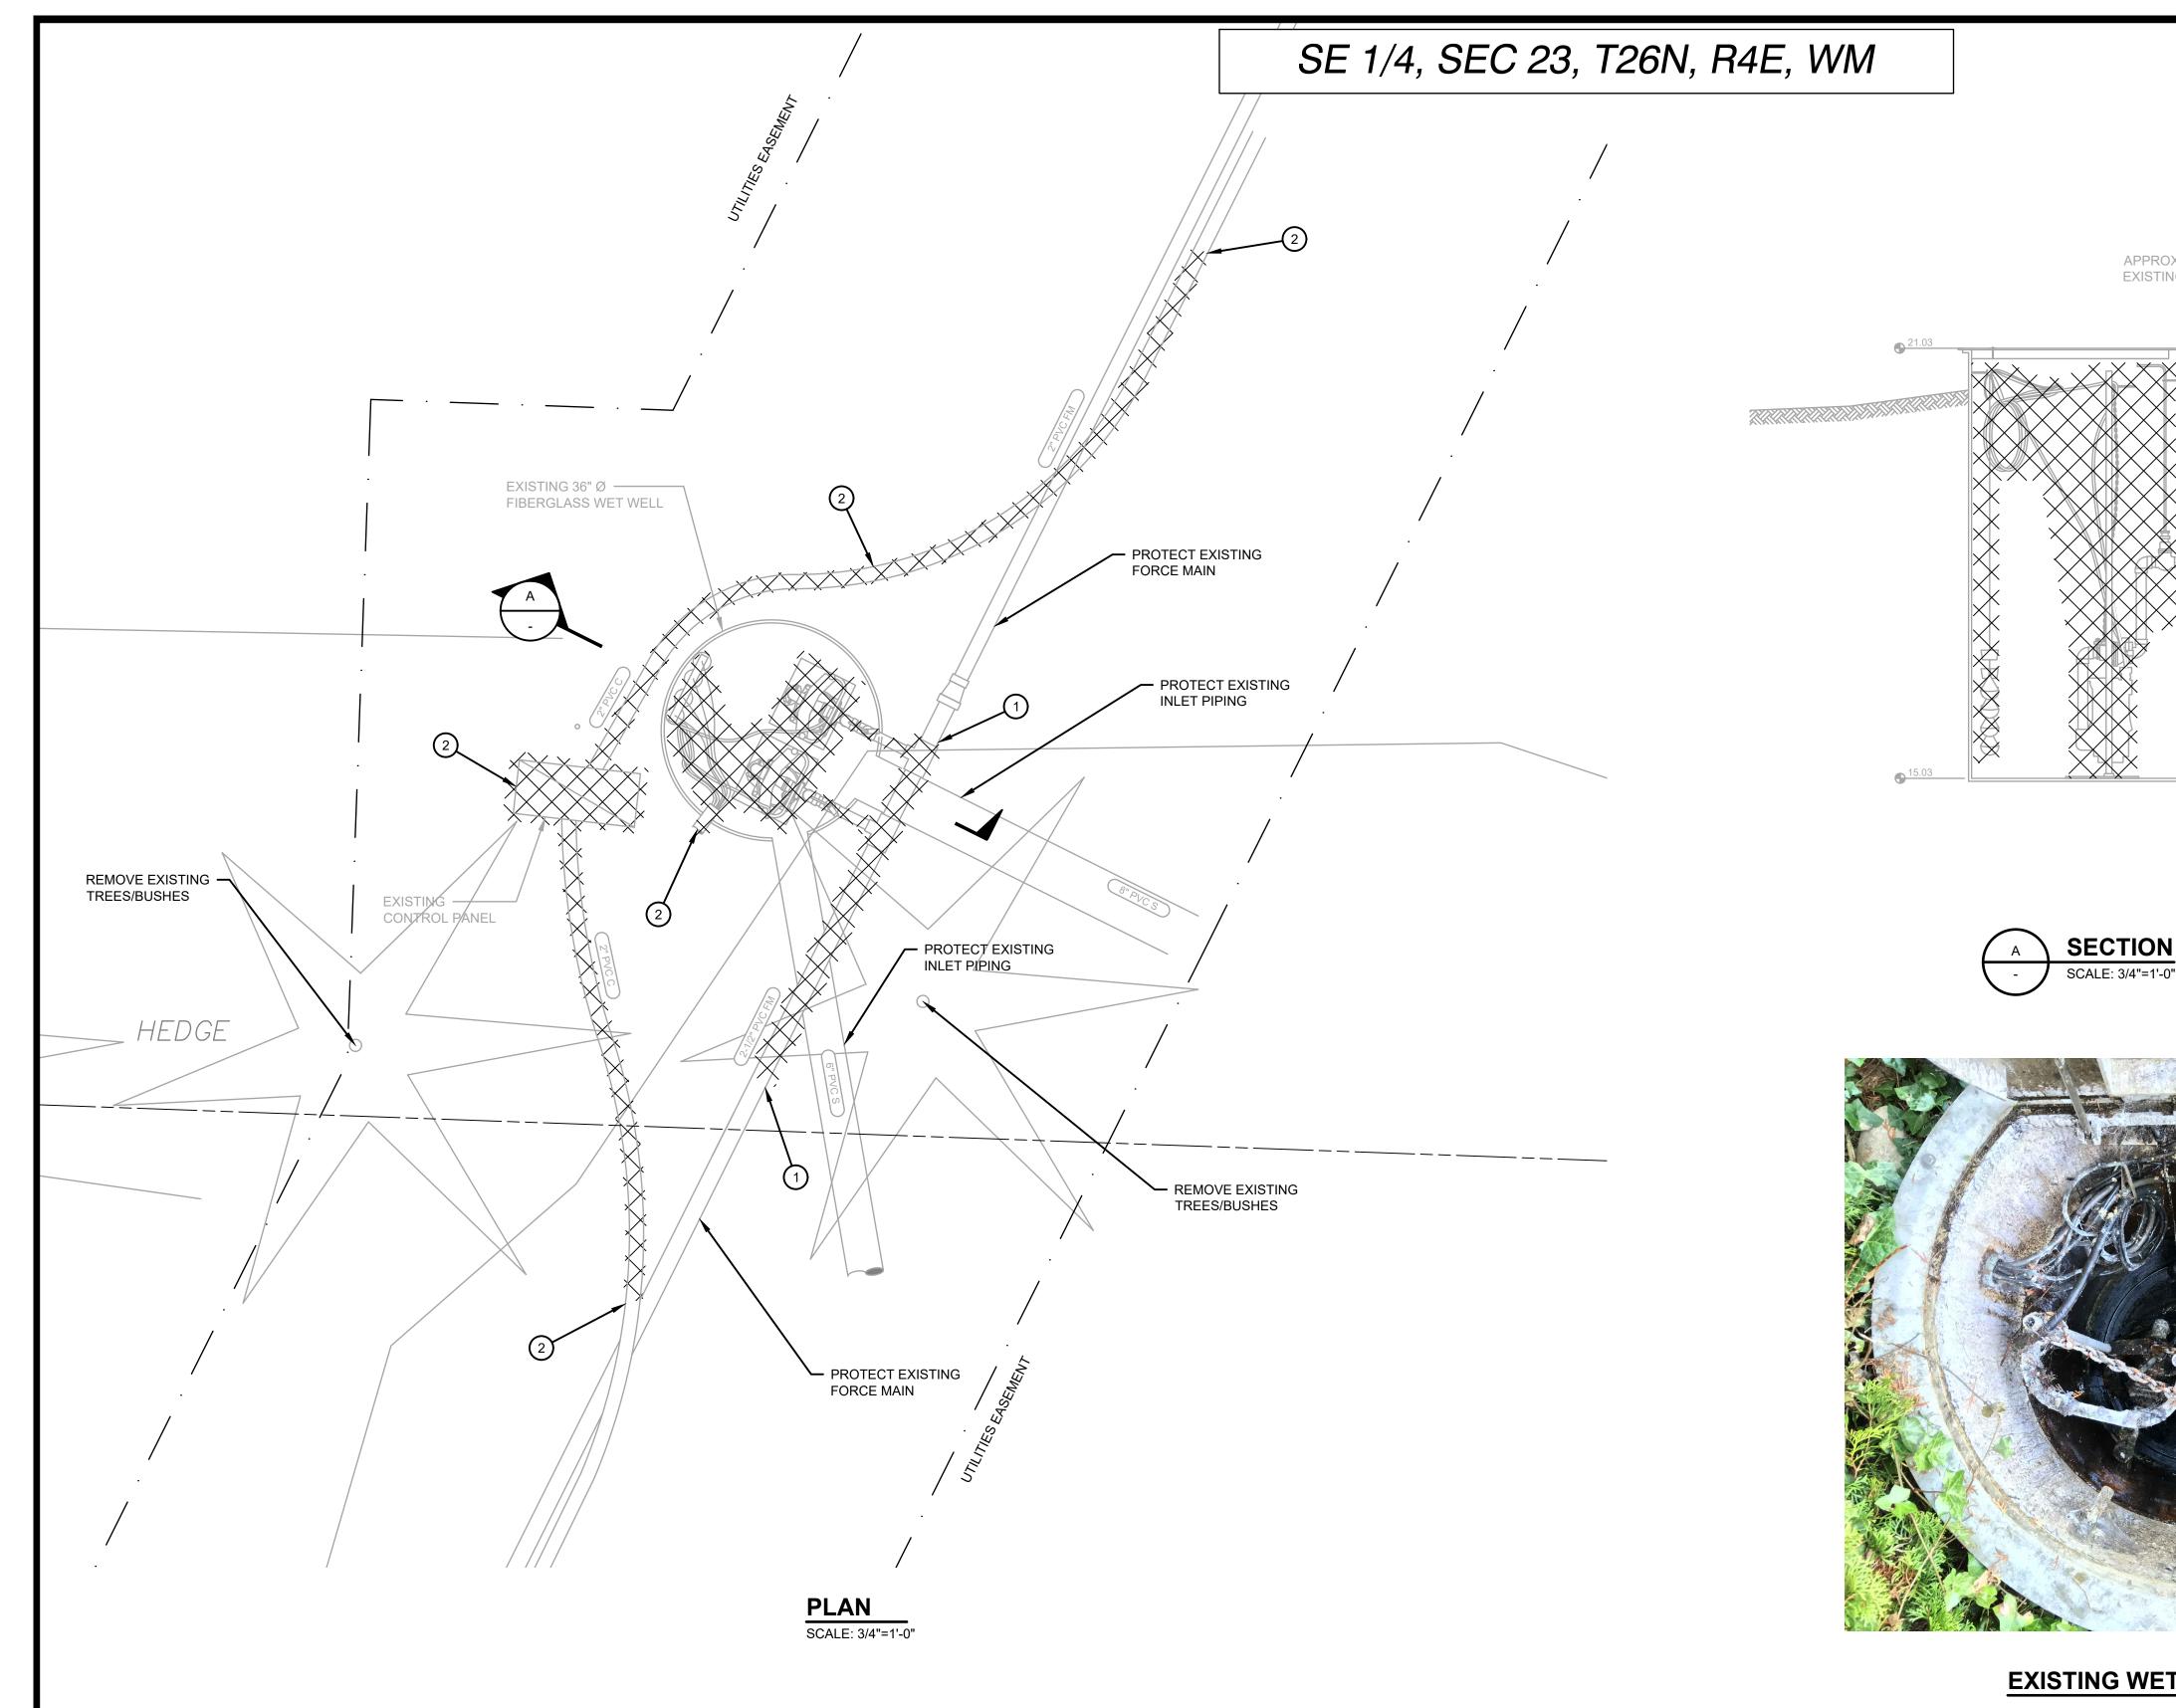

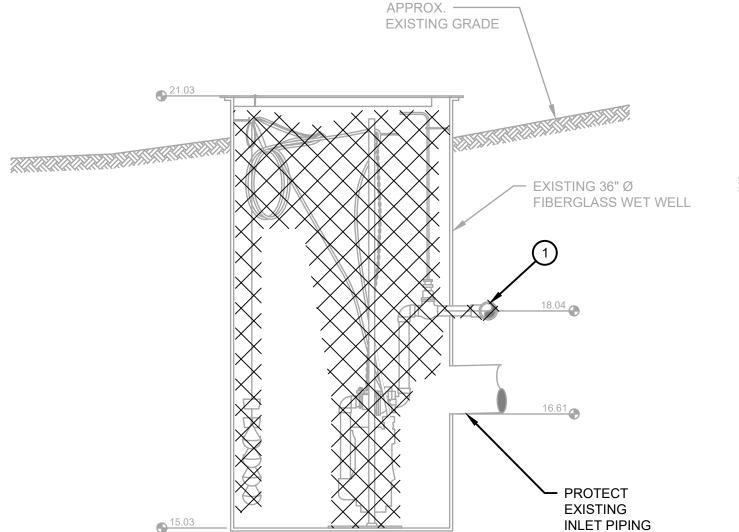

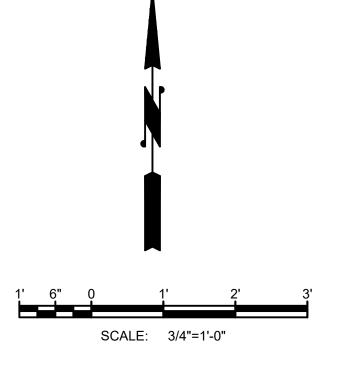

## **GENERAL NOTES**

- 1. REMOVE AND WASTEHAUL PUMPS, FLOATS, SUPPORTS, RAILS, BRACKETS, CABLES, PIPING, AND FITTINGS AS REQUIRED TO INSTALL NEW FACILITIES AS SHOWN ON THE PROPOSED SITE PLAN. 2. PATCH HOLES IN WET WELL WITH FIBERGLASS FABRIC AND RESIN LAMINATE OR APPROVED EQUAL. WET WELL REPAIR SHALL RESULT
- IN A WATERTIGHT WET WELL. 3. LOCATION, SIZE, AND MATERIAL OF EXISTING UTILITIES SHOWN IS APPROXIMATE. CONTRACTOR SHALL POTHOLE TO LOCATE

### **DEMOLITION NOTES**

DEMOLISH AND WASTEHAUL FORCE MAIN AS REQUIRED, SEE PROPOSED SITE PLAN SHEET 18.

EXISTING UTILITIES PRIOR TO CONSTRUCTION.

- DEMOLISH AND WASTEHAUL EXISTING CONTROL PANEL, CONDUIT, AND ELECTRICAL EQUIPMENT.




**LEGEND** 



DENOTES ITEMS TO BE REMOVED AND WASTEHAULED BY THE CONTRACTOR





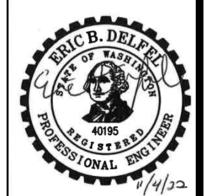

NO	BY	APPD	REVISION	DATE	WARNING
					0 1/2 1
					IF THIS BAR DOES
					NOT MEASURE 1 THEN DRAWING
			BID SET		IS NOT TO SCALI

Gray & Osborne, Inc

DESIGNED BY DRAWN CHECKED NOV 2022 DATE



# **NORTHSHORE UTILITY DISTRICT**

6830 NE 185th St. Kenmore, WA 98028-2684

P.O. Box 82489 Kenmore, WA 98028-2684

Ph: (425) 398-4400 | Fax: (425) 398-4430 | www.nud.net


**CONTRACT 2022-01** GRINDER PUMP STATIONS 1-4 REPLACEMENT


**GRINDER PUMP STATION 3 DEMOLITION** 

BASE MAP H4	
C2003	


SHEET

<u>17</u> of <u>30</u>

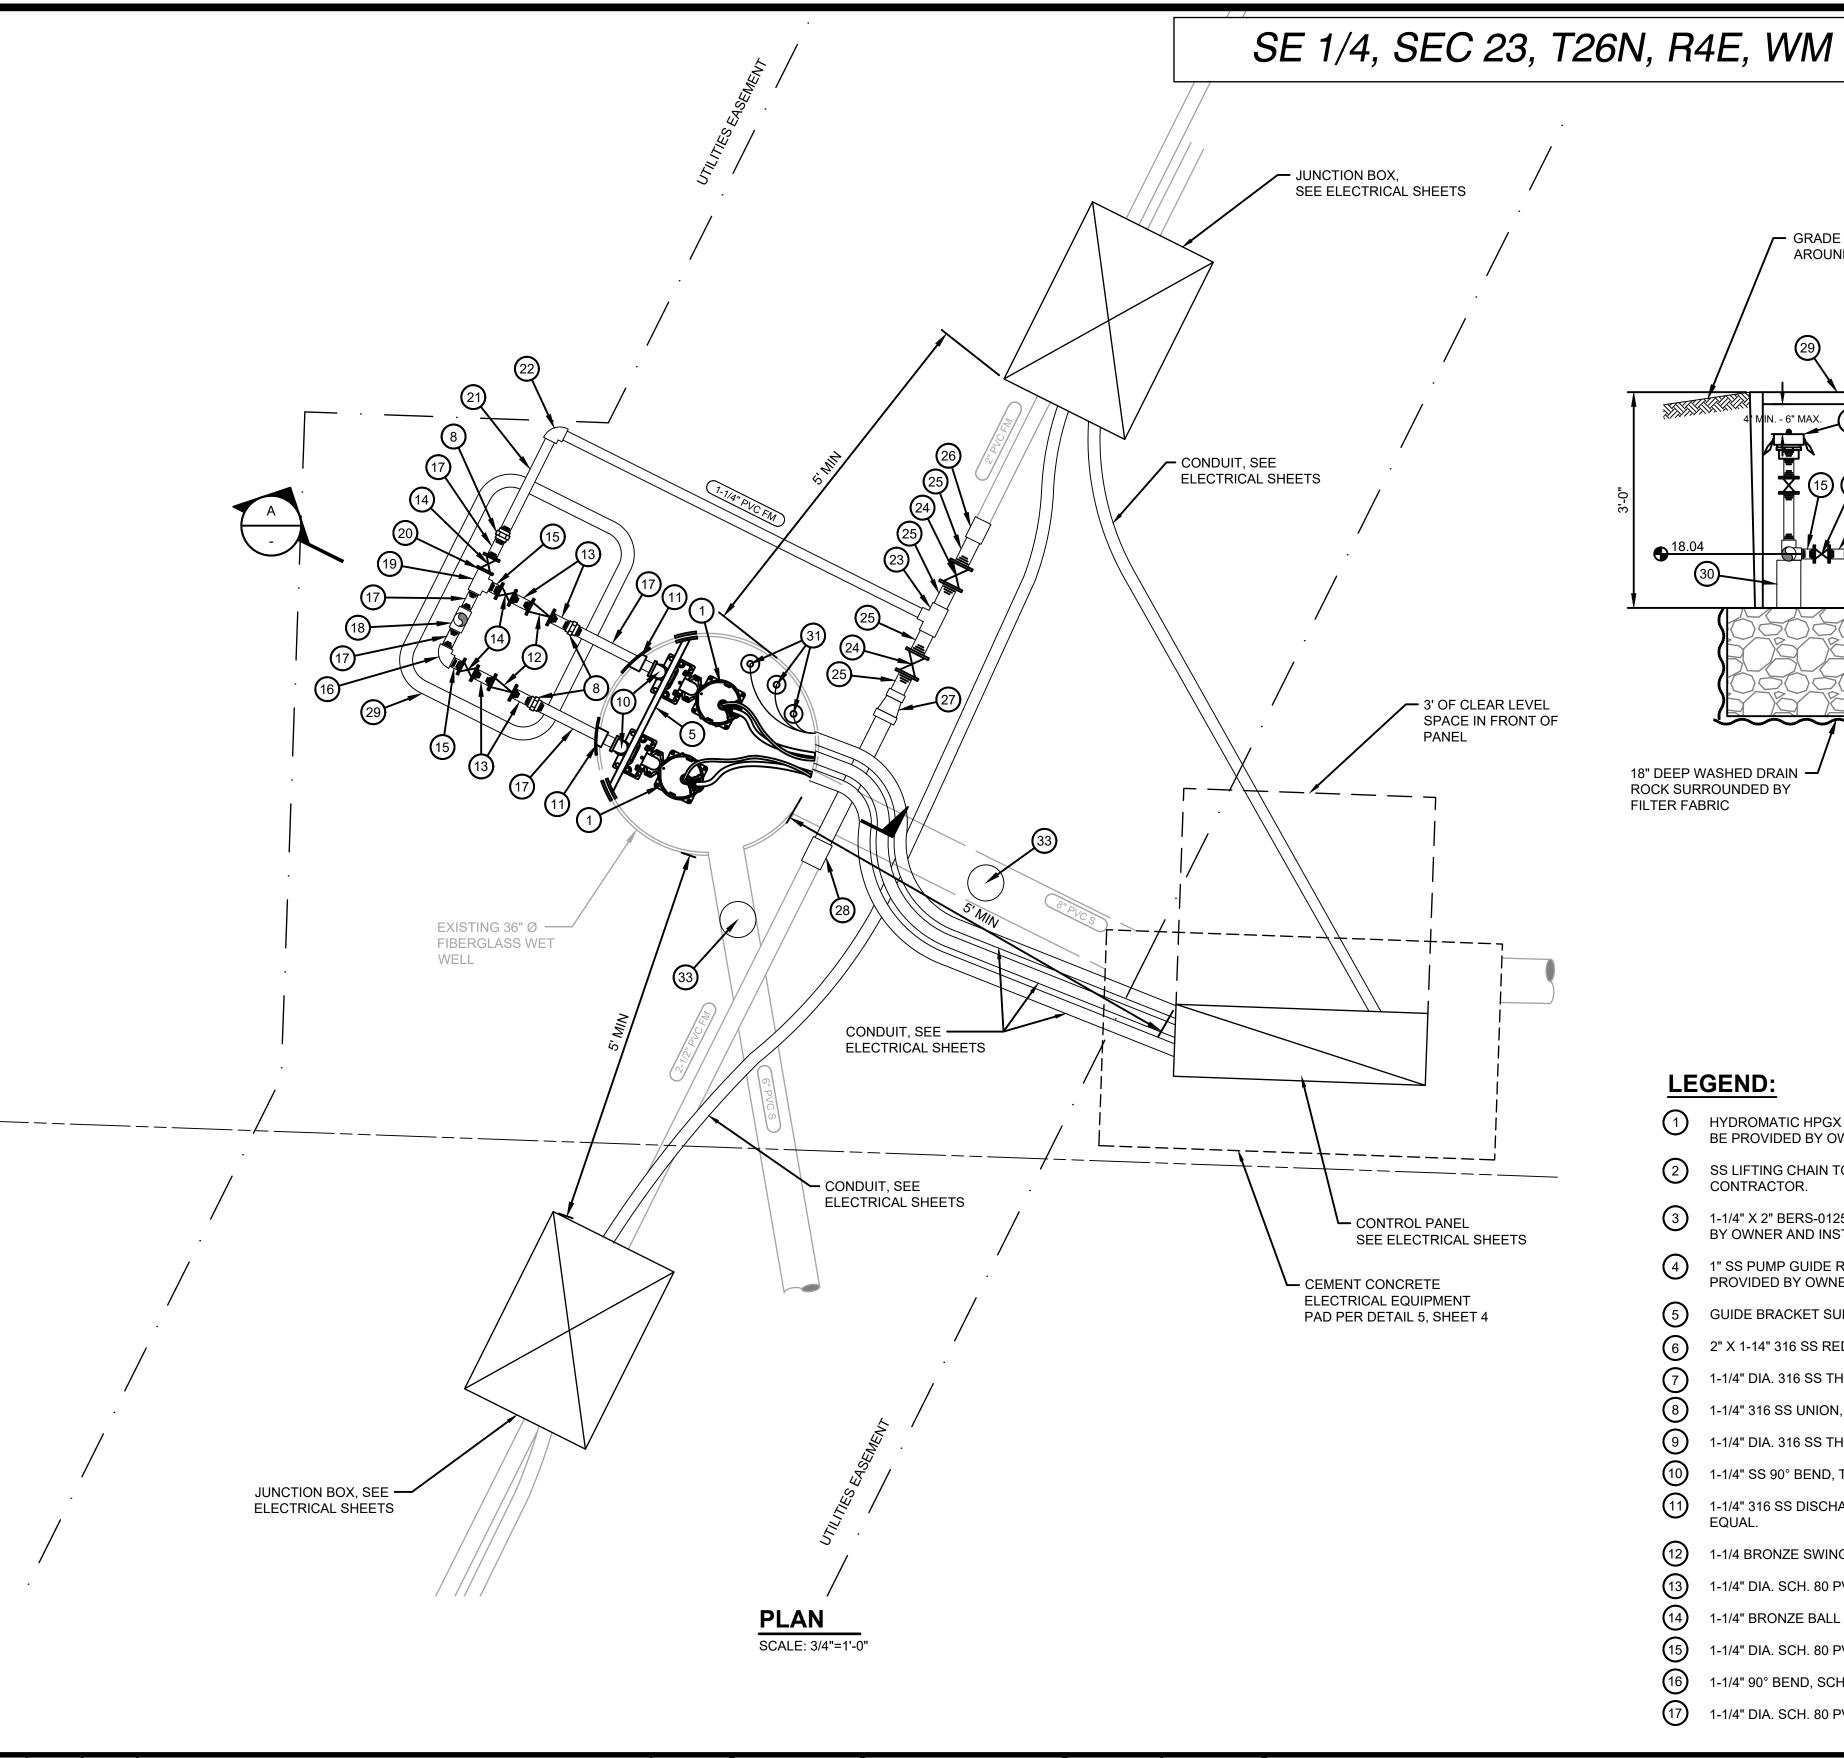

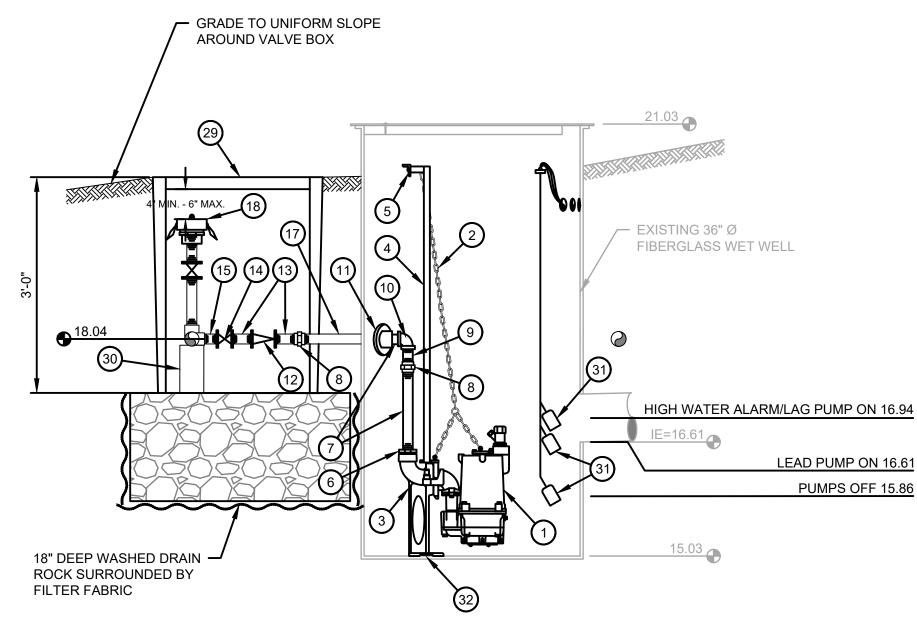

**SECTION** SCALE: 3/4"=1'-0"

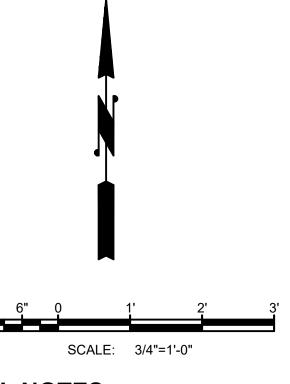


#### **GENERAL NOTES:**

- 1. PRIOR TO INSTALLATION OF NEW EQUIPMENT, THOROUGHLY CLEAN AND PREP EXISTING FIBERGLASS WET WELL.
- 2. PRIOR TO INSTALLATION OF NEW EQUIPMENT, REPAIR EXISTING PENETRATIONS TO THE FIBERGLASS WET WELL AS DESCRIBED ON THE DEMOLITION SHEET.
- 3. ALL STEEL HARDWARE AND ACCESSORIES SHALL BE 316 STAINLESS STEEL U.N.O.
- 4. NEW ELECTRICAL CONDUIT SHOWN FOR CLARITY ONLY. FOR SIZE AND MATERIAL SEE ELECTRICAL SHEETS. CONDUIT PENETRATIONS TO EXISTING FIBERGLASS WET WELL SHALL BE MADE WITH PFC 200 NYLON COUPLINGS BY CONERY OR APPROVED EQUAL.
- 5. EXISTING UTILITIES SHOWN ARE APPROXIMATE. CONTRACTOR SHALL VERIFY LOCATION OF EXISTING UTILITIES PRIOR TO CONSTRUCTION.
- 6. ALL PENETRATIONS TO THE EXISTING WET WELL SHALL BE WATER TIGHT.
- 7. EACH GRINDER PUMP STATION SITE IS WITHIN AN EXISTING EASEMENT ON PRIVATE LAKEFRONT PROPERTY WITH LIMITED ACCESSIBILITY FOR LARGE EQUIPMENT AND MOTOR VEHICLES. THE MEANS AND METHODS FOR MOBILIZATION OF MATERIALS AND EQUIPMENT TO EACH SITE SHALL BE AT THE OPTION OF THE CONTRACTOR. HAND DIGGING AND/OR BARGING IN EQUIPMENT MAY BE NECESSARY FOR COMPLETION OF THE WORK SHOWN ON THE PLANS AND DESCRIBED IN THE SPECIFICATIONS.

**LEGEND**:

- 1 HYDROMATIC HPGX 200 SUBMERSIBLE SEWAGE GRINDER PUMP TO BE PROVIDED BY OWNER AND INSTALLED BY CONTRACTOR.
- SS LIFTING CHAIN TO BE PROVIDED BY OWNER AND INSTALLED BY CONTRACTOR.
- 1-1/4" X 2" BERS-0125 CONERY DISCHARGE ELBOW TO BE PROVIDED BY OWNER AND INSTALLED BY CONTRACTOR.
- 1" SS PUMP GUIDE RAIL SYSTEM AND GUIDE BRACKET TO BE PROVIDED BY OWNER AND INSTALLED BY CONTRACTOR.
- GUIDE BRACKET SUPPORT PER DETAIL 4, SHEET 4.
- 6 2" X 1-14" 316 SS REDUCING BUSHING.
- (7) 1-1/4" DIA. 316 SS THREADED NIPPLE (LENGTH TO FIT).
- (8) 1-1/4" 316 SS UNION, THREADED.
- (9) 1-1/4" DIA. 316 SS THREADED 2" NIPPLE.
- 1-1/4" SS 90° BEND, THREADED.
- 1-1/4" 316 SS DISCHARGE HUB, SFC 125 BY CONERY OR APPROVED
- 1-1/4 BRONZE SWING CHECK VALVE.
- 1-1/4" DIA. SCH. 80 PVC THREADED 3" NIPPLE.
- 1-1/4" BRONZE BALL VALVE, FIPT X FIPT WITH LEVER.
- 1-1/4" DIA. SCH. 80 PVC THREADED 2" NIPPLE.
- 1-1/4" 90° BEND, SCH. 80 PVC THREADED
- 1-1/4" DIA. SCH. 80 PVC THREADED NIPPLE (LENGTH TO FIT).

- BYPASS-PUMPING CONNECTION. SEE DETAIL 2, SHEET 4.
- (19) 1-1/4" TEE, SCH 80 PVC THREADED.
- 1-1/4" DIA. SCH. 80 PVC CLOSE NIPPLE, THREADED.
- 1-1/4" DIA. SCH. 80 PVC NIPPLE, THREADED X PLAIN END (LENGTH TO FIT).
- 1-1/4" 90° BEND, SCH. 80 PVC SOCKET WELDED.
- 2" X 1-1/4" REDUCING TEE, SCH. 80 PVC SOCKET WELDED.
- 2" BRONZE BALL VALVE, FITP X FITP WITH 2" OPERATING NUT AND VALVE BOX PER MODIFIED STANDARD DETAIL 11. SHEET 4.
- 2" DIA. SCH. 80 PVC NIPPLE THREADED X PLAIN END (LENGTH TO FIT).
- 2" COUPLING, SCH. 80 PVC SOCKET WELDED.
- 2-1/2" X 2" REDUCER, SCH. 80 PVC SOCKET WELDED.
- 2-1/2" COUPLING, SCH. 80 PVC SOCKET WELDED.
- 24" X 36" VALVE BOX. DURALITE 2436 BY OLDCASTLE WITH PENTA HEAD BOLT DOWN SOLID T-COVER, OR APPROVED EQUAL.
- CONCRETE BLOCK FOR PIPE SUPPORT AS REQUIRED (TYP).
- FLOAT LEVEL SWITCH TO BE PROVIDED BY OWNER AND INSTALLED BY CONTRACTOR. CONTRACTOR SHALL FURNISH AND INSTALL 316 SS FLOAT SUPPORT T-TYPE BRACKET, 4FB BY CONERY WITH G1 CORD GRIPS OR APPROVED EQUAL.
- CONTRACTOR SHALL PROVIDE MIN. 1/4" THICK 316 SS PLATE TO MOUNT BASE ELBOW TO. CONTRACTOR SHALL FIELD LOCATE HOLE FOR NEW BASE PLATE, CUT HOLE TO FIT TIGHT OVER NUT OF EXISTING ANCHOR BOLT, AND WELD EXISTING NUT TO NEW BASEPLATE.

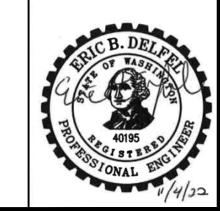

INSTALL NEW CLEANOUT ON EXISTING INLET PIPING PER DETAIL 9 SHEET, 4.

F THIS BAR DOES NOT MEASURE 1 THEN DRAWING


DATE

**REVISION** 

**BID SET** 

NO BY APPD

WARNING Gray & Osborne, Inc IS NOT TO SCALE

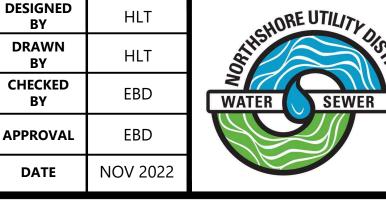

# **NORTHSHORE UTILITY DISTRICT**

6830 NE 185th St. Kenmore, WA 98028-2684

P.O. Box 82489 Kenmore, WA 98028-2684

Ph: (425) 398-4400 | Fax: (425) 398-4430 | www.nud.net

GRINDER PUMP STATIONS 1-4 REPLACEMENT

## PROPOSED GRINDER PUMP STATION 3


**CONTRACT 2022-01** 


BASE MAP H4

SHEET

C2003

<u>18</u> of <u>30</u>

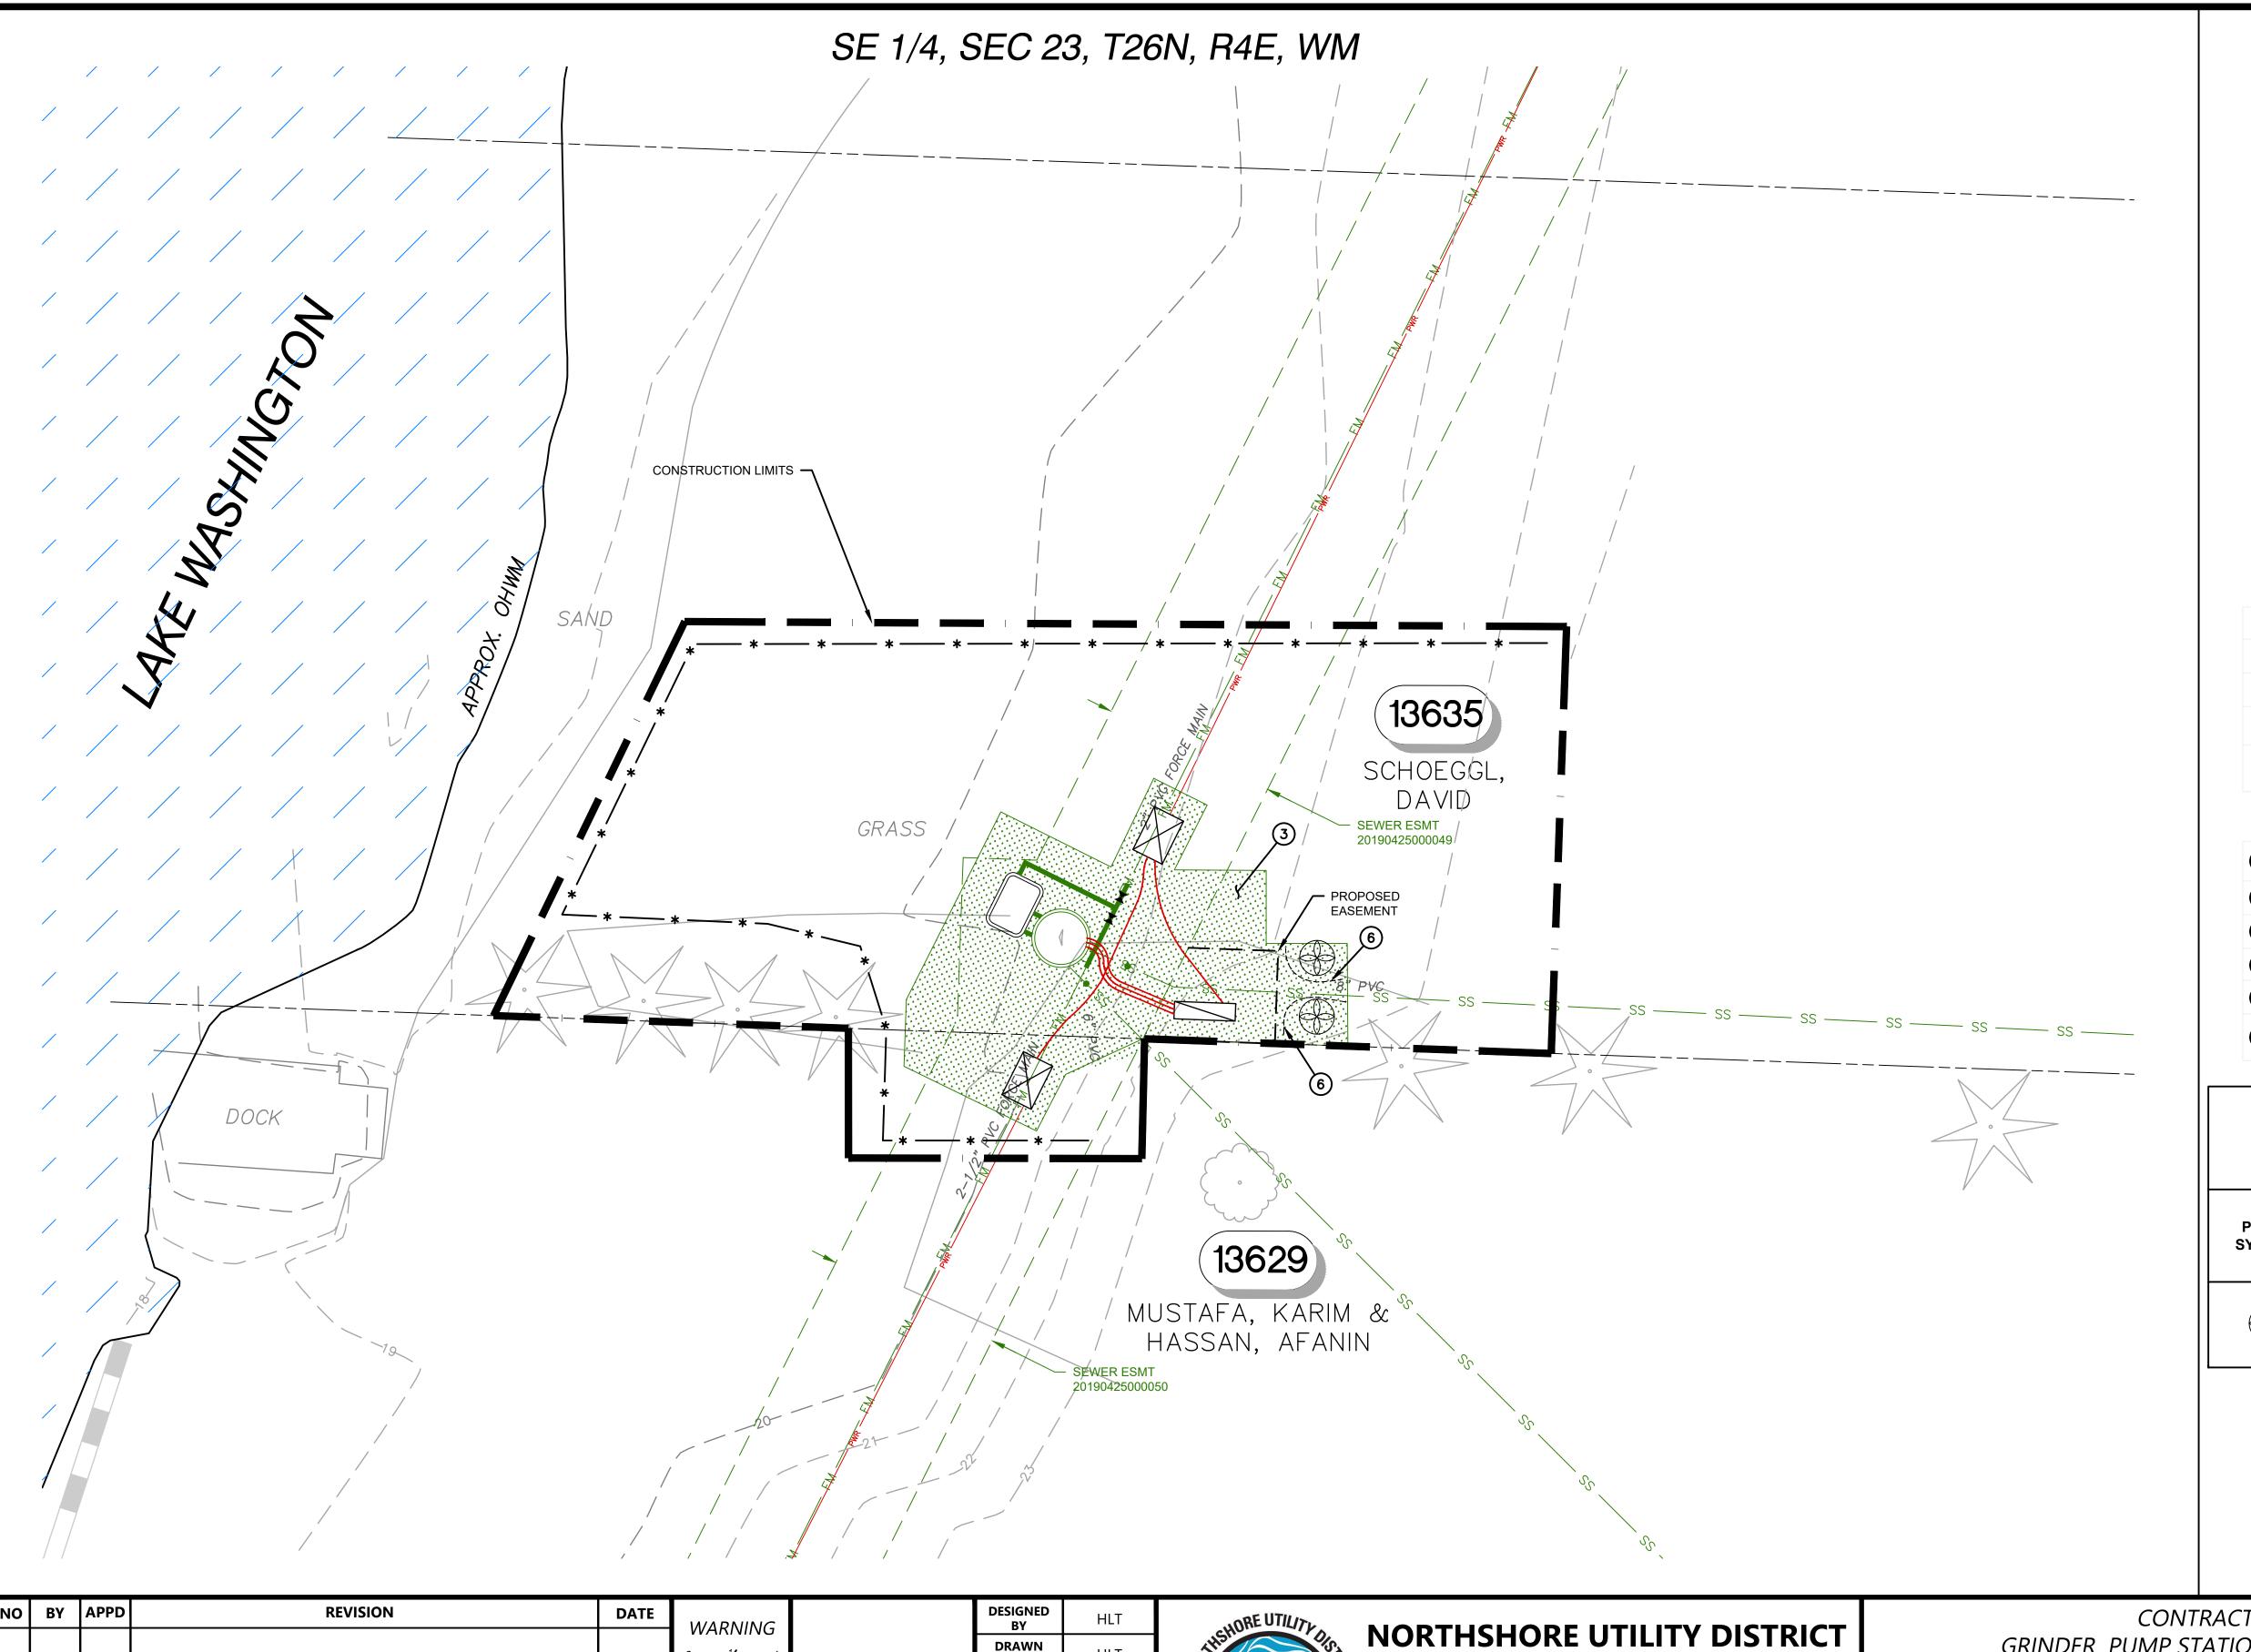

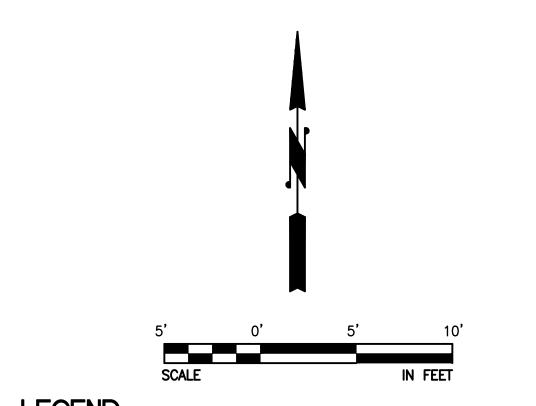

#### **LEGEND**

SAND RESTORATION



RIVER ROCK REPAIR

LANDSCAPE RESTORATION

### **GENERAL NOTES**


- 1. SEE SPECIFICATIONS FOR WORK AND PAYMENT INCLUDED IN GENERAL
- 2. GRASS AREAS THAT ARE DAMAGED BY THE CONTRACTOR SHALL BE RESTORED WITH 4" OF TOPSOIL AND SOD PER THE SPECIFICATIONS.
- 3. PROTECT/RESTORE ALL LANDSCAPING AND SURFACE FEATURES TO EXISTING CONDITION OR BETTER.
- 4. GRADE SITE TO UNIFORM SLOPE AROUND NEW UTILITY BOXES. PROVIDE 30" OF CLEAR LEVEL SPACE IN FRONT OF NEW CONTROL PANNEL(S).
- 5. PRIOR TO COMMENCING CONSTRUCTION, THE CONTRACTOR SHALL COORDINATE WITH THE DISTRICT AND THE PROPERTY OWNERS REGARDING THE REMOVAL AND
- RESTORATION NOTES
- RESTORE BEACH SAND TO EXISTING CONDITION. ANY IMPORTED SAND SHALL MATCH THE COLOR AND GRADATION OF THE EXISTING SAND.
- RESTORE WALL TO EXISTING CONDITION.
- RESTORE EXISTING LANDSCAPING, TOPSOIL, AND SOD AS APPLICABLE TO PRE-CONSTRUCTION CONDITIONS, OR BETTER.

RESTORATION OF EXISTING LANDSCAPE FEATURES.

- RELOCATE EXISTING ROCKERY AS SHOWN TO ACCOMMODATE NEW FACILITIES.
- 5 INSTALL RIVER ROCK TO 3" DEPTH. ANY IMPORTED MATERIAL SHALL MATCH THE EXISTING RIVER ROCK.
- INSTALL ROOT BARRIER BETWEEN NEW PLANTS AND ALL UTILITIES AS SHOWN AND AS DIRECTED BY THE CONTRACTING AGENCY. ROOT BARRIERS SHALL BE "DEEP ROOT" MODEL NO. UB 36-2 OR APPROVED EQUAL.

#### **PLANT SCHEDULE**

PLANT SYMBOL	COMMON NAME/ BOTANICAL NAME	MINIMUM SIZE	NO. OF PLANTS			
	PORTUGUESE LAUREL/ PRUNUS LUSITANICA	5 GAL	2			

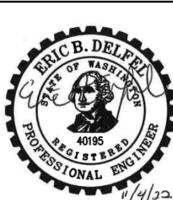


NO	ВҮ	APPD	REVISION	DATE	WARNING
					VVARIVING  0 1/2 1
					IF THIS BAR DOES
					NOT MEASURE 1" THEN DRAWING
			DID CET		IS NOT TO SCALE

**BID SET** 



DRAWN CHECKED DATE NOV 2022

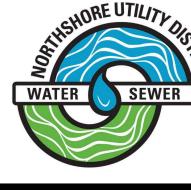

6830 NE 185th St. Kenmore, WA 98028-2684 P.O. Box 82489 Kenmore, WA 98028-2684


Ph: (425) 398-4400 | Fax: (425) 398-4430 | www.nud.net


**CONTRACT 2022-01** GRINDER PUMP STATIONS 1-4 REPLACEMENT


**GRINDER PUMP STATION 3 RESTORATION PLAN** 

BASE MAP H4 C2003 SHEET

<u>19</u> of <u>30</u>

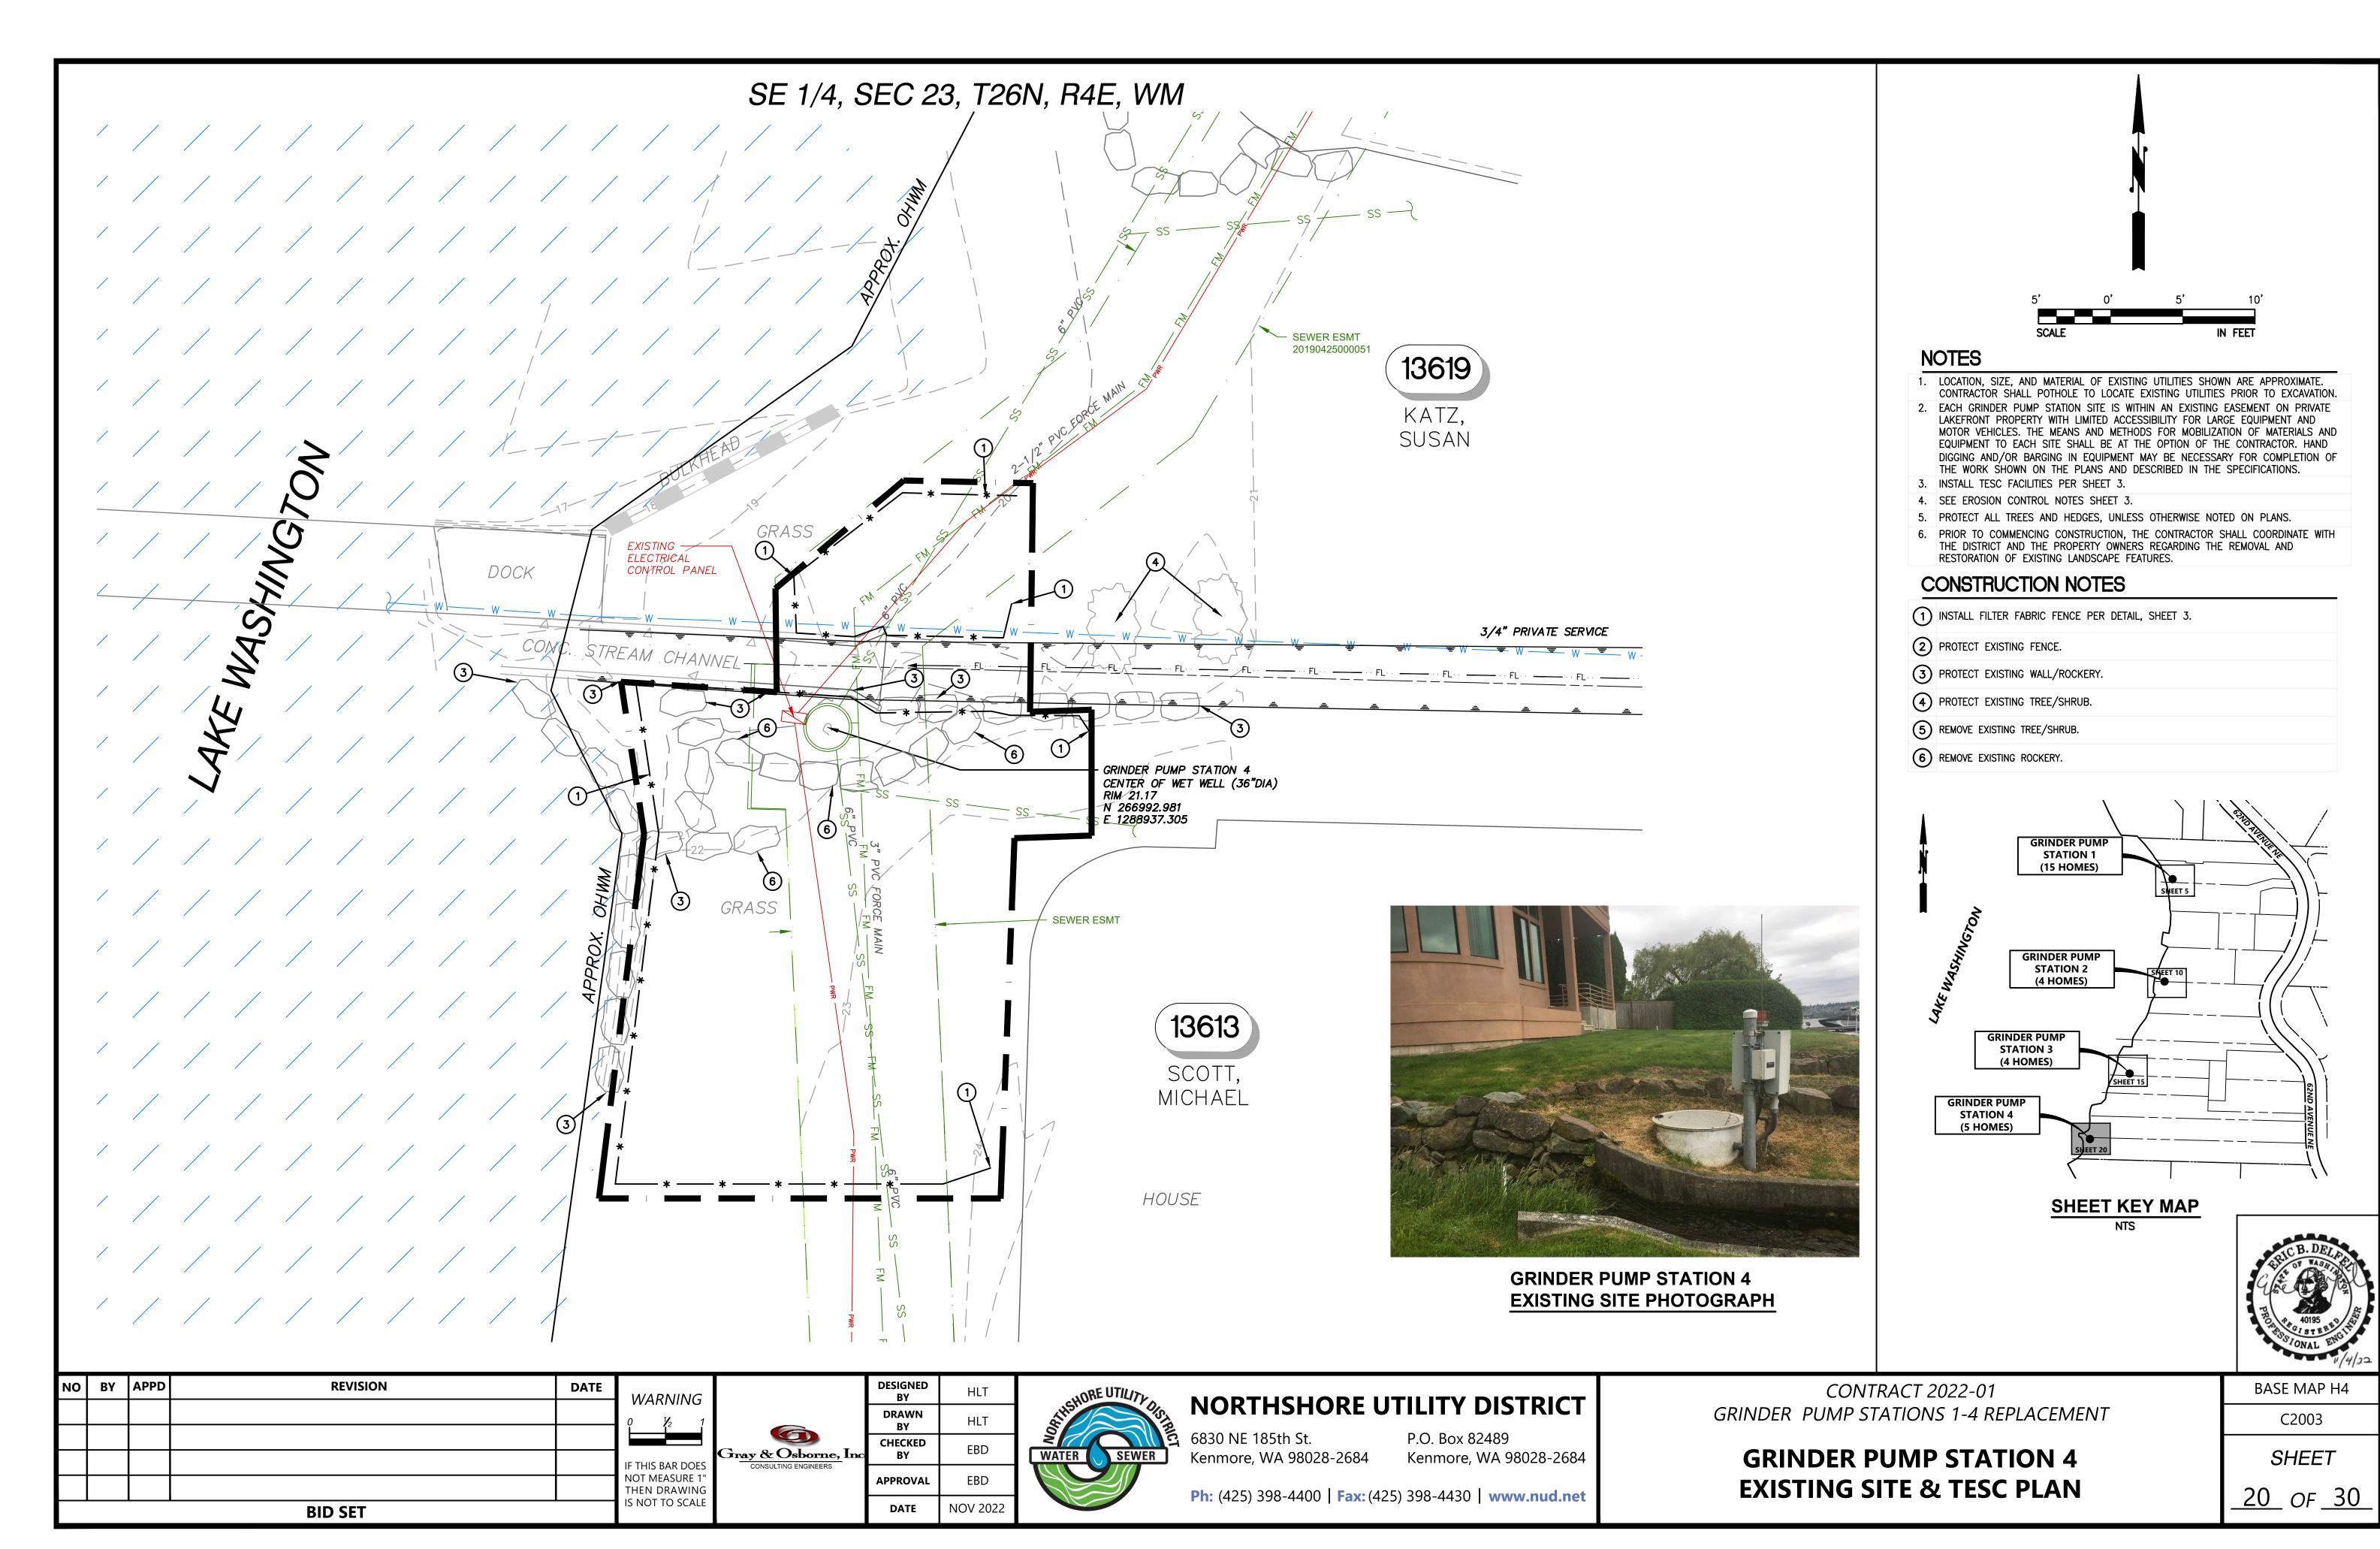

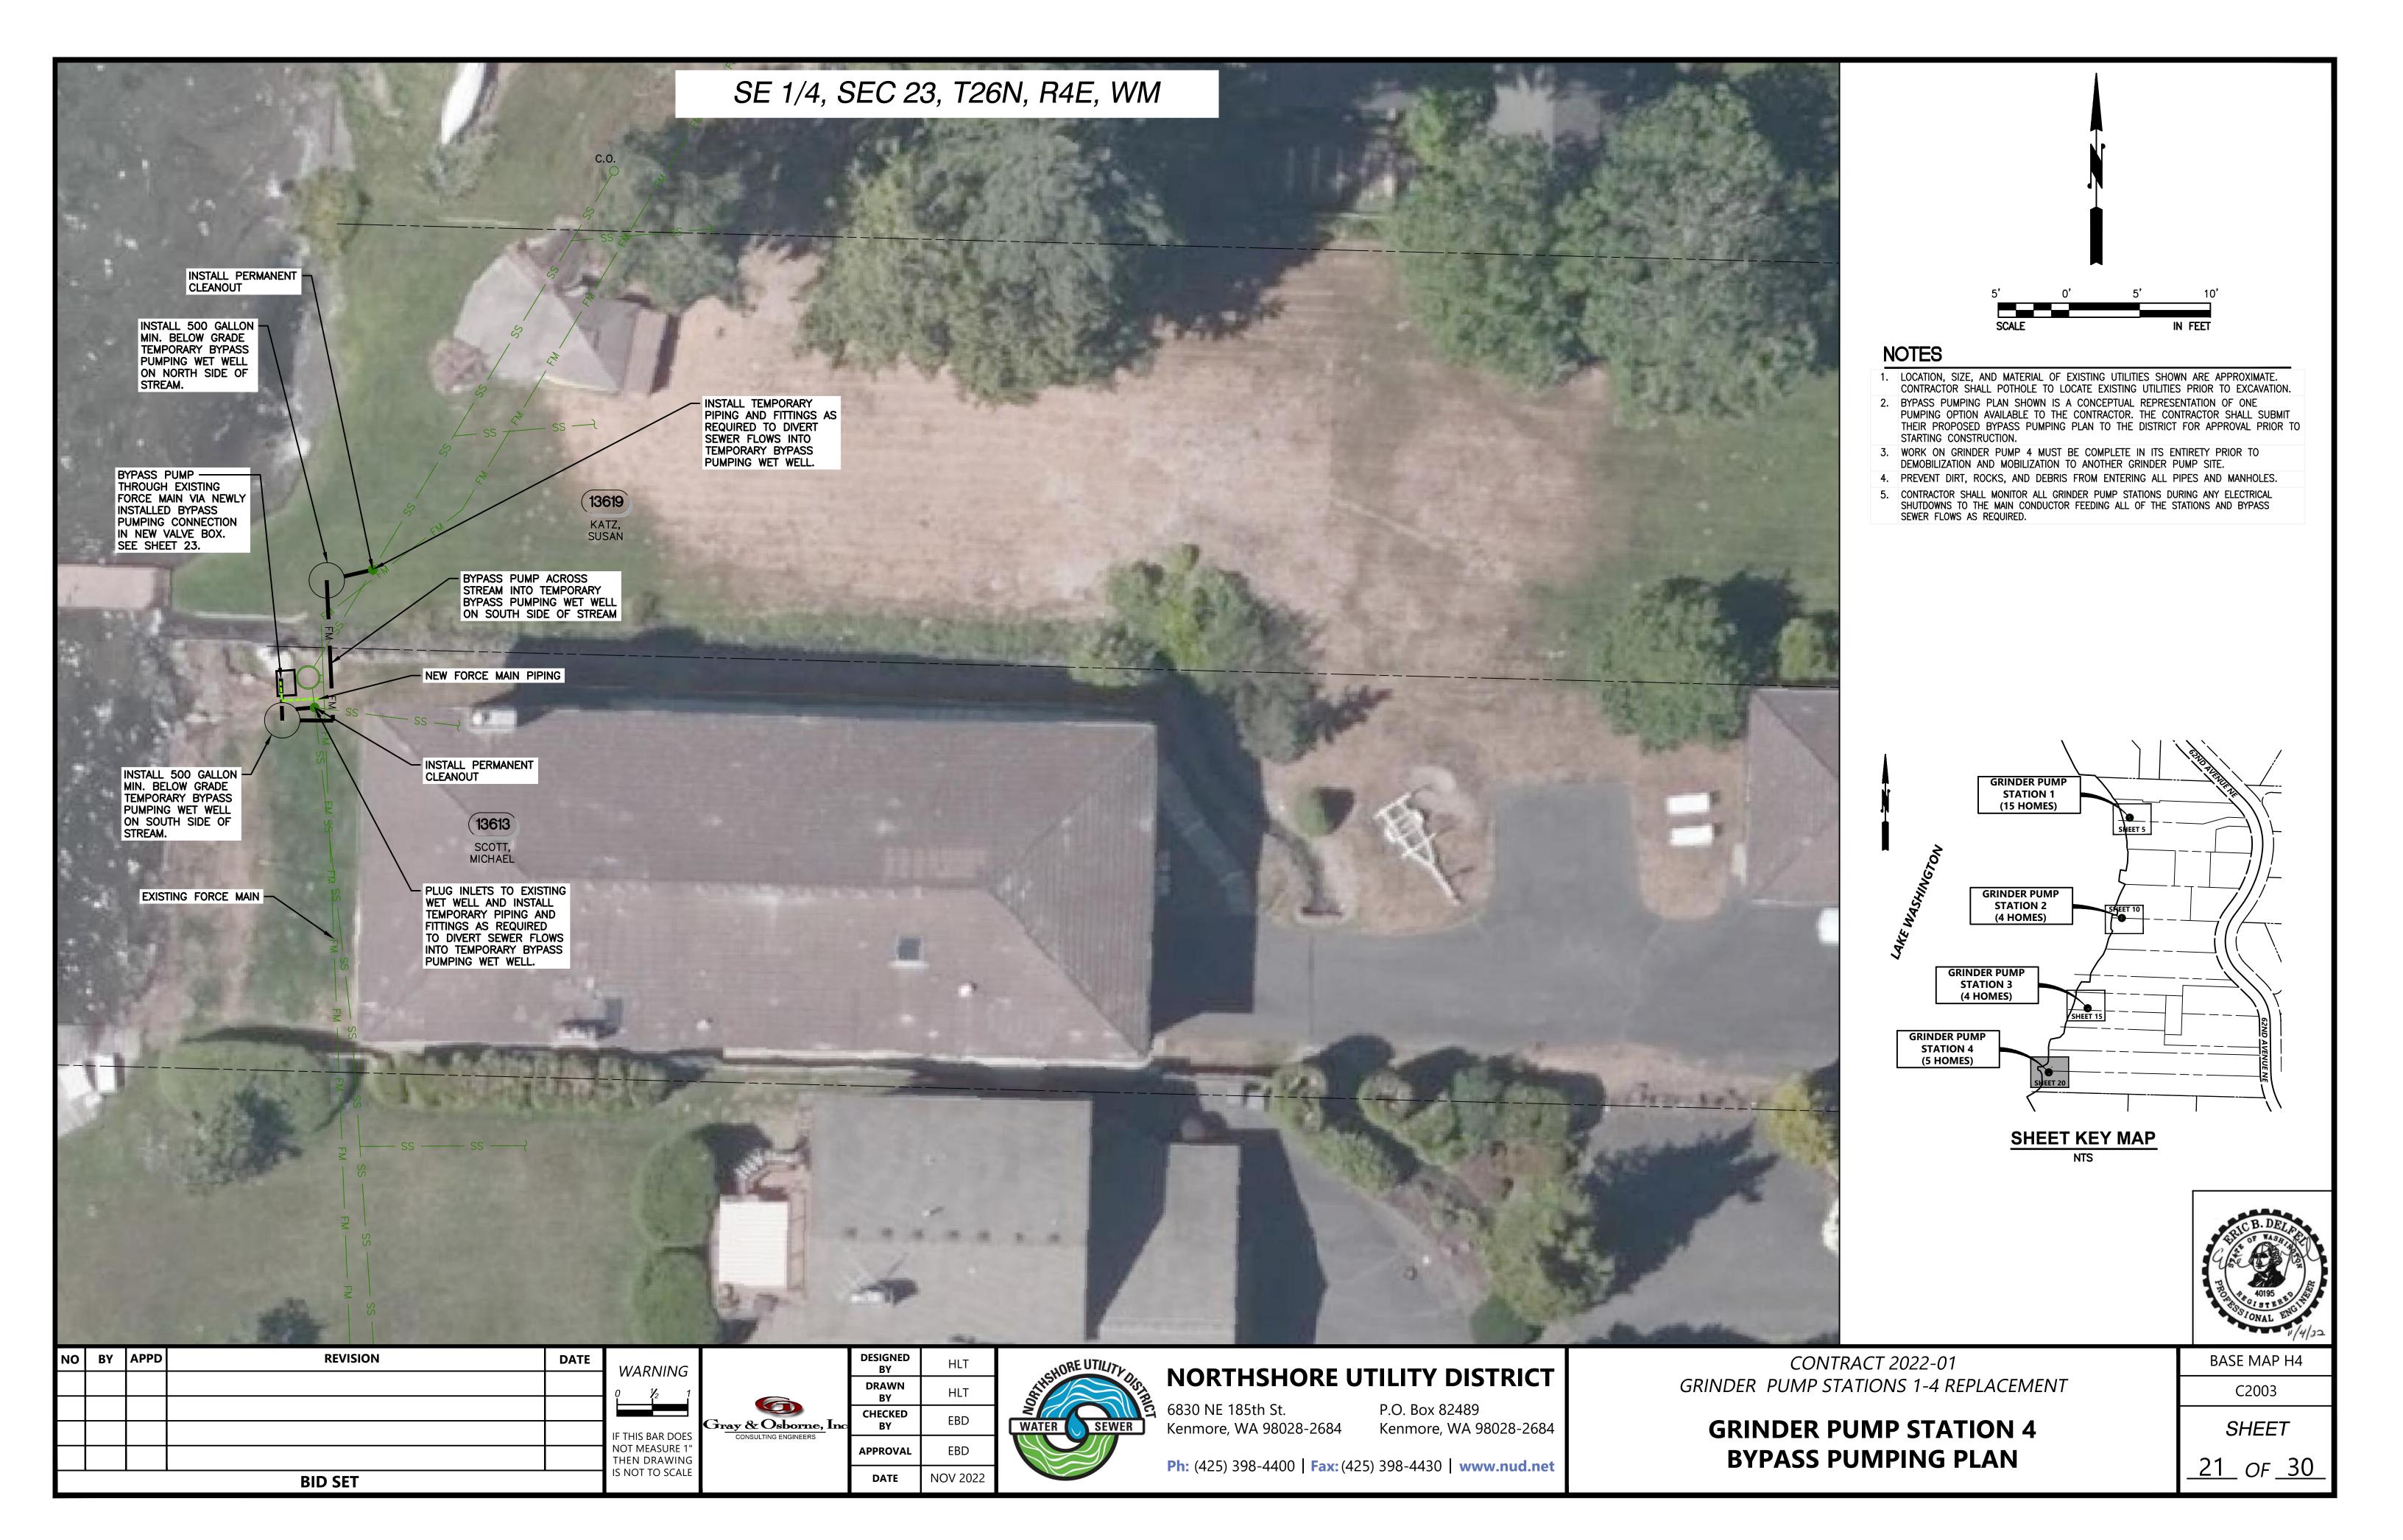

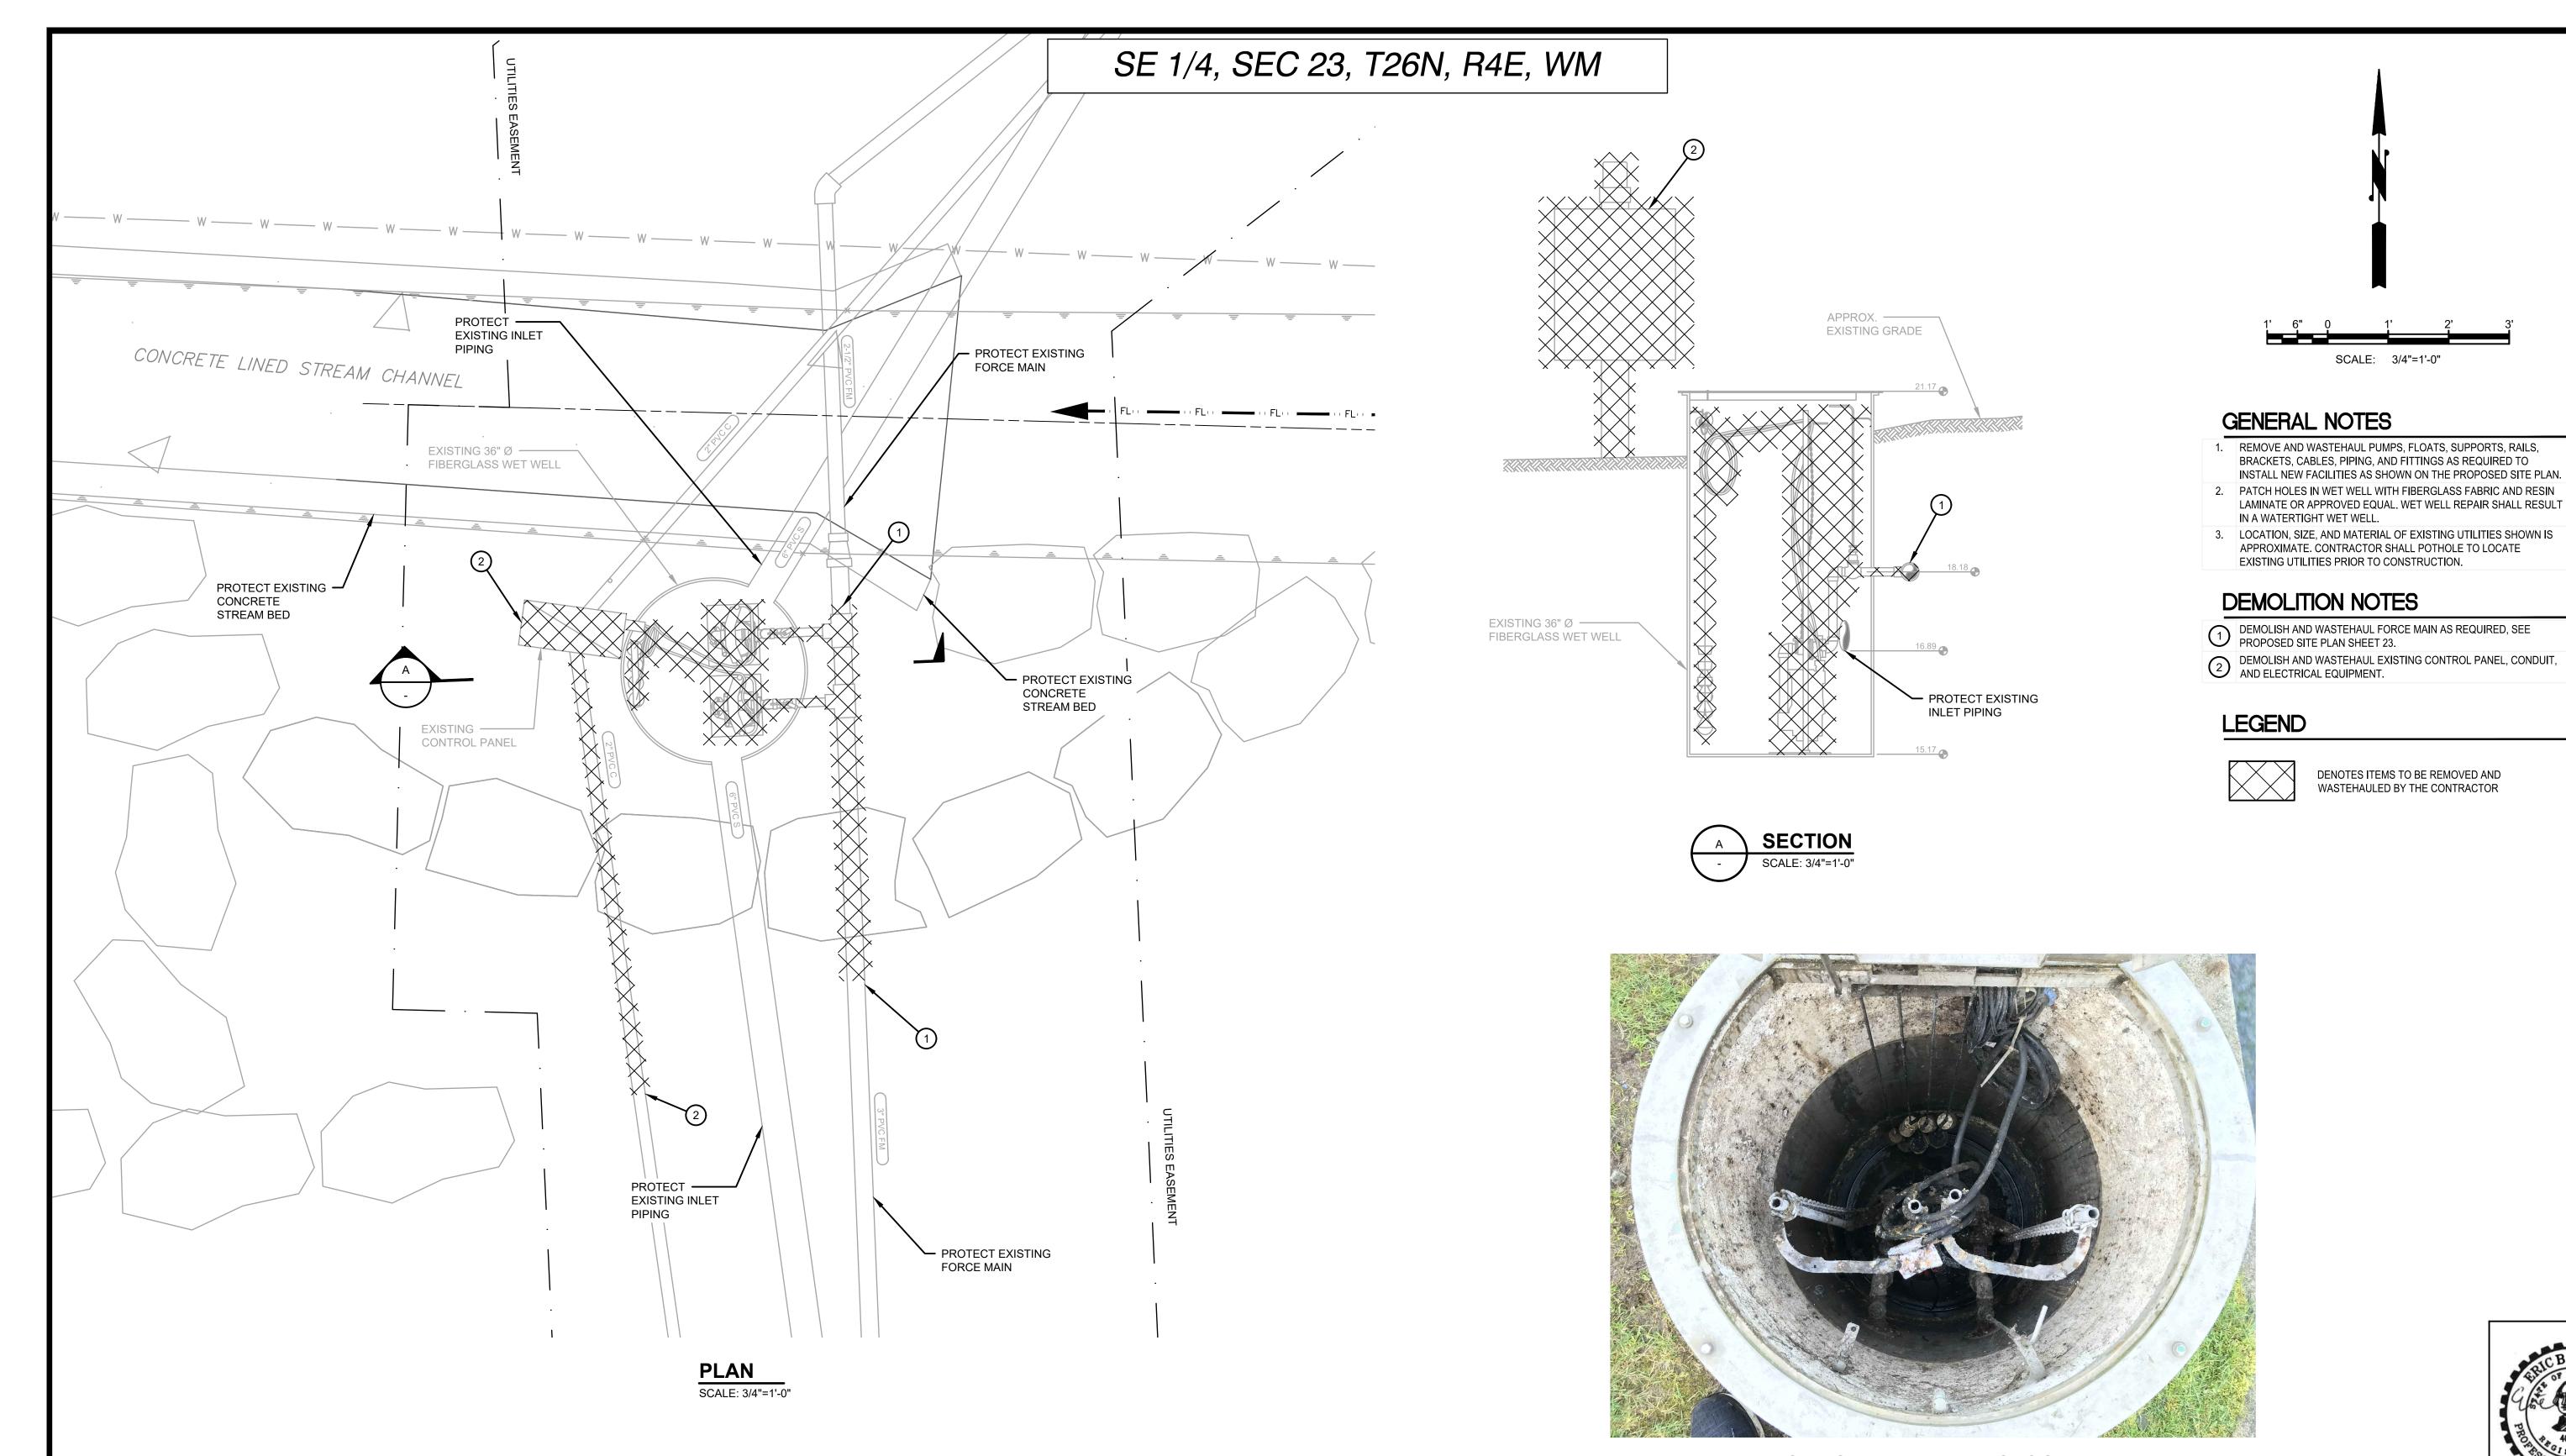



DESIGNED BY **NORTHSHORE UTILITY DISTRICT** DRAWN Gray & Osborne, Inc 6830 NE 185th St. P.O. Box 82489

NO BY APPD

**REVISION** 

**BID SET** 

DATE

WARNING

IF THIS BAR DOES NOT MEASURE 1" THEN DRAWING IS NOT TO SCALE

CHECKED

**APPROVAL** 

DATE

NOV 2022

Ph: (425) 398-4400 | Fax: (425) 398-4430 | www.nud.net

Kenmore, WA 98028-2684


Kenmore, WA 98028-2684

**CONTRACT 2022-01** GRINDER PUMP STATIONS 1-4 REPLACEMENT

## **GRINDER PUMP STATION 4 DEMOLITION**

BASE MAP H4
C2003

SHEET 22 OF 30

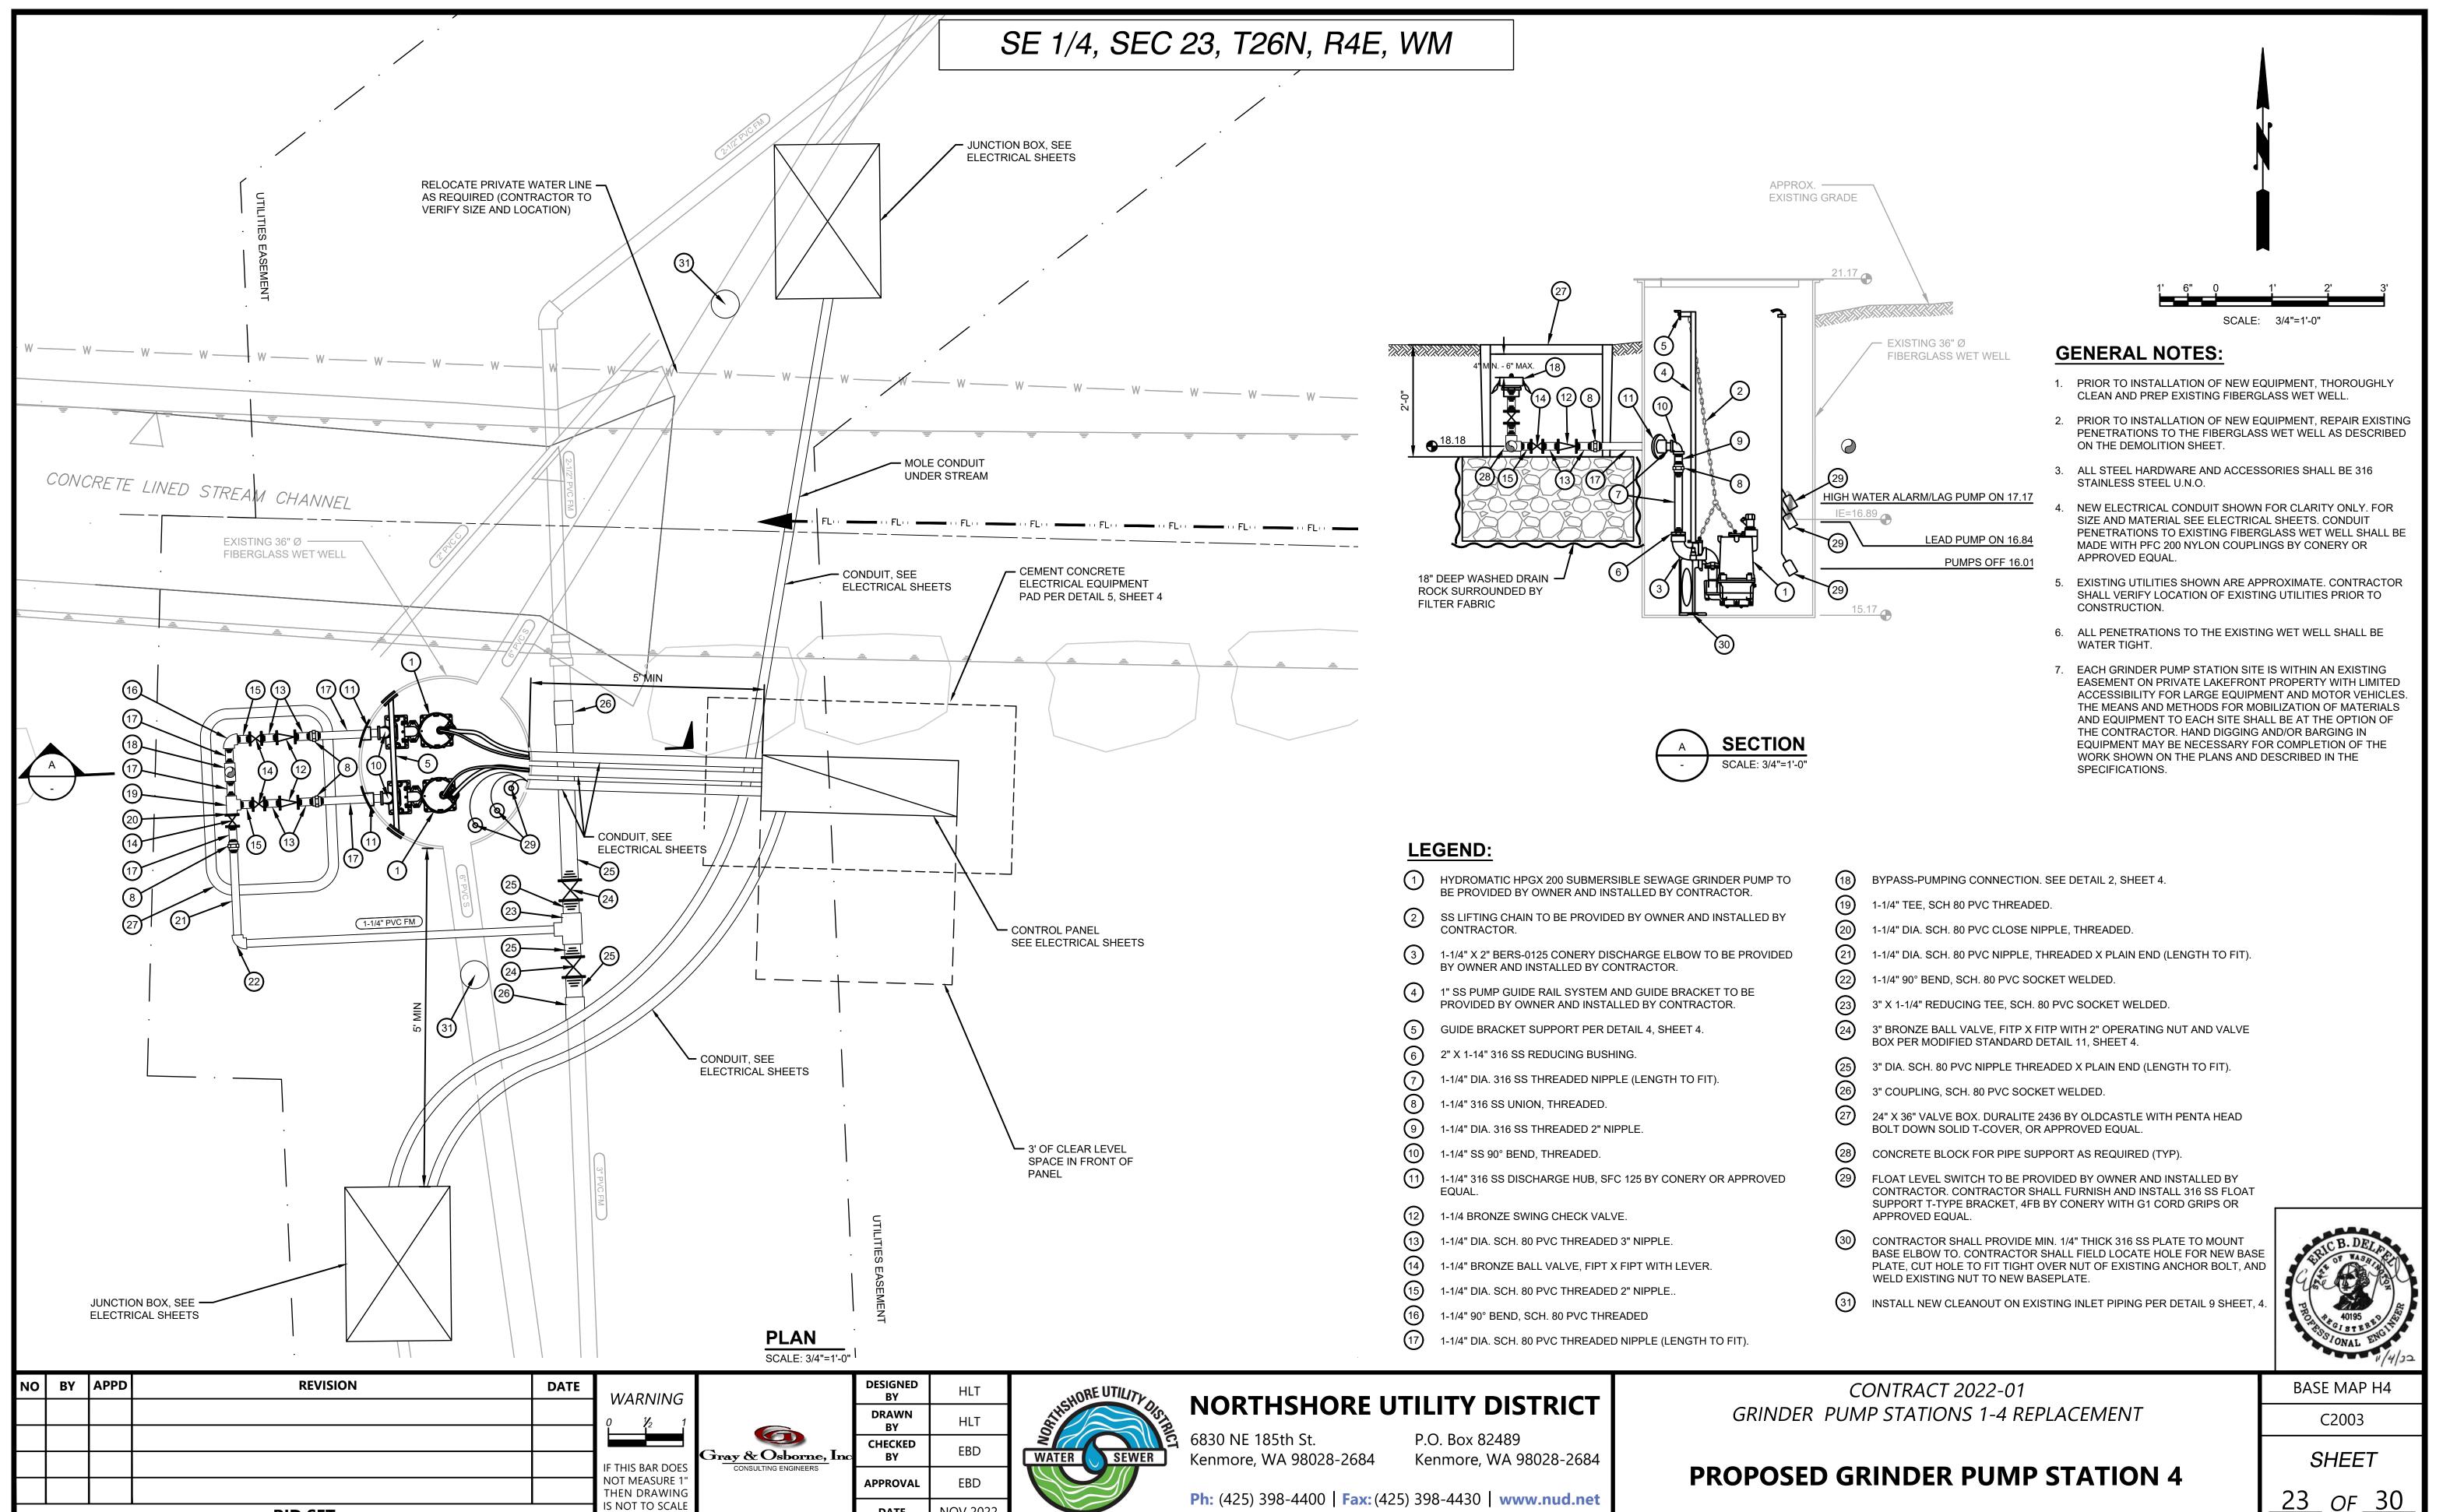



NOV 2022

DATE

**BID SET** 

<u>23</u> of <u>30</u>

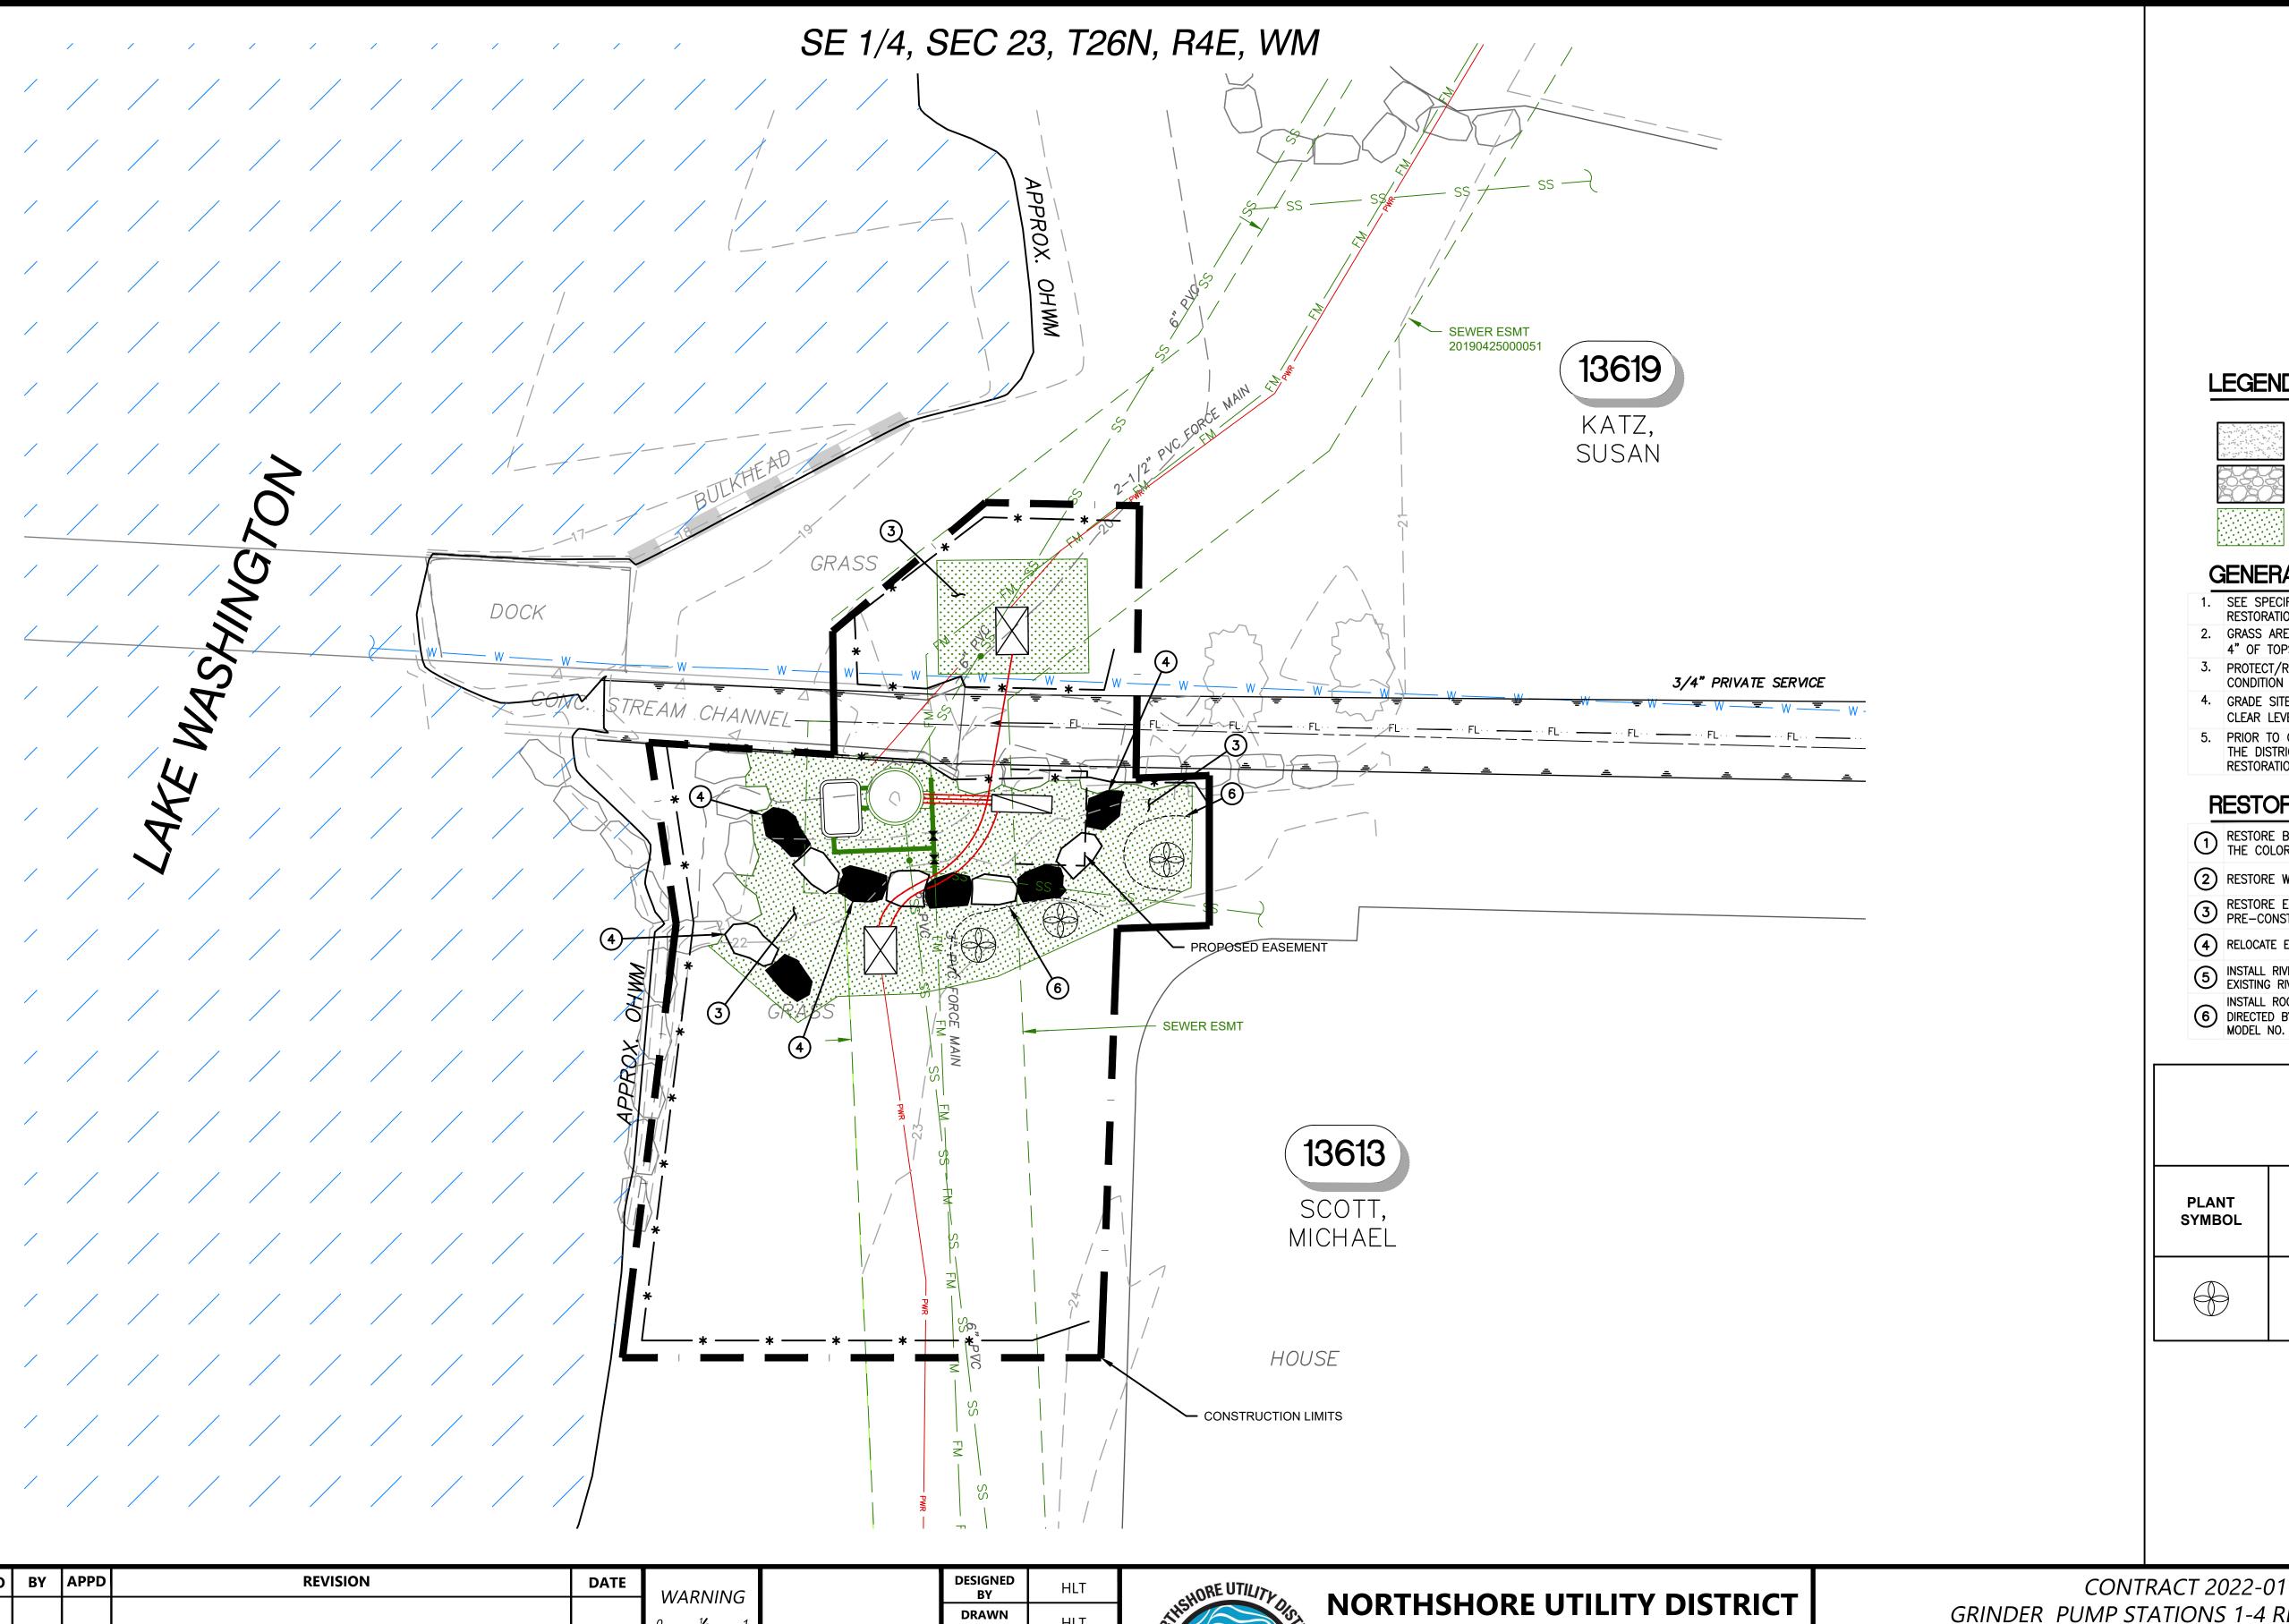

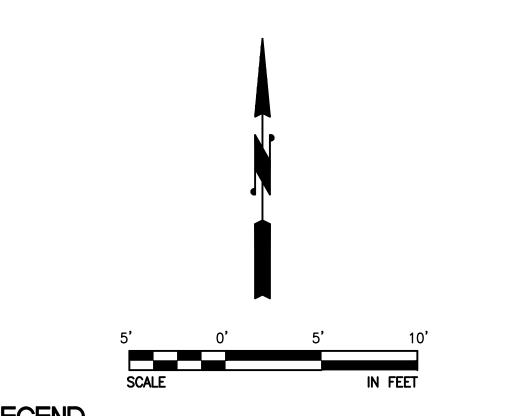

#### **LEGEND**



SAND RESTORATION



RIVER ROCK REPAIR

LANDSCAPE RESTORATION

#### **GENERAL NOTES**


- 1. SEE SPECIFICATIONS FOR WORK AND PAYMENT INCLUDED IN GENERAL
- 2. GRASS AREAS THAT ARE DAMAGED BY THE CONTRACTOR SHALL BE RESTORED WITH 4" OF TOPSOIL AND SOD PER THE SPECIFICATIONS.
- 3. PROTECT/RESTORE ALL LANDSCAPING AND SURFACE FEATURES TO EXISTING CONDITION OR BETTER.
- 4. GRADE SITE TO UNIFORM SLOPE AROUND NEW UTILITY BOXES. PROVIDE 30" OF CLEAR LEVEL SPACE IN FRONT OF NEW CONTROL PANNEL(S).
- PRIOR TO COMMENCING CONSTRUCTION, THE CONTRACTOR SHALL COORDINATE WITH THE DISTRICT AND THE PROPERTY OWNERS REGARDING THE REMOVAL AND RESTORATION OF EXISTING LANDSCAPE FEATURES.

#### RESTORATION NOTES

- RESTORE BEACH SAND TO EXISTING CONDITION. ANY IMPORTED SAND SHALL MATCH THE COLOR AND GRADATION OF THE EXISTING SAND.
- (2) RESTORE WALL TO EXISTING CONDITION.
- RESTORE EXISTING LANDSCAPING, TOPSOIL, AND SOD AS APPLICABLE TO PRE-CONSTRUCTION CONDITIONS, OR BETTER.
- RELOCATE EXISTING ROCKERY AS SHOWN TO ACCOMMODATE NEW FACILITIES.
- [5] INSTALL RIVER ROCK TO 3" DEPTH. ANY IMPORTED MATERIAL SHALL MATCH THE EXISTING RIVER ROCK.
- INSTALL ROOT BARRIER BETWEEN NEW PLANTS AND ALL UTILITIES AS SHOWN AND AS 6 DIRECTED BY THE CONTRACTING AGENCY. ROOT BARRIERS SHALL BE "DEEP ROOT" MODEL NO. UB 36-2 OR APPROVED EQUAL.

#### **PLANT SCHEDULE**

PLANT SYMBOL	COMMON NAME/ BOTANICAL NAME	MINIMUM SIZE	NO. OF PLANTS
	PORTUGUESE LAUREL/ PRUNUS LUSITANICA	5 GAL	3

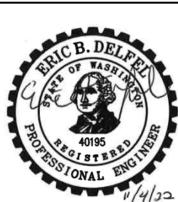

NO	ВҮ	APPD	REVISION	DATE	WARNING
					$0  \frac{1}{2}  1$
					IF THIS BAR DOES
					NOT MEASURE 1" THEN DRAWING

**BID SET** 

Gray & Osborne, In

CHECKED **APPROVAL** DATE NOV 2022



6830 NE 185th St. Kenmore, WA 98028-2684

Kenmore, WA 98028-2684 Ph: (425) 398-4400 | Fax: (425) 398-4430 | www.nud.net

P.O. Box 82489


GRINDER PUMP STATIONS 1-4 REPLACEMENT

**GRINDER PUMP STATION 4 RESTORATION PLAN** 

BASE MAP H4 C2003

SHEET

<u>24</u> of <u>30</u>

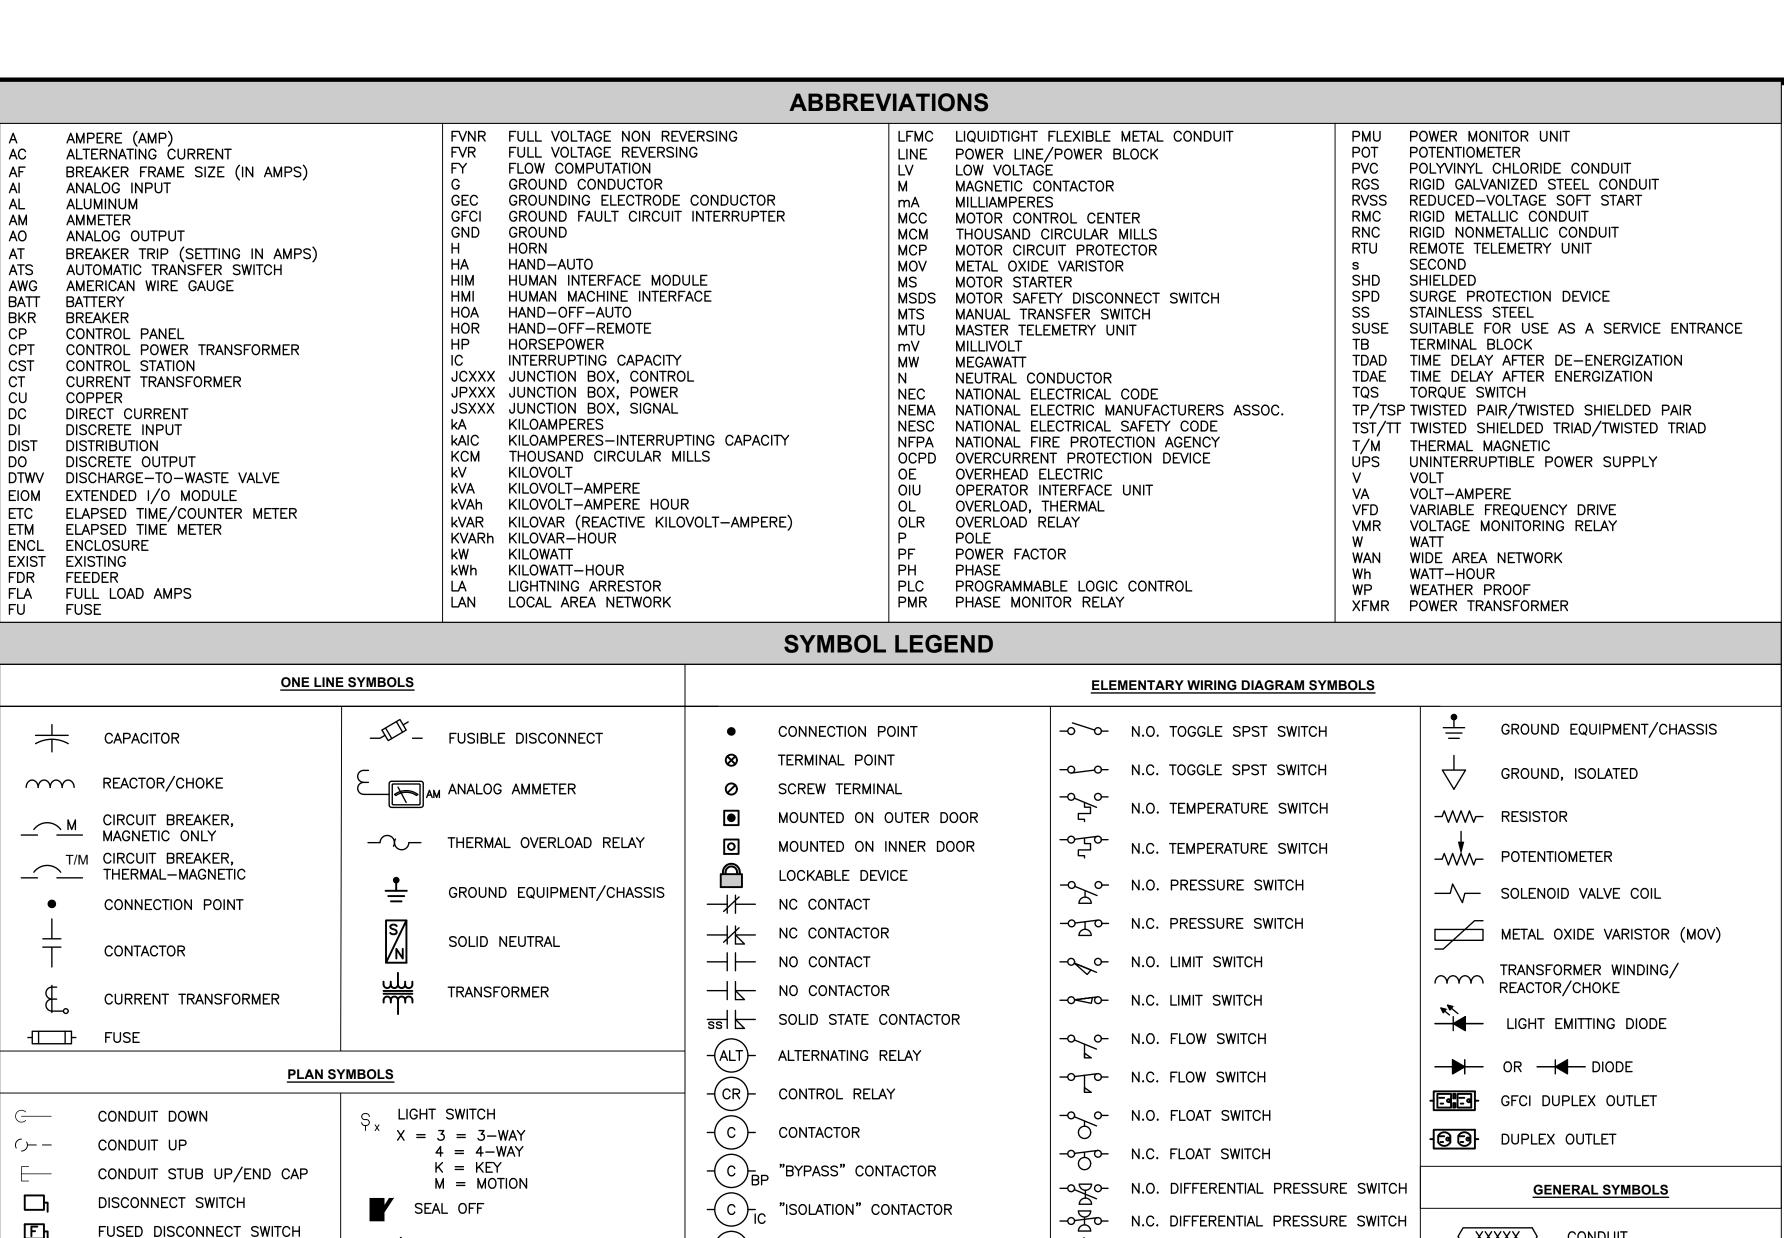

SOLID STATE CONTACT RELAY

TIME DELAY RELAY (TDAE)

TIME DELAY RELAY (TDAD)

X = REFERENCE LIGHTING

SCHEDULE IF APPLICABLE

"PUSH TO TEST" LED PILOT LIGHT

R = RED

W = WHITE

MOTOR RELAY

LIGHT FIXTURE

B = BLUE

G = GREEN

FUSED SWITCH W/ LED

-O- TDAE, N.O., TIME DELAY CLOSE,

TIME DELAY RE-OPEN

TIME DELAY RE-CLOSE

INSTANTANEOUS RE-OPEN

TDAE, N.C., TIME DELAY OPEN,

TDAD, N.O., INSTANTANEOUS CLOSE,

TDAD, N.C., INSTANTANEOUS OPEN,

INSTANTANEOUS RE-CLOSE

FUSE

#### < xxxxx > CONDUIT TAG LABEL XX XXXX XX GFCI PANELBOARD CIRCUIT - N.O. MUSHROOM PUSHBUTTON AREA ID TAG -o⊥o- N.C. MUSHROOM PUSHBUTTON **DEMOLITION (DEMO)** ON 、 RESET INTRINSICALLY SAFE AREA -0 $\sqrt{0}$ $\sqrt{x}$ 11111. CLEARANCE AREA <u>LINETYPES</u> ON-OFF-RESET EXPOSED CONDUIT ---- underground (buried) conduit GROUNDING ELECTRODE CONDUCTORS EMBEDDED CONDUIT **SWITCHES** (WALLS, CONCRETE, ETC.)

#### **GENERAL ELECTRICAL NOTES:**

#### SITE AND BUILDING PLANS:

- CONDUIT ROUTING IS SHOWN SCHEMATICALLY. ACTUAL ROUTING MAY BE MORE DIRECT AND IS LEFT TO THE CONTRACTOR FOLLOWING SPECIFICATIONS 16130. NON-ELECTRICAL BURIED PIPING HAS ROUTING PRIORITY OVER ELECTRICAL BURIALS.
- 2. ALL TRENCHING SHALL BE PER
- CONTRACTOR SHALL PROTECT EXISTING UTILITIES.
- THROUGHOUT THIS DOCUMENT, THE TERM "DEMO", "DEMOLISH", AND "REMOVE" MEANS TO REMOVE. THEN WASTEHAUL OR RETURN TO THE OWNER, PER THE OWNER'S DIRECTION.

#### **GENERAL CONTROL PANEL NOTES:**

- UNLESS SPECIFICALLY NOTED OTHERWISE ON THE CONTROL PANEL DETAILS, THE FOLLOWING NOTES APPLY.
- 1.1 ALL ENCLOSURES SHALL BE PROVIDED WITH AN ENGRAVED PHENOLIC NAMEPLATE, RED WITH WHITE LETTERING, CORRESPONDING TO THE ASSOCIATED TAG ID NUMBER AND TAG DESCRIPTION.

TAG DESCRIPTION "[" TAG NUMBER "]"

#### **OUTDOOR INSTALLATIONS:**

- ALL MOUNTING HARDWARE SHALL BE 316L STAINLESS STEEL
- ALL EXPOSED PORTIONS OF CONDUITS SHALL BE PVC-COATED RGS UNLESS SPECIFICALLY NOTED OTHERWISE.
- ALL CONNECTIONS INTO ENCLOSURES SHALL BE WATERTIGHT, MADE INTO THE BOTTOM OF THE PANELS, USING MYER-TYPE HUBS.
- PANELS MOUNTED ON EXTERIOR WALLS SHALL BE SUPPORTED TO THE WALL WITH 1/2-INCH (MINIMUM) 316L STAINLESS STEEL UNISTRUT.

#### **LOAD STUDY:**

A LOAD STUDY IS NOT PROVIDED AS THE FEEDER CIRCUIT ELECTRICAL LOADING IS NOT MODIFIED. A LOAD STUDY IS AVAILABLE UPON REQUEST.

#### **CABLE AND CONDUIT NOTES:**

- REFERENCE SPECIFICATION 16120 FOR CONDUCTORS, INSTRUMENTATION, COMMUNICATION, AND OTHER SPECIAL CABLES AND CONDUCTORS.
- REFERENCE SPECIFICATION 16130 FOR RACEWAY AND BOXES, JUNCTION BOX TYPES, AND HANDHOLE, PULLBOX, AND VAULT CONDUIT INSTALLATIONS.
- REFERENCE SPECIFICATIONS AND OUTDOOR INSTALLATION NOTES FOR CONDUIT COMPOSITION AND COATING.
- 4. CONDUIT TAGS ON PLAN SHEETS WITH A "~" (TILDE) SUFFIX REFER TO SPARE CONDUITS. EXAMPLE: (P0319~)
- 5. CABLE AND CONDUIT SCHEDULES:
  - 7.1 THE CABLE AND CONDUIT SCHEDULE PROVIDES CONDUIT NUMBER, SOURCE, DESTINATION, AND SIZE AS WELL AS CONDUCTOR AND CABLE REQUIREMENTS. REFERENCE SPECIFICATION 16130 FOR CONDUIT COMPOSITION AND COATING.
  - 7.2 CONDUITS MARKED WITH "\* n" (WHERE n = 1, 2, OR 3) SHALL BE 100% CONTINUOUS PER SPECIFICATION 16130.


SPECIFICALLY, CONDUITS MARKED WITH:

- "\* 1" NOT USED.
- \* 2" DENOTE INTRINSICALLY SAFE CIRCUITS, EITHER CONTROL OR INSTRUMENTATION.
- "\* 3" NOT USED.

#### **ELECTRICAL WORK SUMMARY:**

THIS SUMMARY OF ELECTRICAL WORK IS INCLUDED AS A COURTESY AND IS INTENDED TO PROVIDE A GENERAL UNDERSTANDING OF ELECTRICAL DESIGN INTENT AND MAJOR ELECTRICAL CONSTRUCTION TASKS. IT IS NOT PROVIDED AS A COMPLETE LIST OF WORK AND SHALL NOT BE USED FOR BIDDING PURPOSES. REFER TO ALL PLANS AND SPECIFICATIONS.


- 1. EXISTING GRINDER PUMP STATIONS NO. 1 THROUGH NO. 4 CONTROL PANELS WILL BE REPLACED WITH NEW CONTROL PANELS.
- 2. THE EXISTING GRINDER PUMP STATIONS POWER FEEDER FROM LIFT STATION NO. 15 WILL BE REUSED.
- 3. THE GRINDER PUMP STATIONS CONTROL PANELS WILL BE PROVIDED BY THE OWNER.
- 4. GRINDER PUMP STATION NO. 4 IS LOCATED CLOSEST TO LIFT STATION NO. 15. GRINDER PUMP STATION NO. 1 IS LOCATED FURTHEST FROM LIFT STATION NO. 15.
- 5. THE DESIGN INTENT IS TO INSTALL TWO PULL BOXES AT GRINDER PUMP STATIONS NO. 2. 3. AND 4 TO FACILITATE TAPPING THE EXISTING FEEDER AND PROVIDE FOR ROUTING MODIFICATION OF THE EXISTING FEEDER TO ACCOMMODATE THE NEW SITE LAYOUT.

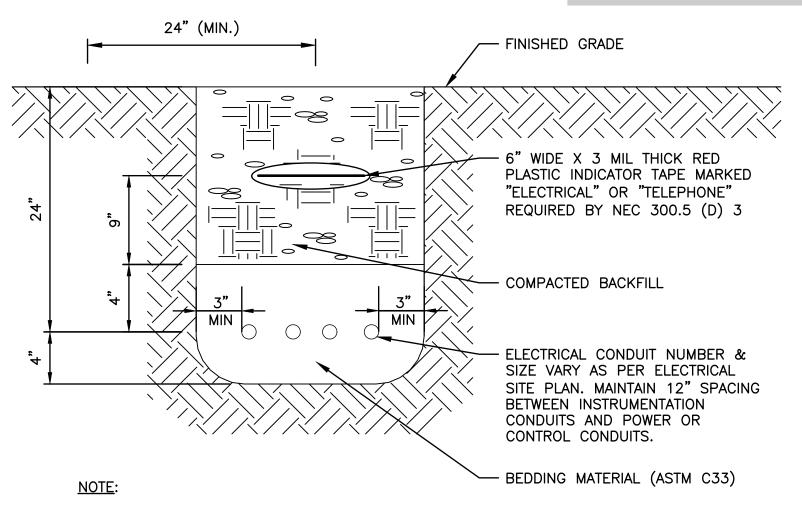

SPACING BETWEEN CONDUITS AND OTHER UTILITIES SHALL BE IN COMPLIANCE WITH THE UTILITIES OR 24 INCHES MINIMUM, WHICHEVER IS THE GREATER.

2. SEE CIVIL SHEETS FOR SURFACING RESTORATION.



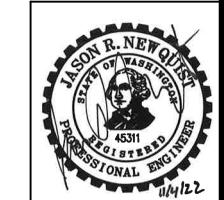

NO	BY	APPD	REVISION	DATE	WARNING
					0 % 1
					IF THIS BAR DOES
				-	NOT MEASURE 1" THEN DRAWING
					IS NOT TO SCALE

COMMUNICATION OUTLET

TELEPHONE OUTLET

SIMPLEX RECEPTACLE

DUPLEX RECEPTACLE

QUAD RECEPTACLE

#12 AWG GROUND CONDUCTOR

#12 AWG NEUTRAL CONDUCTOR

#12 AWG BRANCH CONDUCTOR

CROSSMARKS INDICATE QUANTITY AND USE

OF CONDUCTORS

SINGLE

DUPLEX RECEPTACLE (HIDDEN)

QUAD RECEPTACLE (HIDDEN)

FLOOR MOUNTED RECEPTACLE

LED LIGHT POLES

SPECIAL OUTLET

MOTOR X = HORSE POWER

FE FLOW ELEMENT

FI FLOW INDICATOR

FIT FLOW INDICATOR/

TRANSMITTER FS FLOW SWITCH

FT FLOW TRANSMITTER

INTRUSION SWITCH

JUNCTION BOX

LIMIT SWITCH

LE LEVEL ELEMENT

LI LEVEL INDICATOR

LIT LEVEL INDICATOR/

TRANSMITTER

LT LEVEL TRANSDUCER

PE PRESSURE ELEMENT

PI PRESSURE INDICATOR

PIT PRESSURE INDICATOR

PT PRESSURE TRANSMITTER

TRANSMITTER

PS PRESSURE SWITCH

SD SMOKE DETECTOR

SV SOLENOID VALVE

THERMOSTAT

SLS LEVEL SWITCH/FLOAT

MFM MAGNETIC FLOW METER

MOV MOTOR OPERATOR VALVE

MDT MOTION DETECTOR

PC PHOTO CELL

HD HEAT DETECTOR

(XX) XX=CV CHECK VALVE

VARNING Gray & Osborne, In HIS BAR DOES T MEASURE EN DRAWING

**DESIGNED** BY **DRAWN CHECKED APPROVAL** NOV 2022 DATE


- O O N.O. PUSHBUTTON

-مـلـه– N.C. PUSHBUTTON

HAND-OFF-AUTO

SWITCHES

-<u>o</u>\_xoo

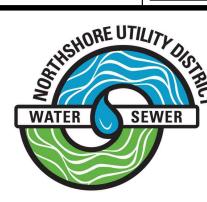

# NORTHSHORE UTILITY DISTRICT

6830 NE 185th St. Kenmore, WA 98028-2684

NOTE: UNLESS NOTED OTHERWISE.

THIS IS A GENERAL LEDGER SHEET. ALL

SYMBOLS MAY NOT APPLY.

P.O. Box 82489 Kenmore, WA 98028-2684

Ph: (425) 398-4400 | Fax: (425) 398-4430 | www.nud.net

**CONTRACT 2022-01** 


GRINDER PUMP STATIONS 1-4 REPLACEMENT

**ELECTRICAL SYMBOLS, ABBREVIATIONS, NOTES AND WORK SUMMARY** 

BASE MAP H4 C2003

SHEET

<u>25</u> of <u>30</u>

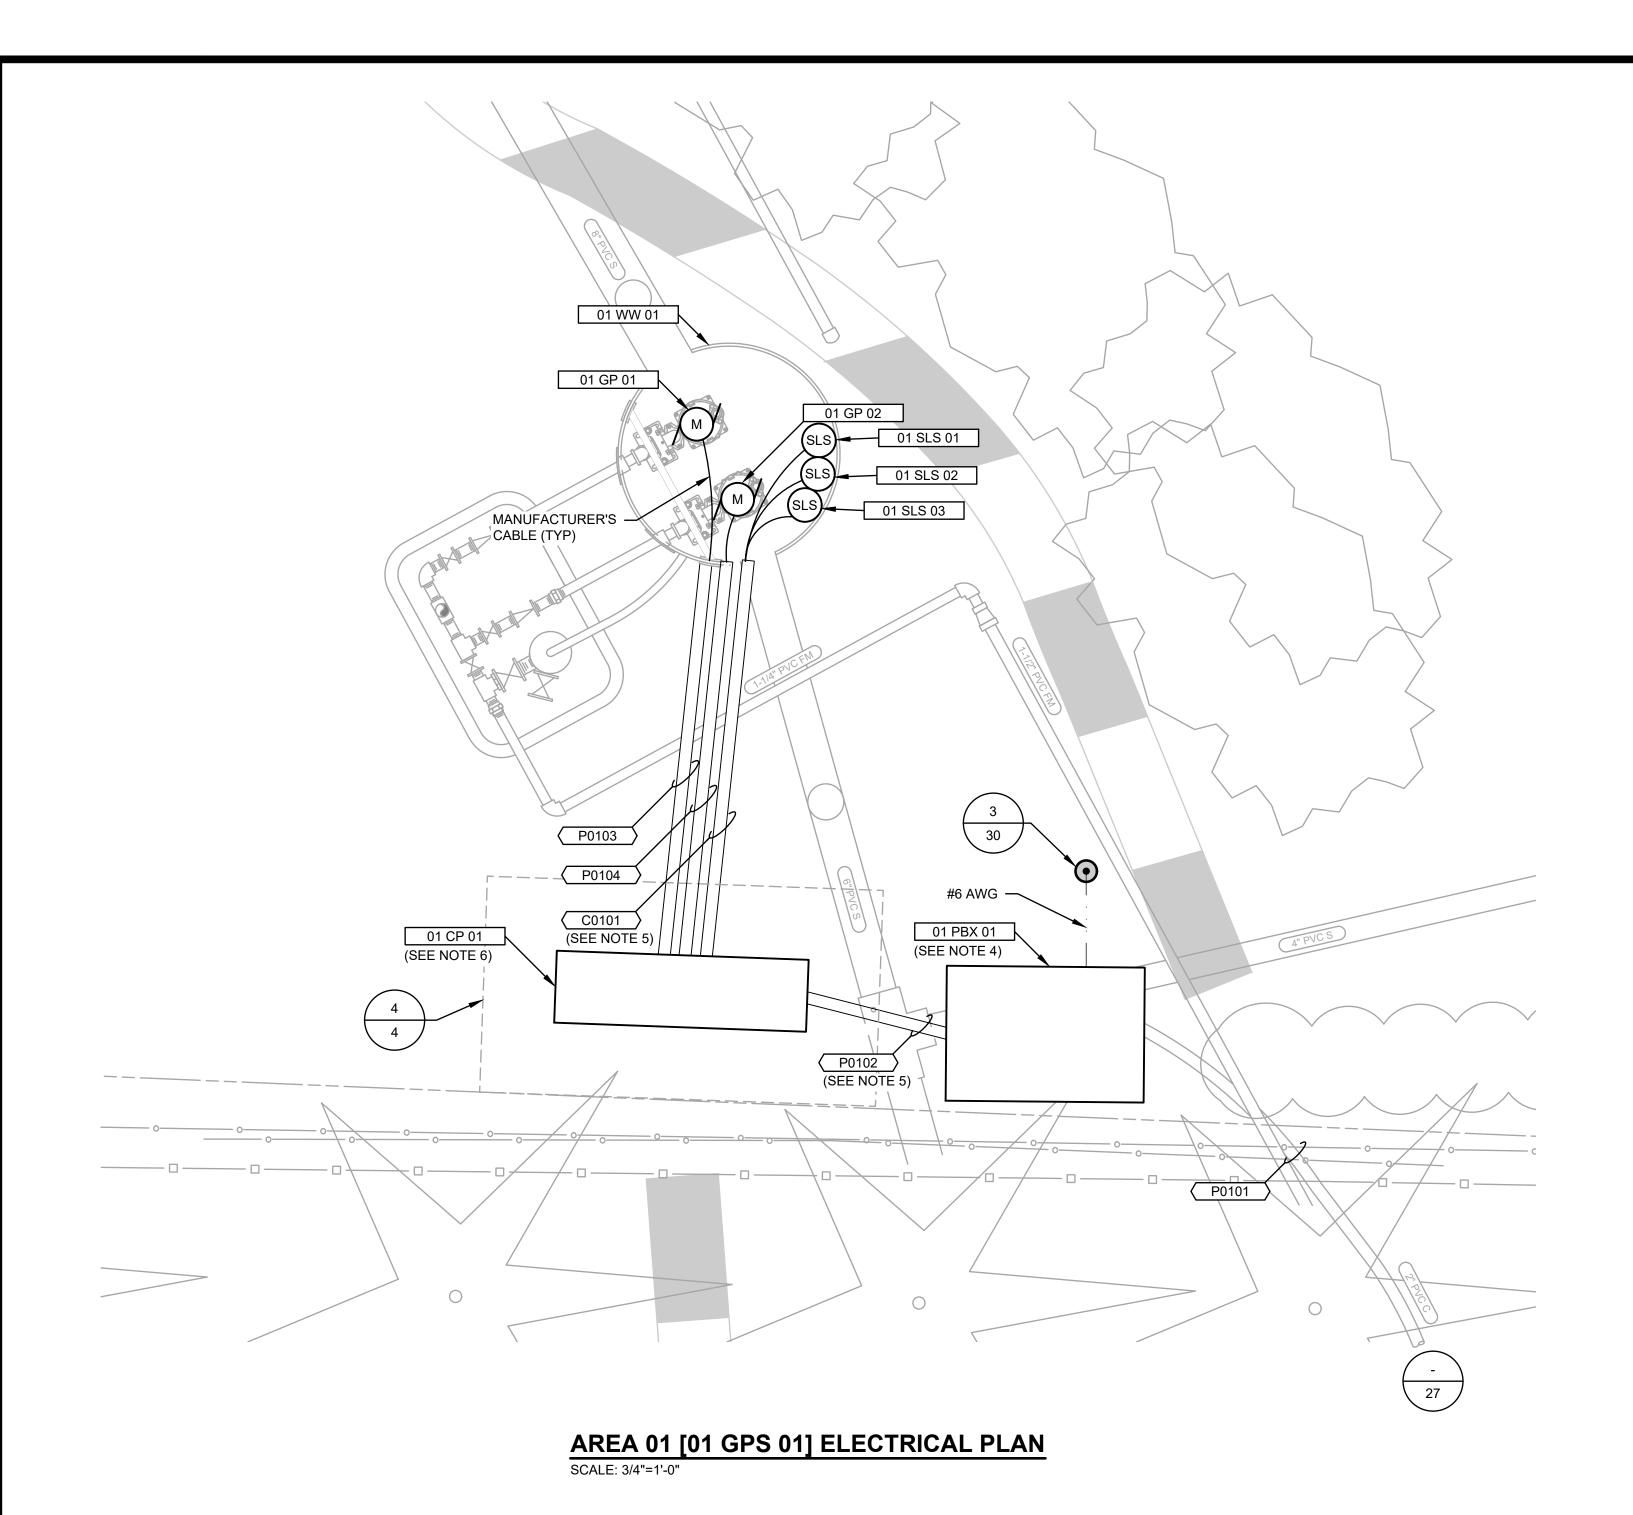



DEVICE TAG LIST						
TAG ID#	TAG ID# TAG DESCRIPTION					
01 CP 01	CONTROL PANEL, GRINDER PUMP STATION NO. 1	NEW				
01 GP 01	GRINDER PUMP NO. 1, GRINDER PUMP STATION NO. 1	NEW				
01 GP 02	GRINDER PUMP NO. 2, GRINDER PUMP STATION NO. 1	NEW				
01 GPS 01	GRINDER PUMP STATION NO. 1	EXISTING				
01 PBX 01	PULL BOX, SOUTH, GRINDER PUMP STATION NO. 1	NEW				
01 SLS 01	LEVEL SWITCH, PUMPS OFF, GRINDER PUMP STATION NO. 1	NEW				
01 SLS 02	LEVEL SWITCH, PUMP ON, GRINDER PUMP STATION NO. 1	NEW				
01 SLS 03	LEVEL SWITCH, HIGH LEVEL, GRINDER PUMP STATION NO. 1	NEW				
01 WW 01	WET WELL, GRINDER PUMP STATION NO. 1	EXISTING				


POWER CABLE AND CONDUIT SCHEDULE									
NUMBER	UMBER SOURCE DESTINATION SIZE CONDUCTORS								
P0101	[02 PBX 02], PULL BOX, NORTH, GRINDER PUMP STATION NO. 2	[01 PBX 01], PULL BOX, SOUTH, GRINDER PUMP STATION NO. 1	EXISTING	3X #1/0 AWG XHHW-2; 1X #3 AWG XHHW-2 G	CONDUCTORS ARE EXISTING				
P0102	[01 PBX 01], PULL BOX, SOUTH, GRINDER PUMP STATION NO. 1	[01 CP 01], CONTROL PANEL, GRINDER PUMP STATION NO. 1	3/4"	3X #8 AWG XHHW-2; 1X #10 AWG XHHW-2 G					
P0103	[01 CP 01], CONTROL PANEL, GRINDER PUMP STATION NO. 1	[01 GP 01], GRINDER PUMP NO. 1, GRINDER PUMP STATION NO. 1	2"	MANUFACTURER'S CABLE					
P0104	[01 CP 01], CONTROL PANEL, GRINDER PUMP STATION NO. 1	[01 GP 02], GRINDER PUMP NO. 2, GRINDER PUMP STATION NO. 1	2"	MANUFACTURER'S CABLE					

	CONTROL CABLE AND CONDUIT SCHEDULE								
NUMBER	SOURCE	DESTINATION	SIZE	CONDUCTORS	E-1 TYPE	NOTES			
C0101	[01 CP 01], CONTROL PANEL, GRINDER PUMP STATION NO. 1	[01 WW 01], WET WELL, GRINDER PUMP STATION NO. 1	2"	MANUFACTURER'S CABLES	* 2	[01 SLS 01], [01 SLS 02], AND [01 SLS 03]			

- 1. ELECTRICAL DEMOLITION IS NOT SHOWN ON THE ELECTRICAL DRAWINGS. SEE MECHANICAL DRAWINGS FOR DEMOLITION. FOR ALL EQUIPMENT THAT IS DEMOLISHED, REMOVE CABLES AND CONDUCTORS IN THEIR ENTIRETY, AND DEMOLISH CONDUIT TO TWO FEET BELOW GRADE, UNLESS NOTED OTHERWISE. BACKFILL TO MATCH SURROUNDINGS.
- 2. NOT ALL EXISTING CONDUITS ARE SHOWN, CONTRACTOR SHALL VERIFY EXISTING CONDUIT ROUTING
- 3. ALL POWER OUTAGES SHALL BE COORDINATED WITH THE OWNER.
- 4. CONTRACTOR SHALL LOCATE THE EXISTING POWER FEEDER AND INSTALL THE PULL BOX TO INTERCEPT. PROTECT THE EXISTING POWER FEEDER AND DEMOLISH THE EXISTING CONDUIT AS NEEDED. ADD CONDUIT ELBOW AND EXTEND CONDUIT INTO THE BOTTOM OF THE PULL BOX. SPLICE THE EXISTING CONDUCTORS TO THE CONDUCTORS IN CONDUIT P0102, USING LUGS THAT ARE RATED FOR DIRECT BURIAL. COORDINATE THE EXACT LOCATION WITH THE OWNER.




- 5. INCLUDE #6 AWG COPPER STRANDED CONDUCTOR IN CONDUIT TRENCH FOR WET WELL GROUNDING.
- 6. INSTALL CONTROL PANEL ON BACKPLATE PER
- PANEL BOARD [15 PB 02] IS LOCATED APPROXIMATELY 1,421 FEET SOUTH INSIDE OF POWER DISTRIBUTION PANEL [15 PDP 01B]. THE GRINDER PUMPS POWER FEEDER IS CONNECTED TO CIRCUITS 8, 10, AND 12. COORDINATE ALL POWER OUTAGES WITH THE OWNER.
- 8. REFERENCE THE SCHEDULE OF CLASSIFIED AREAS ON

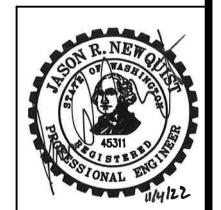

NO	BY	APPD	REVISION	DATE	WARNING
					0 1/2 1
					IF THIS BAR DOES
					NOT MEASURE 1" THEN DRAWING IS NOT TO SCALE



	DESIGNED BY	PAM
	DRAWN BY	PEB
y & Osborne, Inc	CHECKED BY	JRN
CONSULTING ENGINEERS	APPROVAL	JRN
	DATE	NOV 2022

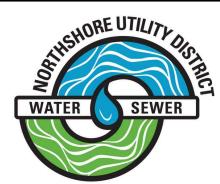

# NORTHSHORE UTILITY DISTRICT

6830 NE 185th St. Kenmore, WA 98028-2684

P.O. Box 82489 Kenmore, WA 98028-2684


Ph: (425) 398-4400 | Fax: (425) 398-4430 | www.nud.net


**CONTRACT 2022-01** GRINDER PUMP STATIONS 1-4 REPLACEMENT

**GRINDER PUMP STATION 1 ELECTRICAL PLAN** 

SHEET
C2003
BASE MAP H4

<u>26</u> of <u>30</u>

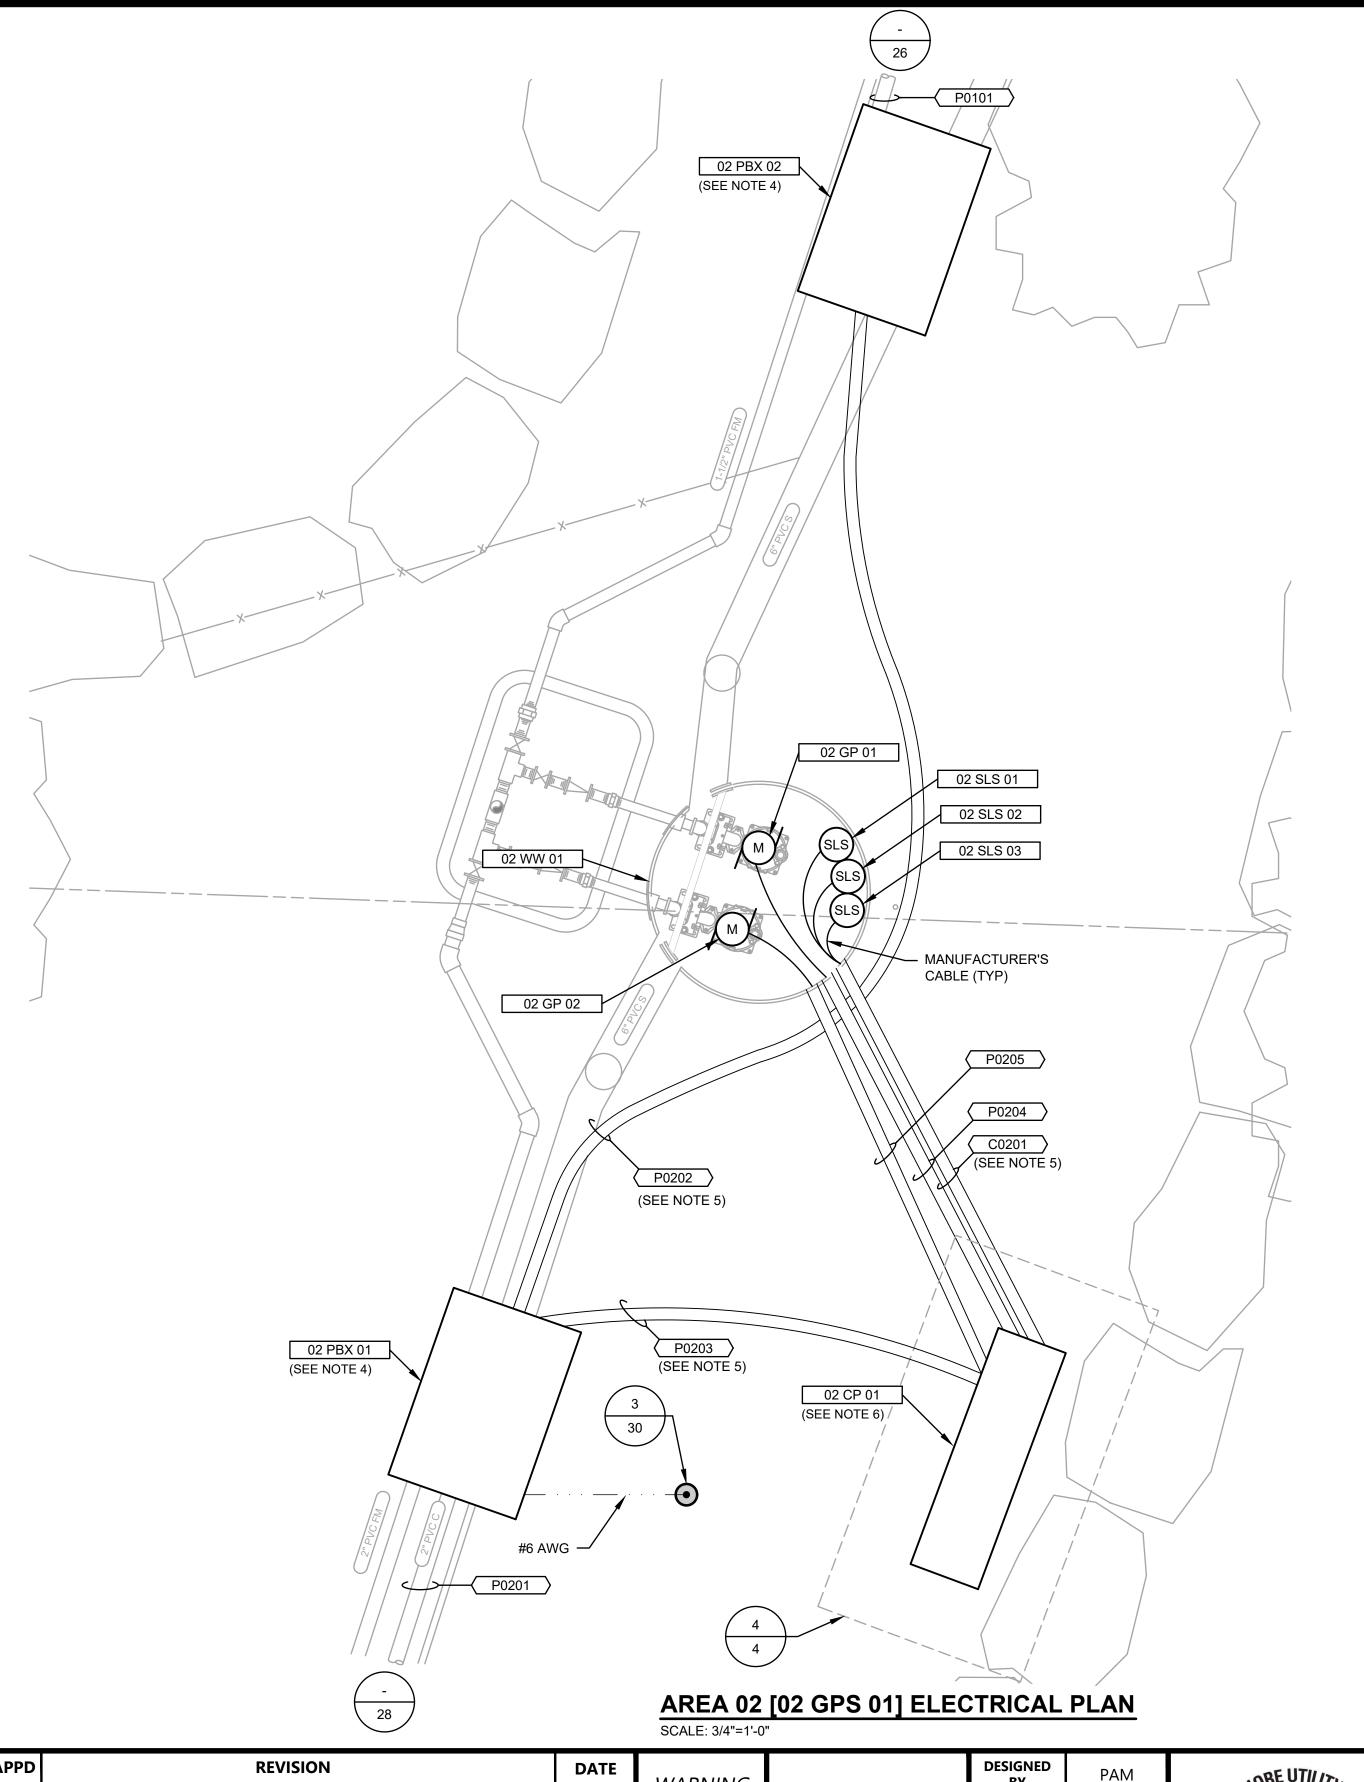

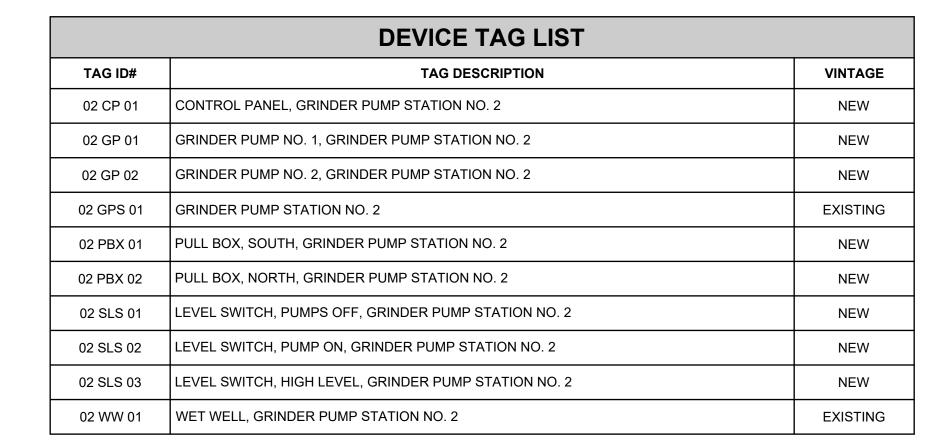

		POWER CABLE AND CONDUI	T SCHEDU	JLE	
NUMBER	SOURCE	DESTINATION	SIZE	CONDUCTORS	NOTES
P0201	[03 PBX 02], PULL BOX, NORTH, GRINDER PUMP STATION NO. 3	[02 PBX 01], PULL BOX, SOUTH, GRINDER PUMP STATION NO. 2	EXISTING	3X #1/0 AWG XHHW-2; 1X #3 AWG XHHW-2 G	CONDUCTORS ARE EXISTING
P0202	[02 PBX 01], PULL BOX, SOUTH, GRINDER PUMP STATION NO. 2	[02 PBX 02], PULL BOX, NORTH, GRINDER PUMP STATION NO. 2	2"	3X #1/0 AWG XHHW-2; 1X #3 AWG XHHW-2 G	
P0203	[02 PBX 01], PULL BOX, SOUTH, GRINDER PUMP STATION NO. 2	[02 CP 01], CONTROL PANEL, GRINDER PUMP STATION NO. 2	3/4"	3X #8 AWG XHHW-2; 1X #10 AWG XHHW-2 G	
P0204	[02 CP 01], CONTROL PANEL, GRINDER PUMP STATION NO. 2	[02 GP 01], GRINDER PUMP NO. 1, GRINDER PUMP STATION NO. 2	2"	MANUFACTURER'S CABLE	
P0205	[02 CP 01], CONTROL PANEL, GRINDER PUMP STATION NO. 2	[02 GP 02], GRINDER PUMP NO. 2, GRINDER PUMP STATION NO. 2	2"	MANUFACTURER'S CABLE	

		CONTROL CABLE AND COND	CONTROL CABLE AND CONDUIT SCHEDULE			
NUMBER	SOURCE	DESTINATION	SIZE	CONDUCTORS	E-1 TYPE	NOTES
C0201	[02 CP 01], CONTROL PANEL, GRINDER PUMP STATION NO. 2	[02 WW 01], WET WELL, GRINDER PUMP STATION NO. 2	2"	MANUFACTURER'S CABLES	* 2	[02 SLS 01], [02 SLS 02], AND [02 SLS 03]

- 1. ELECTRICAL DEMOLITION IS NOT SHOWN ON THE ELECTRICAL DRAWINGS. SEE MECHANICAL DRAWINGS FOR DEMOLITION. FOR ALL EQUIPMENT THAT IS DEMOLISHED REMOVE CABLES AND CONDUCTORS IN THEIR ENTIRETY, AND DEMOLISH CONDUIT TO TWO FEET BELOW GRADE, UNLESS NOTED OTHERWISE. BACKFILL TO MATCH SURROUNDINGS.
- 2. NOT ALL EXISTING CONDUITS ARE SHOWN, CONTRACTOR SHALL VERIFY EXISTING CONDUIT ROUTING
- 3. ALL POWER OUTAGES SHALL BE COORDINATED WITH THE OWNER.
- 4. CONTRACTOR SHALL LOCATE THE EXISTING POWER FEEDER AND INSTALL THE PULL BOXES TO INTERCEPT. PROTECT THE EXISTING POWER FEEDER AND DEMOLISH THE EXISTING CONDUIT AS NEEDED. ADD CONDUIT ELBOWS AND EXTEND CONDUIT INTO THE BOTTOM OF THE PULL BOXES. SPLICE THE EXISTING CONDUCTORS TO THE CONDUCTORS IN CONDUIT P0202, AND IN [02 PBX 01], TO THE CONDUCTORS IN P0203 ALSO, USING LUGS THAT ARE RATED FOR DIRECT BURIAL. COORDINATE THE EXACT LOCATION WITH THE OWNER.



- 5. INCLUDE #6 AWG COPPER STRANDED CONDUCTOR IN CONDUIT TRENCH FOR WET WELL GROUNDING.
- 6. INSTALL CONTROL PANEL ON BACKPLATE PER
- 7. PANEL BOARD [15 PB 02] IS LOCATED APPROXIMATELY 1,136 FEET SOUTH INSIDE OF POWER DISTRIBUTION PANEL [15 PDP 01B]. THE GRINDER PUMPS POWER FEEDER IS CONNECTED TO CIRCUITS 8, 10, AND 12. COORDINATE ALL POWER OUTAGES WITH THE OWNER.
- 8. REFERENCE THE SCHEDULE OF CLASSIFIED AREAS ON



NO	ВҮ	APPD	REVISION	DATE	WARNING
					0 % 1
					IF THIS BAR DOES
					NOT MEASURE 1" THEN DRAWING
				_	IS NOT TO SCALE



	DESIGNED BY	PAM
	DRAWN BY	PEB
ray & Osborne, Inc	CHECKED BY	JRN
CONSULTING ENGINEERS	APPROVAL	JRN
	DATE	NOV 20



# **NORTHSHORE UTILITY DISTRICT**

6830 NE 185th St. Kenmore, WA 98028-2684 P.O. Box 82489 Kenmore, WA 98028-2684


Ph: (425) 398-4400 | Fax: (425) 398-4430 | www.nud.net

**CONTRACT 2022-01** GRINDER PUMP STATIONS 1-4 REPLACEMENT

**GRINDER PUMP STATION 2 ELECTRICAL PLAN** 

BASE MAP H4
C2003

SHEET <u>27</u> of <u>30</u>

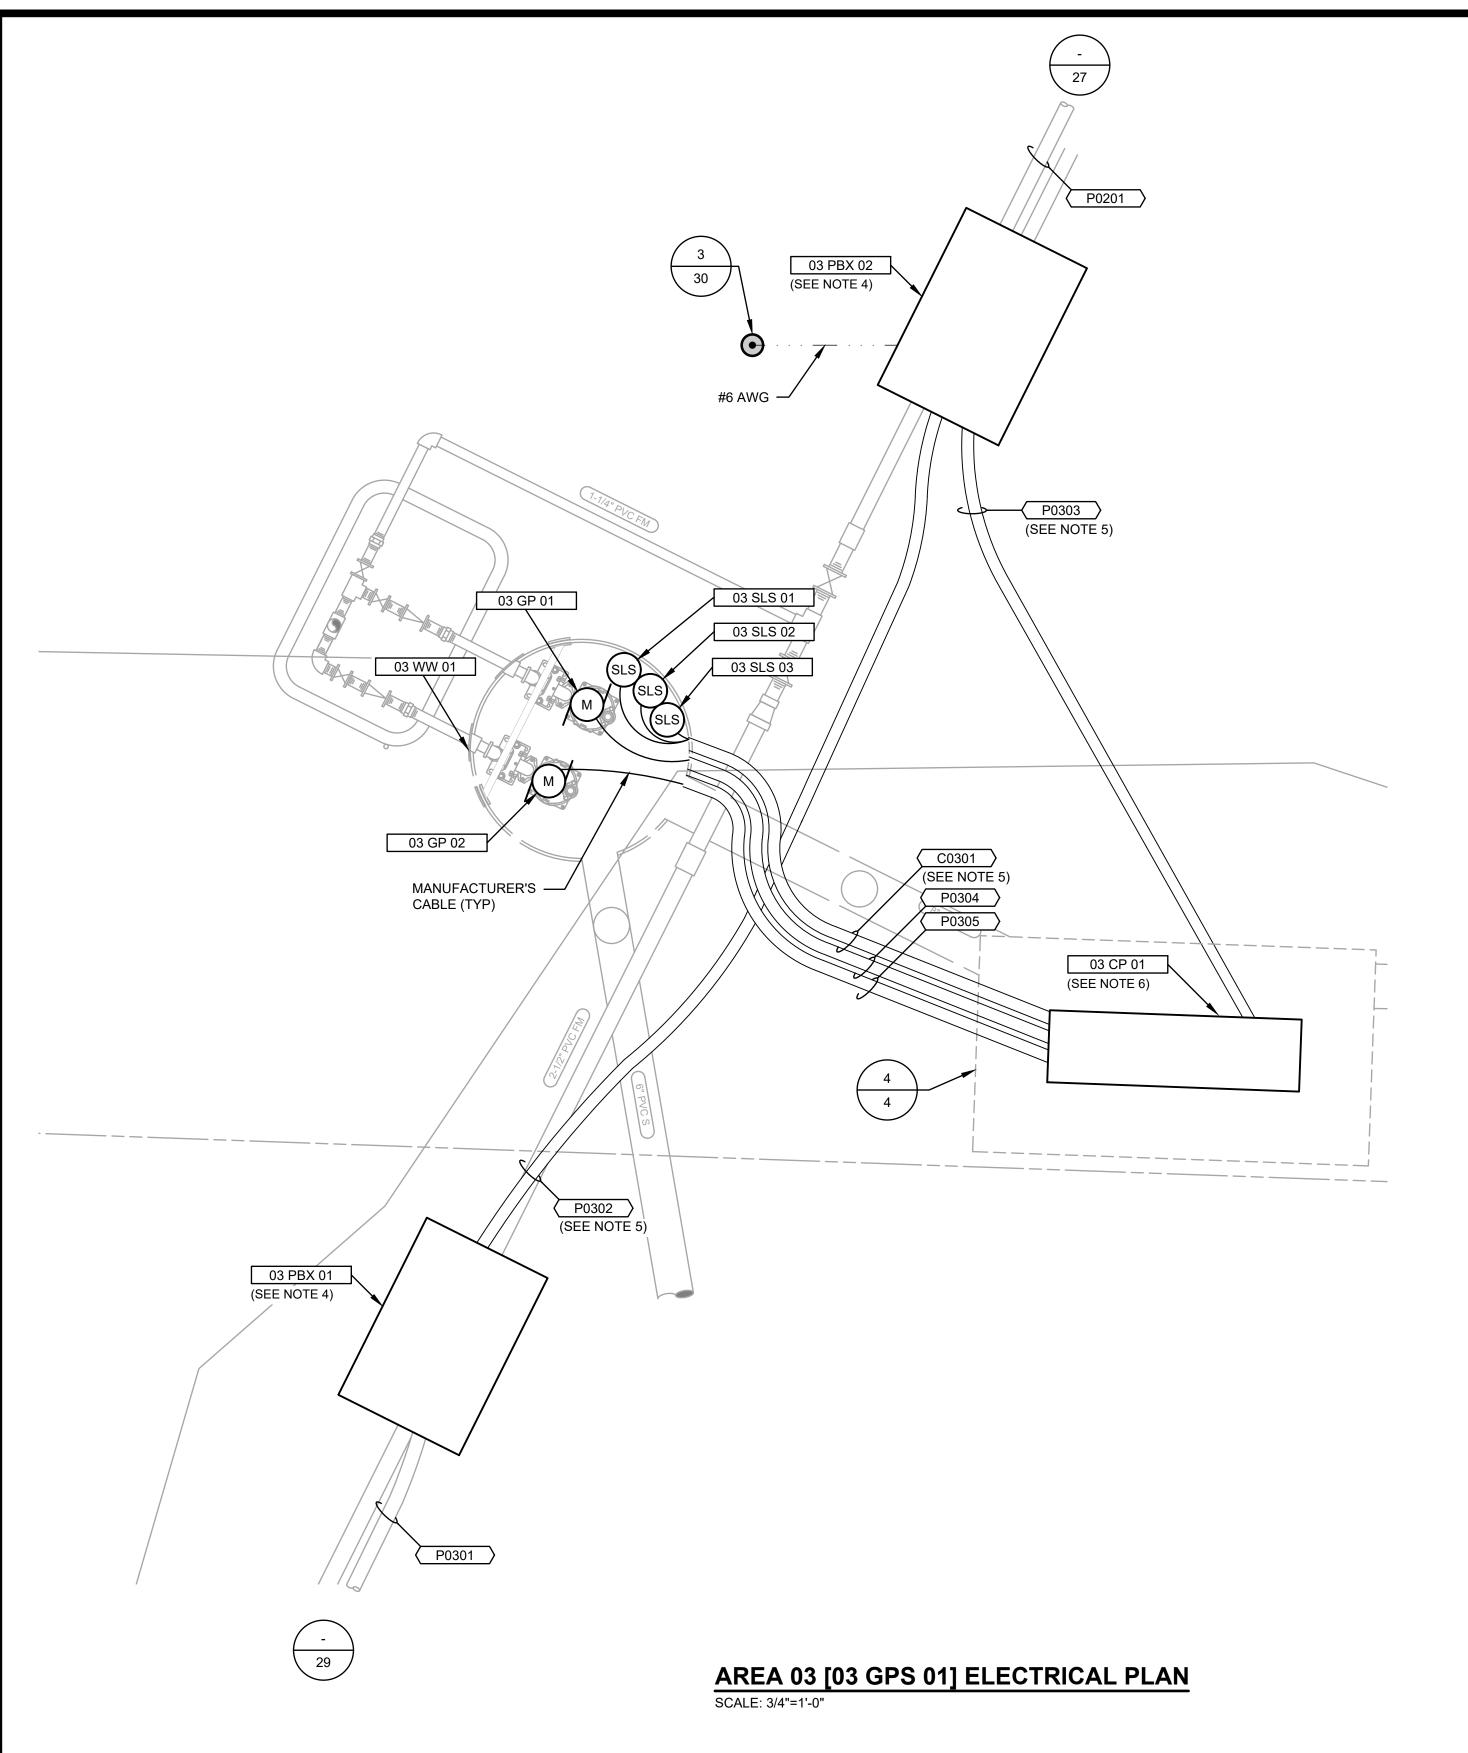

	DEVICE TAG LIST	
TAG ID#	TAG DESCRIPTION	VINTAGE
03 CP 01	CONTROL PANEL, GRINDER PUMP STATION NO. 3	NEW
03 GP 01	GRINDER PUMP NO. 1, GRINDER PUMP STATION NO. 3	NEW
03 GP 02	GRINDER PUMP NO. 2, GRINDER PUMP STATION NO. 3	NEW
03 GPS 01	GRINDER PUMP STATION NO. 3	EXISTING
03 PBX 01	PULL BOX, SOUTH, GRINDER PUMP STATION NO. 3	NEW
03 PBX 02	PULL BOX, NORTH, GRINDER PUMP STATION NO. 3	NEW
03 SLS 01	LEVEL SWITCH, PUMPS OFF, GRINDER PUMP STATION NO. 3	NEW
03 SLS 02	LEVEL SWITCH, PUMP ON, GRINDER PUMP STATION NO. 3	NEW
03 SLS 03	LEVEL SWITCH, HIGH LEVEL, GRINDER PUMP STATION NO. 3	NEW
03 WW 01	WET WELL, GRINDER PUMP STATION NO. 3	EXISTING

		POWER CABLE AND CONDUIT	T SCHEDU	JLE	
NUMBER	SOURCE	DESTINATION	SIZE	CONDUCTORS	NOTES
P0301	[04 PBX 02], PULL BOX, NORTH, GRINDER PUMP STATION NO. 4	[03 PBX 01], PULL BOX, SOUTH, GRINDER PUMP STATION NO. 3	EXISTING	3X #1/0 AWG XHHW-2; 1X #3 AWG XHHW-2 G	CONDUCTORS ARE EXISTING
P0302	[03 PBX 01], PULL BOX, SOUTH, GRINDER PUMP STATION NO. 3	[03 PBX 02], PULL BOX, NORTH, GRINDER PUMP STATION NO. 3	2"	3X #1/0 AWG XHHW-2; 1X #3 AWG XHHW-2 G	
P0303	[03 PBX 02], PULL BOX, NORTH, GRINDER PUMP STATION NO. 3	[03 CP 01], CONTROL PANEL, GRINDER PUMP STATION NO. 3	3/4"	3X #8 AWG XHHW-2; 1X #10 AWG XHHW-2 G	
P0304	[03 CP 01], CONTROL PANEL, GRINDER PUMP STATION NO. 3	[03 GP 01], GRINDER PUMP NO. 1, GRINDER PUMP STATION NO. 3	2"	MANUFACTURER'S CABLE	
P0305	[03 CP 01], CONTROL PANEL, GRINDER PUMP STATION NO. 3	[03 GP 02], GRINDER PUMP NO. 2, GRINDER PUMP STATION NO. 3	2"	MANUFACTURER'S CABLE	

	CONTROL CABLE AND CONDUIT SCHEDULE					
NUMBER	SOURCE	DESTINATION	SIZE	CONDUCTORS	E-1 TYPE	NOTES
C0301	[03 CP 01], CONTROL PANEL, GRINDER PUMP STATION NO. 3	[03 WW 01], WET WELL, GRINDER PUMP STATION NO. 3	2"	MANUFACTURER'S CABLES	* 2	[03 SLS 01], [03 SLS 02], AND [03 SLS 03]

- 1. ELECTRICAL DEMOLITION IS NOT SHOWN ON THE ELECTRICAL DRAWINGS. SEE MECHANICAL DRAWINGS FOR DEMOLITION. FOR ALL EQUIPMENT THAT IS DEMOLISHED, REMOVE CABLES AND CONDUCTORS IN THEIR ENTIRETY, AND DEMOLISH CONDUIT TO TWO FEET BELOW GRADE, UNLESS NOTED OTHERWISE. BACKFILL TO MATCH SURROUNDINGS.
- 2. NOT ALL EXISTING CONDUITS ARE SHOWN, CONTRACTOR SHALL VERIFY EXISTING CONDUIT ROUTING
- 3. ALL POWER OUTAGES SHALL BE COORDINATED WITH THE OWNER.
- 4. CONTRACTOR SHALL LOCATE THE EXISTING POWER FEEDER AND INSTALL THE PULL BOXES TO INTERCEPT. PROTECT THE EXISTING POWER FEEDER AND DEMOLISH THE EXISTING CONDUIT AS NEEDED. ADD CONDUIT ELBOWS AND EXTEND CONDUIT INTO THE BOTTOM OF THE PULL BOXES. SPLICE THE EXISTING CONDUCTORS TO THE CONDUCTORS IN CONDUIT P0302 AND, IN [03 PBX 02], TO THE CONDUCTORS IN P0303 ALSO, USING LUGS THAT ARE RATED FOR DIRECT BURIAL. COORDINATE THE EXACT LOCATION WITH THE OWNER.




- 5. INCLUDE #6 AWG COPPER STRANDED CONDUCTOR IN CONDUIT TRENCH FOR WET WELL GROUNDING.
- 6. INSTALL CONTROL PANEL ON BACKPLATE PER



- 7. PANEL BOARD [15 PB 02] IS LOCATED APPROXIMATELY 863 FEET SOUTH INSIDE OF POWER DISTRIBUTION PANEL [15 PDP 01B]. THE GRINDER PUMPS POWER FEEDER IS CONNECTED TO CIRCUITS 8, 10, AND 12. COORDINATE ALL POWER OUTAGES WITH THE OWNER.
- 8. REFERENCE THE SCHEDULE OF CLASSIFIED AREAS ON



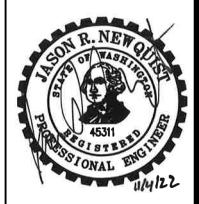

NO	BY	APPD	REVISION	DATE	WARNING
					VVARIVING  0 % 1
					IF THIS BAR DOES
					NOT MEASURE 1" THEN DRAWING
		•			IS NOT TO SCALE

1	
1	
ĺ	
]	C = 0.01
	Gray & Osborne, Inc
S	CONSULTING ENGINEERS
S I"	

	DESIGNED BY	F
	DRAWN BY	
r <u>ay &amp; Osborne,</u> Inc	CHECKED BY	
CONSULTING ENGINEERS	APPROVAL	
	DATE	NO



# NORTHSHORE UTILITY DISTRICT

6830 NE 185th St. Kenmore, WA 98028-2684

P.O. Box 82489 Kenmore, WA 98028-2684


Ph: (425) 398-4400 | Fax: (425) 398-4430 | www.nud.net


CONTRACT 2022-01 GRINDER PUMP STATIONS 1-4 REPLACEMENT

**GRINDER PUMP STATION 3 ELECTRICAL PLAN** 

В	ASE MAP H4	
	C2003	

SHEET <u>28</u> of <u>30</u>

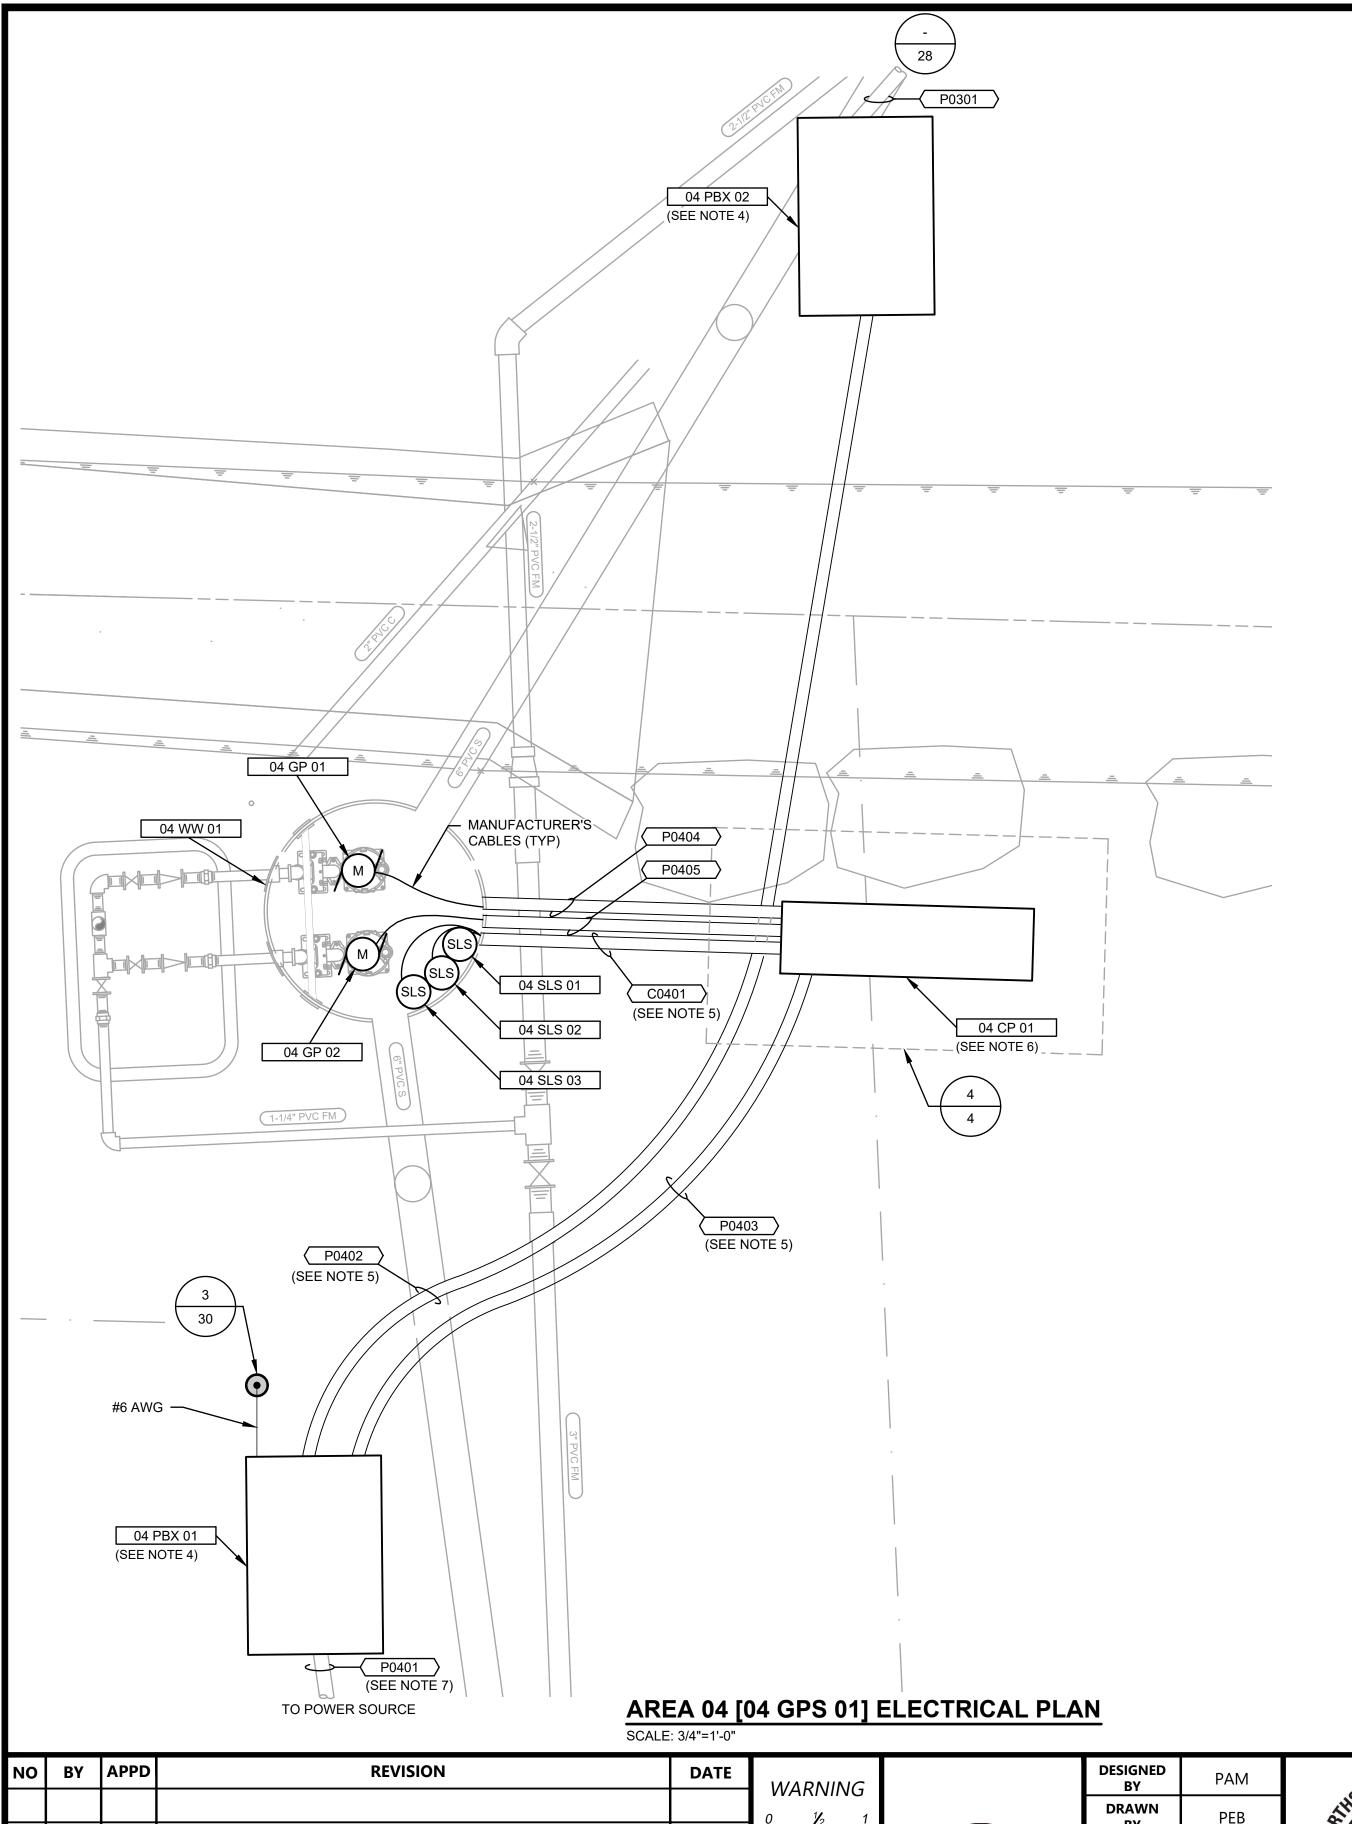

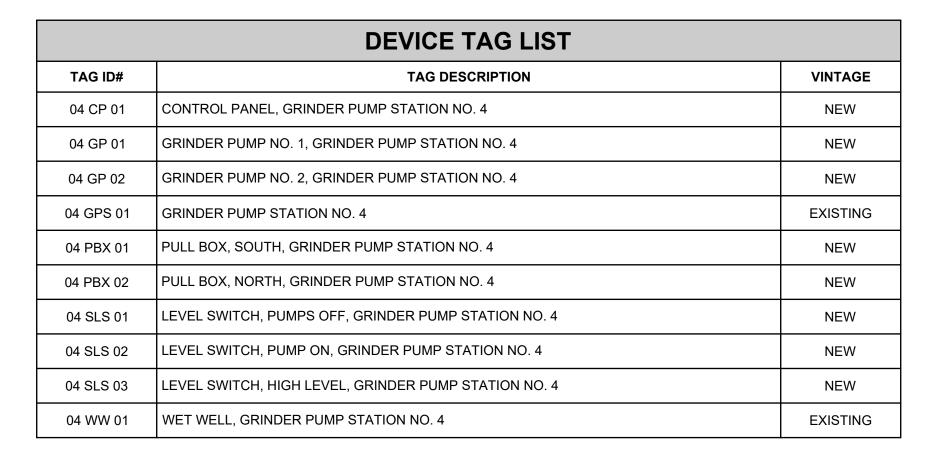

	DEVICE TAG LIST	
TAG ID#	TAG DESCRIPTION	VINTAGE
15 LS 01	LIFT STATION NO. 15	EXISTING
15 PB 02	PANELBOARD, 240/120V, LIFT STATION NO. 15 POWER DISTRIBUTION PANEL	EXISTING
15 PDP 01B	POWER DISTRIBUTION PANEL, LIFT STATION NO. 15	EXISTING


	POWER CABLE AND CONDUIT SCHEDULE					
NUMBER	SOURCE	DESTINATION	SIZE	CONDUCTORS	NOTES	
P0401	[15 PB 02], PANELBOARD, 240/120V, LIFT STATION NO. 15 POWER DISTRIBUTION PANEL	[04 PBX 01], PULL BOX, SOUTH, GRINDER PUMP STATION NO. 4	EXISTING	3X #1/0 AWG XHHW-2; 1X #3 AWG XHHW-2 G	CONDUCTORS ARE EXISTING.	
P0402	[04 PBX 01], PULL BOX, SOUTH, GRINDER PUMP STATION NO. 4	[04 PBX 02], PULL BOX, NORTH, GRINDER PUMP STATION NO. 4	2"	3X #1/0 AWG XHHW-2; 1X #3 AWG XHHW-2 G		
P0403	[04 PBX 01], PULL BOX, SOUTH, GRINDER PUMP STATION NO. 4	[04 CP 01], CONTROL PANEL, GRINDER PUMP STATION NO. 4	3/4"	3X #8 AWG XHHW-2; 1X #10 AWG XHHW-2 G		
P0404	[04 CP 01], CONTROL PANEL, GRINDER PUMP STATION NO. 4	[04 GP 01], GRINDER PUMP NO. 1, GRINDER PUMP STATION NO. 4	2"	MANUFACTURER'S CABLES		
P0405	[04 CP 01], CONTROL PANEL, GRINDER PUMP STATION NO. 4	[04 GP 02], GRINDER PUMP NO. 2, GRINDER PUMP STATION NO. 4	2"	MANUFACTURER'S CABLES		

	CONTROL CABLE AND CONDUIT SCHEDULE					
NUMBER	SOURCE	DESTINATION	SIZE	CONDUCTORS	E-1 TYPE	NOTES
C0401	[04 CP 01], CONTROL PANEL, GRINDER PUMP STATION NO. 4	[04 WW 01], WET WELL, GRINDER PUMP STATION NO. 4	2"	MANUFACTURER'S CABLES	* 2	[04 SLS 01], [04 SLS 02], AND [04 SLS 03]


- ELECTRICAL DEMOLITION IS NOT SHOWN ON THE ELECTRICAL DRAWINGS. SEE MECHANICAL DRAWINGS FOR DEMOLITION. FOR ALL EQUIPMENT THAT IS DEMOLISHED, REMOVE CABLES AND CONDUCTORS IN THEIR ENTIRETY, AND DEMOLISH CONDUIT TO TWO FEET BELOW GRADE, UNLESS NOTED OTHERWISE. BACKFILL TO MATCH SURROUNDINGS.
- 2. NOT ALL EXISTING CONDUITS ARE SHOWN, CONTRACTOR SHALL VERIFY EXISTING CONDUIT ROUTING AS NEEDED.
- 3. ALL POWER OUTAGES SHALL BE COORDINATED WITH THE OWNER.
- 4. CONTRACTOR SHALL LOCATE THE EXISTING POWER FEEDER AND INSTALL THE PULL BOXES TO INTERCEPT. PROTECT THE EXISTING POWER FEEDER AND DEMOLISH THE EXISTING CONDUIT AS NEEDED. ADD CONDUIT ELBOWS AND EXTEND CONDUIT INTO THE BOTTOM OF THE PULL BOXES. SPLICE THE EXISTING CONDUCTORS TO THE CONDUCTORS IN CONDUIT P0402 AND, IN [04 PBX 01,] TO THE CONDUCTORS IN P0403 ALSO, USING LUGS THAT ARE RATED FOR DIRECT BURIAL. COORDINATE THE EXACT LOCATION WITH THE OWNER.



- 5. INCLUDE #6 AWG COPPER STRANDED CONDUCTOR IN CONDUIT TRENCH FOR WET WELL GROUNDING.
- 6. INSTALL CONTROL PANEL ON BACKPLATE PER  $\begin{pmatrix} 1 \\ 30 \end{pmatrix}$
- 7. PANEL BOARD [15 PB 02] IS LOCATED APPROXIMATELY 650 FEET SOUTH INSIDE OF POWER DISTRIBUTION PANEL [15 PDP 01B]. THE GRINDER PUMPS POWER FEEDER IS CONNECTED TO CIRCUITS 8, 10, AND 12. COORDINATE ALL POWER OUTAGES WITH THE OWNER.
- 8. REFERENCE THE SCHEDULE OF CLASSIFIED AREAS ON 30
- 9. LIFT STATION NO. 15 DEVICE TAGS ARE SHOWN FOR REFERENCE ONLY.

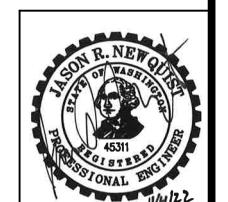

NO	ВҮ	APPD	REVISION	DATE	WARNING		DESIGNED BY	PAM
					0 ½ 1	Gray & Osborne, Inc. CONSULTING ENGINEERS  URE 1"	DRAWN BY	PEB
					IF THIS DAD DOES		CHECKED BY	JRN
					IF THIS BAR DOES NOT MEASURE 1" THEN DRAWING		APPROVAL	JRN
					IS NOT TO SCALE		DATE	NOV 2022

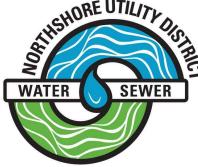

# NORTHSHORE UTILITY DISTRICT

6830 NE 185th St. P.O. Box 82489 Kenmore, WA 98028-2684 Kenmore, WA 98028-2684


Ph: (425) 398-4400 | Fax: (425) 398-4430 | www.nud.net


CONTRACT 2022-01
GRINDER PUMP STATIONS 1-4 REPLACEMENT

GRINDER PUMP STATION 4
ELECTRICAL PLAN

SHEET
C2003
BASE MAP H4

<u>29</u> of <u>30</u>

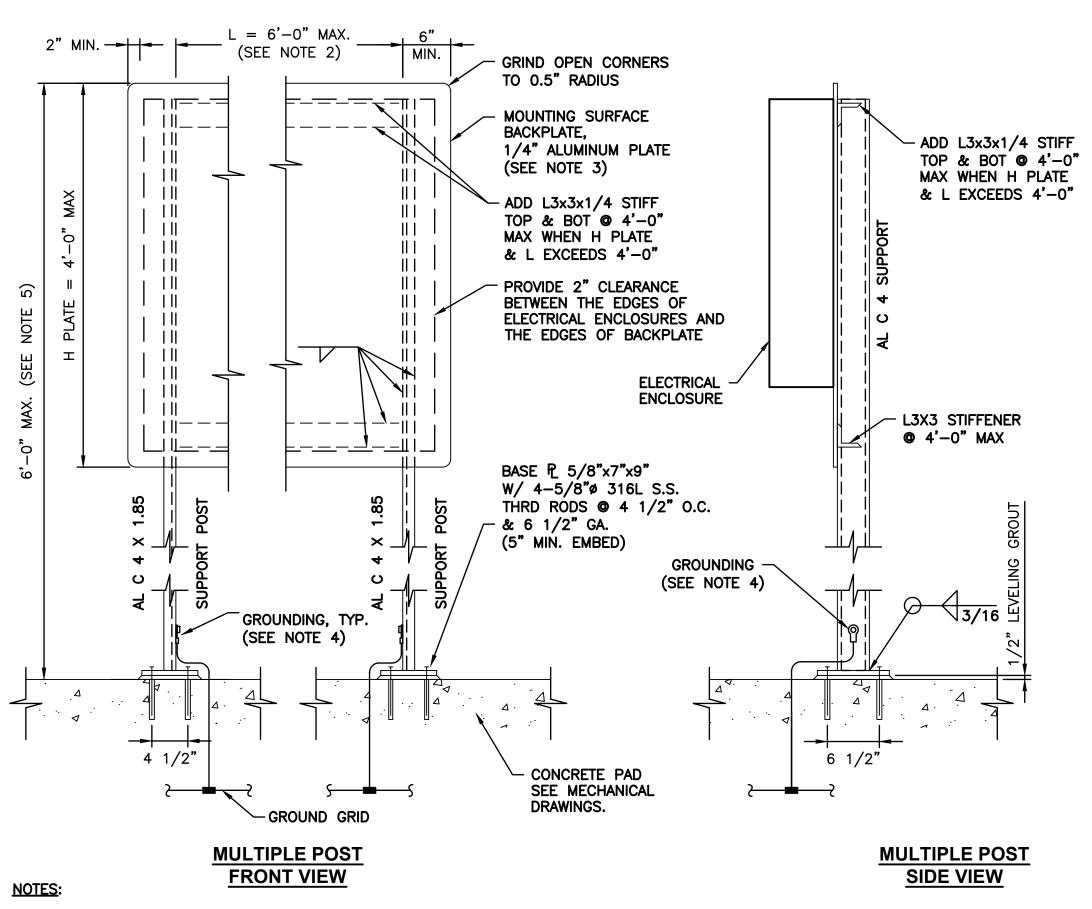


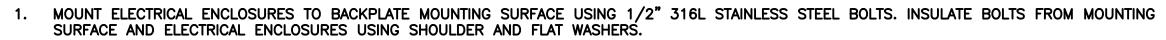

- 2. WIDTH AND HEIGHT OF THE BACKPLATE AND THE SPACING BETWEEN SUPPORT POSTS ARE DEPENDENT ON THE SPECIFIC APPLICATION. SUPPORT POSTS SHALL NOT EXCEED 6'-0". FOR WIDER BACKPLATES, PROVIDE ADDITIONAL EQUAL SPACED SUPPORT POST.
- 3. ALUMINUM PLATES SHALL COMPLY WITH ASTM B209, ALLOY 5052. ALUMINUM BARS AND RODS SHALL COMPLY WITH ASTM B221, ALLOY 6061-6.
- 4. GROUND BACKPLATE SUPPORT STRUCTURE WITH A BARE COPPER GROUNDING ELECTRODE CONDUCTOR THE SAME SIZE AS THE GROUND GRID CONDUCTORS AT THE EQUIPMENT LOCATION. CONNECTION POINT SHALL BE MADE NO MORE THAN 6" ABOVE THE PAD.
- 5. COORDINATE HEIGHT WITH THE OWNER.




SCHEDULE OF CLASSIFIED AREAS				
LOCATION	CLASSIFICATION	EXTENT OF ENVELOPE		
WET WELL	CLASS I, DIVISION 1	WITHIN THE WET WELL AND WITHIN A 3-FOOT RADIUS FROM THE HATCH OPENING.		
WET WELL	CLASS I, DIVISION 2	WITHIN A 5-FOOT RADIUS FROM THE HATCH OPENING.		

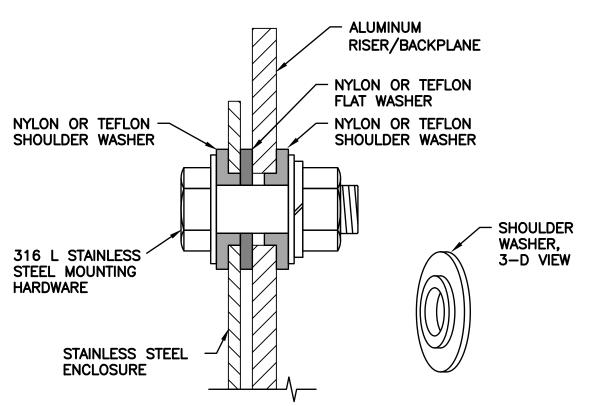


PROVIDE TEFLON OR NYLON SHOULDER WASHERS BETWEEN STAINLESS STEEL MOUNTING HARDWARE AND STRUCTURES/ENCLOSURES. SEPARATE STAINLESS STEEL ENCLOSURES FROM ALUMINUM RISERS OR BACKPLANES WITH A FLAT TEFLON OR NYLON WASHER AS SHOWN.



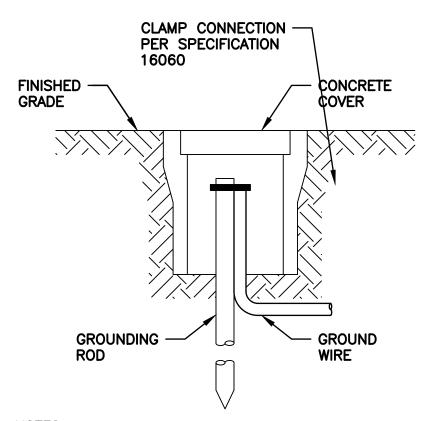


GROUND ROD BOX SHALL BE FOGTITE GROUND ROD BOX WITH ROAD RATING EQUAL TO THE DEVICE OR STRUCTURE IT SUPPORTS (H20 MINIMUM).



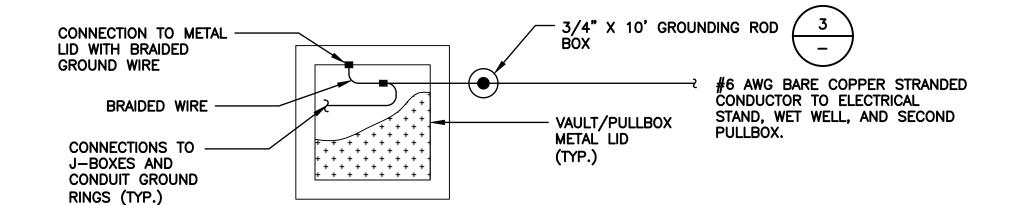

- 1. GROUND CONDUCTOR SHALL BE BARE COPPER STRANDED #6 AWG.
- GROUND ALL METAL COMPONENTS AS PER "VAULT AND PULLBOX GROUNDING" IN SPECIFICATION 16060.
- ALL GROUND CONDUCTORS SHALL BE STRANDED WITH THE EXCEPTION OF THE FLEXIBLE BRAIDED GROUND CONDUCTOR TO THE METAL HATCH LIDS.



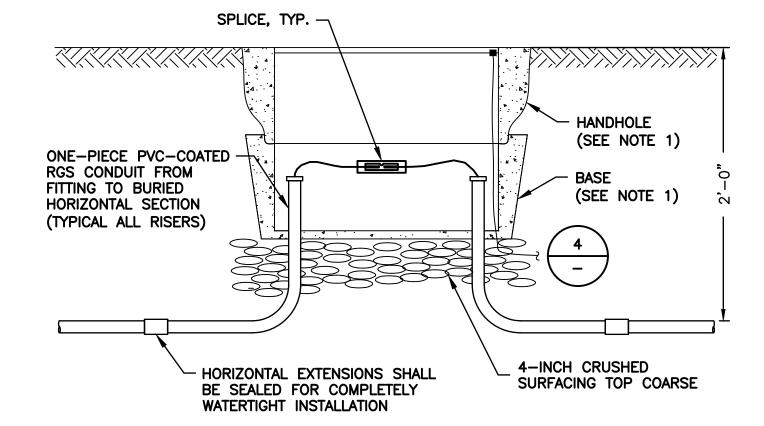

#### **NOTES:**

FOGTITE INC. J-11 TYPE 2 NON-SKID HANDHOLE WITH BONDING STRAP, GALVANIZED STEEL LID, RATED H-20 LOADING, WITH POSITIVE LOCK, AND WITH MATCHING BASE. FURNISH AND INSTALL PULL BOX ASSEMBLY ON TOP OF 4-INCH THICK CRUSHED SURFACING TOP COURSE. PROVIDE LID WITH "POWER" LEGEND.



		SCHEDULE OF CLASSIFIED AREAS
LOCATION	CLASSIFICATION	EXTENT OF ENVELOPE
WET WELL	CLASS I, DIVISION 1	WITHIN THE WET WELL AND WITHIN A 3-FOOT RADIUS FROM THE HATCH OPENING.
WET WELL	CLASS I, DIVISION 2	WITHIN A 5-FOOT RADIUS FROM THE HATCH OPENING.



10	BY	APPD	REVISION	DATE	WARNING
					0 1/2 1
					IF THIS BAR DOES

THEN DRAWING IS NOT TO SCALE

Gray & Osborne, In



# **NORTHSHORE UTILITY DISTRICT**

6830 NE 185th St. Kenmore, WA 98028-2684

P.O. Box 82489 Kenmore, WA 98028-2684

Ph: (425) 398-4400 | Fax: (425) 398-4430 | www.nud.net

**CONTRACT 2022-01** GRINDER PUMP STATIONS 1-4 REPLACEMENT

**ELECTRICAL DETAILS** 

BASE MAP H
C2003

<u>30</u> of <u>30</u>

SHEET